

Harrell+Company Architects  
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 Fairfax Virginia 22030  
 tel 703.352.4141  
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Building  
**Tyson's Edge**

901 Follin Lane SE  
 Vienna Virginia 22180

Owner



10801 Lockwood Drive Suite 370  
 Silver Spring Maryland 20901

Project

**Main Entrance Canopy**

# Main Entrance Canopy

## 901 Follin Lane

### Vienna Virginia 22180

#### ABBREVIATIONS

AFF ABOVE FINISHED FLOOR	L LENGTH	EA EACH	QTY QUANTITY
AC ACCIDENTAL	LAM LAMINATE	ENC ELECTRICAL	QT QUARRY TILE
AC T ACCIDENTAL TILE	LAV LAVATORY	ELEV ELEVATION	RAO RADIUS
ADU ADJUSTABLE	LH LEFT HAND	ENCLOSURE	REF REFER, REFERENCE
ARE AIR CONDITIONING	LF LIGHT	EQ EQUAL	REIN REINFORCED
AL ALTERNATE	LF LINEAR FEET	EQP EQUIPMENT	REQ REQUIRED
ALUM ALUMINUM	LP LONG	ESC ESCALATOR	RET RETURN AIR
AND AND	LVR LOW POINT	EXH EXHAUST	REV REVERSE, REVISION
APPROX APPROXIMATE	MFR MANUFACTURER	EXIST EXISTING	ROB ROUGH OPENING
ARCH ARCHITECT	MAX MAXIMUM	EXPB EXPANSION BOLT	RUB RUBBER
ASSY ASSEMBLY	MCH MECHANICAL	EJ EXPANSION JOINT	RB RESILIENT BASE
AUTO AUTOMATIC	MET METAL	EXT EXTERIOR	RT RESILIENT TILE
AVE AVERAGE	MEZ MEZZANINE	FAB FABRIC	SCHED SCHEDULE
BM BEAM	MIL MIL WORK	FABRI FABRIC PANEL	SECT SECTION
BET BETWEEN	MISC MISCELLANEOUS	FIN FINISH	SECT SERVICE SINK
BLOC BUILDING	MOLD MOLDING	F/F FACE TO FACE	SC SOLID CORE
BD BOARD	MULL MULLION	FIN FLOOR	SM SIMILAR
BLDG BUILDING	MIR MIRROR	F.A. FIRE ALARM	SPC SPECIFICATION
BTM BOTTOM	NORTH	F.E. FIRE EXTINGUISHER	SD SQUARE
BSMT BASEMENT	NOM NOMINAL	FEC FIRE EXTINGUISHER CABINET	SS STAINLESS STEEL
BRZ BRONZE	NOT NOT TO SCALE	FD FIRE HOSE CABINET	STD STANDARD
BULL BULLETIN	NO NUMBER	FL FLOOR	STRUC STRUCTURAL
CAB CABINET	OC ON-CENTER	FL DRN FLOOR DRAIN	SUSP SUSPENDED
CARP CARPET	OPNG OPENING	FL MTS FLOOR MOUNTED	TK BD TACKBOARD
CEG CEILING	OPP OPPOSITE	FT FOOT	TEL TELEPHONE
CEM CEMENT	OP H OPPOSITE HAND	PWC FABRIC WALL COVERING	THR THICK
CH CENTER	OS OUTSIDE DIAMETER	GA GAUGE	THR THRESHOLD
CL CENTERLINE	OV OVERALL	GC GENERAL CONTRACTOR	TR TREAD
CT CERAMIC TILE	OH OVERHEAD	GL GLASS	TYP TYPICAL
CMT CERAMIC Mosaic TILE	PNT PAINT	GyB GYPSUM BOARD	UL UNDERCUT
CLR CLEAR	PTD PAINTED	GRN GRANITE	UR UNDERWRITERS
CLOS CLOSET	PR PAINT	GT GROUT	LABORATORIES, INC.
CONST CONSTRUCTION	PAR PARTITION	HOW HARDWARE	UR UNLESS OTHERWISE NOTED
CONT CONTINUOUS	PLAS PLASTER	HWC HARD WOOD	UPHOL UPHOLSTERED
DEP DERESSED	PLAS LAM PLASTIC LAMINATE	HC HOLLOW CORE	VAR VARIES
DET DETAIL	PLYD PLYWOOD	HM HOLLOW METAL	VERT VERTICAL
DIAG DIAGONAL	PLT PLATE	HVAC HEATING, VENTILATION & AIR CONDITIONING	VVC VINYL WALL COVERING
DIA DIAMETER	PLYD PRESURE TREATED	INCAND INCANDESCENT	VCT VINYL COMPOSITION TILE
DIFF DIFFUSER	POL POLISHED	IN INCH	WV WALL TO WALL
DM DIMENSION	PVC POLYVINYLCHLORIDE	INS INSULATION	WC WATER CLOSET
DN DOWN	PROP PROPERTY	INT INTERIOR	WP WORK POINT
DND DRAWING	PREFAB PREFABRICATED	JAN JANITOR'S CLOSET	WB WOOD BASE
DND DRAWING FOUNTAIN		JNT JOINT	YD YARD
DBL DOUBLE ACTING			
DA DOUBLE			
KIT KITCHEN			

#### SYMBOLS

	CONCRETE		STEEL		WORKING POINT
	WOOD BLOCKING		FINISH WOOD		DETAIL NUMBER
	PLYWOOD		ACOUSTICAL CEILING TILE		SHEET REFERENCE
	BATT INSULATION		CONCRETE BLOCK MASONRY		ELEVATION NUMBER
	RIGID INSULATION		EXTERIOR INSULATING AND FINISHING SYSTEM (EIFS)		SHEET REFERENCE
	GYPSUM BOARD		WINDOW/LOUVER TYPE		SECTION NUMBER
			DOOR MARK		SHEET REFERENCE
			PARTITION TYPE		

#### GENERAL NOTES

- THESE DOCUMENTS INDICATE CONSTRUCTION MATERIALS AND METHODS OF CONSTRUCTION IN ORDER TO ESTABLISH STANDARDS FOR QUALITY AND/OR PERFORMANCE. MATERIALS AND METHODS, OTHER THAN THOSE INDICATED WITHIN THESE DOCUMENTS, SHALL BE PROPOSED TO THE ARCHITECT FOR ACCEPTANCE PROVIDED THEY DO NOT AFFECT THE APPEARANCE AS INDICATED WITHIN THESE CONSTRUCTION DOCUMENTS IN ANY WAY WHATSOEVER, AND CONFORM TO SPECIFICATIONS AND REQUIREMENTS WHICH ARE A PART OF THE CONTRACT DOCUMENTS FOR THIS PROJECT.
- MATERIALS, DIMENSIONS, AND ALL OTHER CONDITIONS NOT OTHERWISE INDICATED IN THESE CONSTRUCTION DOCUMENTS SHALL BE INTERPRETED AS HAVING THE SAME MEANING AS THOSE SIMILARLY DETAILED MORE FULLY AND MORE FULLY DEFINED ELSEWHERE WITHIN THESE DOCUMENTS.
- THE CONTRACTOR SHALL FIELD VERIFY ALL DIMENSIONS INDICATED WITHIN THESE DOCUMENTS AND SHALL NOTIFY THE ARCHITECT OF ANY VARIATION PRIOR TO THE PURCHASING OF MATERIALS, STARTING FABRICATION, OR BEGINNING CONSTRUCTION, FABRICATION, OR THE BEGINNING OF CONSTRUCTION.
- ALL FASTENERS AND ATTACHMENTS SHALL BE FULLY CONCEALED FROM VIEW, UNLESS OTHERWISE NOTED.
- DIMENSIONS NOTED AS "CLEAR" SHALL BE MEASURED FROM FINISHED FACE TO FINISH FACE.
- SHOP DRAWINGS, AS REQUIRED, SHALL BE SUBMITTED FOR APPROVAL PRIOR TO FABRICATION OR CONSTRUCTION.
- THE CONTRACTOR SHALL SUBMIT FOR APPROVAL A DESCRIPTION OF ALL MATERIALS, EQUIPMENT AND DEVICES PROPOSED FOR USE IN THE CONSTRUCTION OF THIS PROJECT.
- THE CONTRACTOR SHALL, UPON AWARDED SUBCONTRACTS, NOTIFY THE ARCHITECT BY PROVIDING A LIST OF SUBCONTRACTORS AND THEIR DELIVERY SCHEDULES. THE CONTRACTOR SHALL IDENTIFY ALL LONG LEAD ITEMS REQUIRING EARLY ORDERING AND THAT MAY CAUSE PROJECT DELAYS. NOTIFY THE ARCHITECT IMMEDIATELY OF ANY SPECIFIED ITEM THAT MAY CAUSE DELAYS IN THE PROJECT.
- THE CONTRACTOR SHALL BE RESPONSIBLE FOR ANY DAMAGE WHICH MAY OCCUR DURING SITEWORK OR CONSTRUCTION OF THE BUILDING OR ANY OTHER RELATED PROPERTY.
- THE CONTRACTOR, AT THE COMPLETION OF THIS PROJECT, SHALL LEAVE ALL AREAS AND FINISHED SPACES IN A CLEAN AND ACCEPTABLE CONDITION, SUBJECT TO INSPECTION BY THE ARCHITECT AND OWNER.
- IT IS THE RESPONSIBILITY OF THE CONTRACTOR TO VERIFY THAT THE WORK COVERED BY THESE DOCUMENTS COMPLY WITH THE REQUIREMENTS OF LOCAL AUTHORITIES HAVING JURISDICTION FOR THE WORK. IF ANY PORTION OF THE WORK IS FOUND NOT TO BE IN COMPLIANCE WITH INSPECTIONS, NOTIFY THE ARCHITECT IMMEDIATELY.
- IF ANY PORTION OF THESE DOCUMENTS IS FOUND TO BE IN CONFLICT WITH REFERENCED CODES, THE CONTRACTOR SHALL NOTIFY THE ARCHITECT, IN WRITING, OF THE CONFLICT IMMEDIATELY.
- CONTRACTOR SHALL MAINTAIN UPDATED COPIES OF ALL CONSTRUCTION DOCUMENTS AT THE SITE FOR INSPECTION AT ALL TIMES.
- CONTRACTOR MAY EMPLOY ALTERNATE MEANS AND METHODS TO ACHIEVE THE DESIRED QUALITY OF ANY PORTION OF THE PROJECT. IT IS THE CONTRACTOR'S RESPONSIBILITY TO RESEARCH AND QUALIFY THAT THE PERFORMANCE AND THE CONSTRUCTION SPECIFICATIONS MEET THOSE OF THE ITEM ORIGINALLY SPECIFIED PRIOR TO THE REQUEST FOR CHANGE.

#### GENERAL BUILDING DATA

PROJECT NAME	BUILDING DATA	EXISTING BUILDING
Main Entrance Canopy 901 Follin Lane SE Vienna Virginia 22180	Building Use Group Construction Type Tenant Use Group Number of Stories High Rise Building Covered Mall Sprinklers Fire Alarm	B II-B B Four No No Yes - Automatic
	Total Floor Area Total Area of Intervention Occupant Load Exits Demising Wall Rating Corridor Wall Rating Floor/Ceiling Rating Standard Ceiling Height Governing Codes	24,104 SF 0 SF Not Applicable Not Applicable Not Applicable Not Required (2012 IBC Table 602) 10'-6" AFF 2012 Virginia Uniform Statewide Building Code 2012 International Building Code 2012 International Mechanical Code 2011 National Electric Code 2010 American National Standard ICC/ANSI A117.1
OWNER/ MANAGER Zalco Commercial 10801 Lockwood Drive Suite 370 Silver Spring Maryland 20901		


#### PROJECT DESCRIPTION

REPLACEMENT OF THE MAIN BUILDING ENTRY CANOPY. DEMOLITION INCLUDES REMOVED OF THE EXISTING FABRIC CANOPY AND STRUCTURE. NEW WORK INCLUDES NEW CANOPY, FOUNDATION AND STRUCTURE AND NEW LIGHTING FOR NEW CANOPY.




#### DRAWING INDEX

- Sheet No. Sheet Title:
- A1.0 Cover Sheet Symbols and Notes
  - A1.1 Construction Plans and Notes
  - A1.2 Canopy Elevations and Notes
  - A1.3 Lighting Plan and Notes

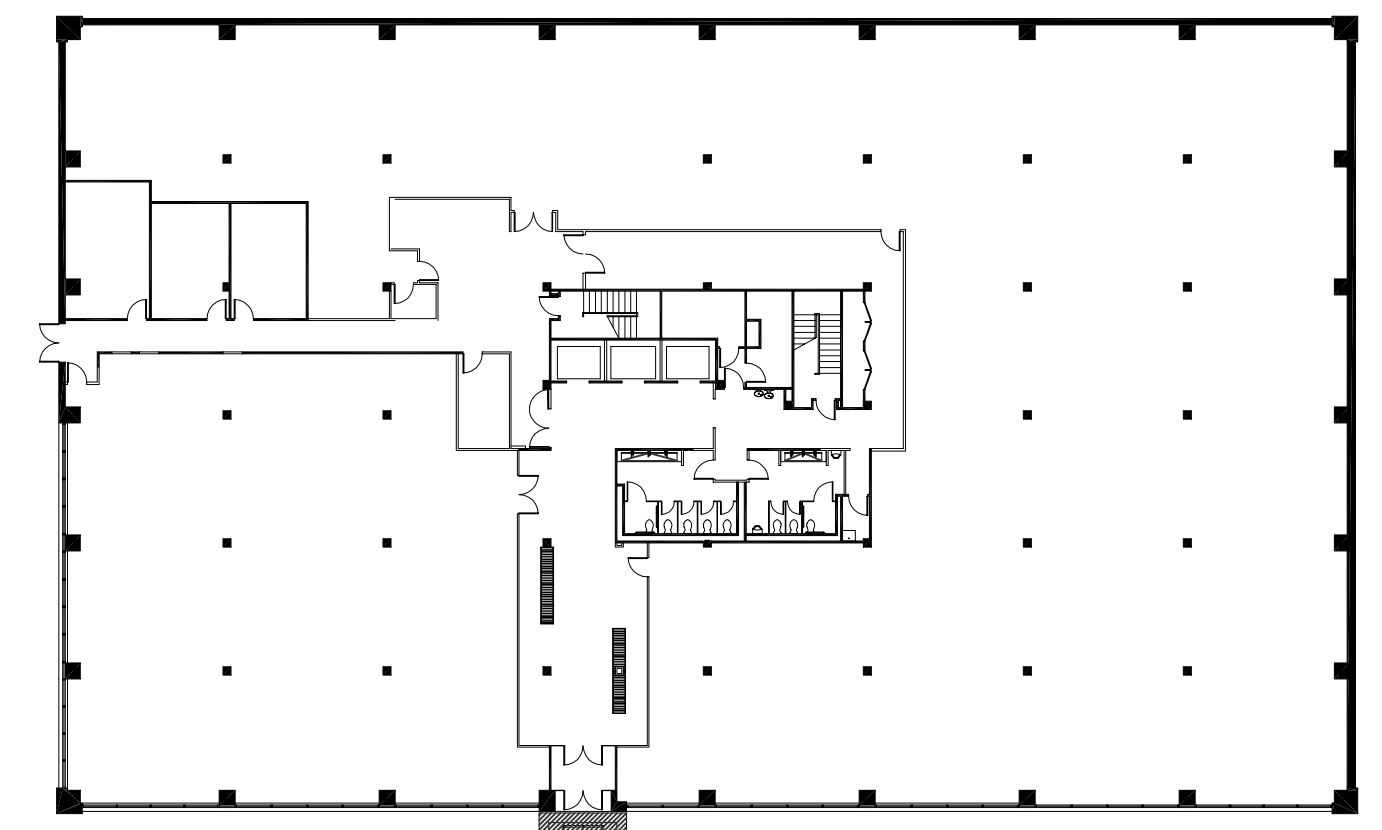

Main Entry Canopy  
 Key Plan  
 1" = 30'-0"

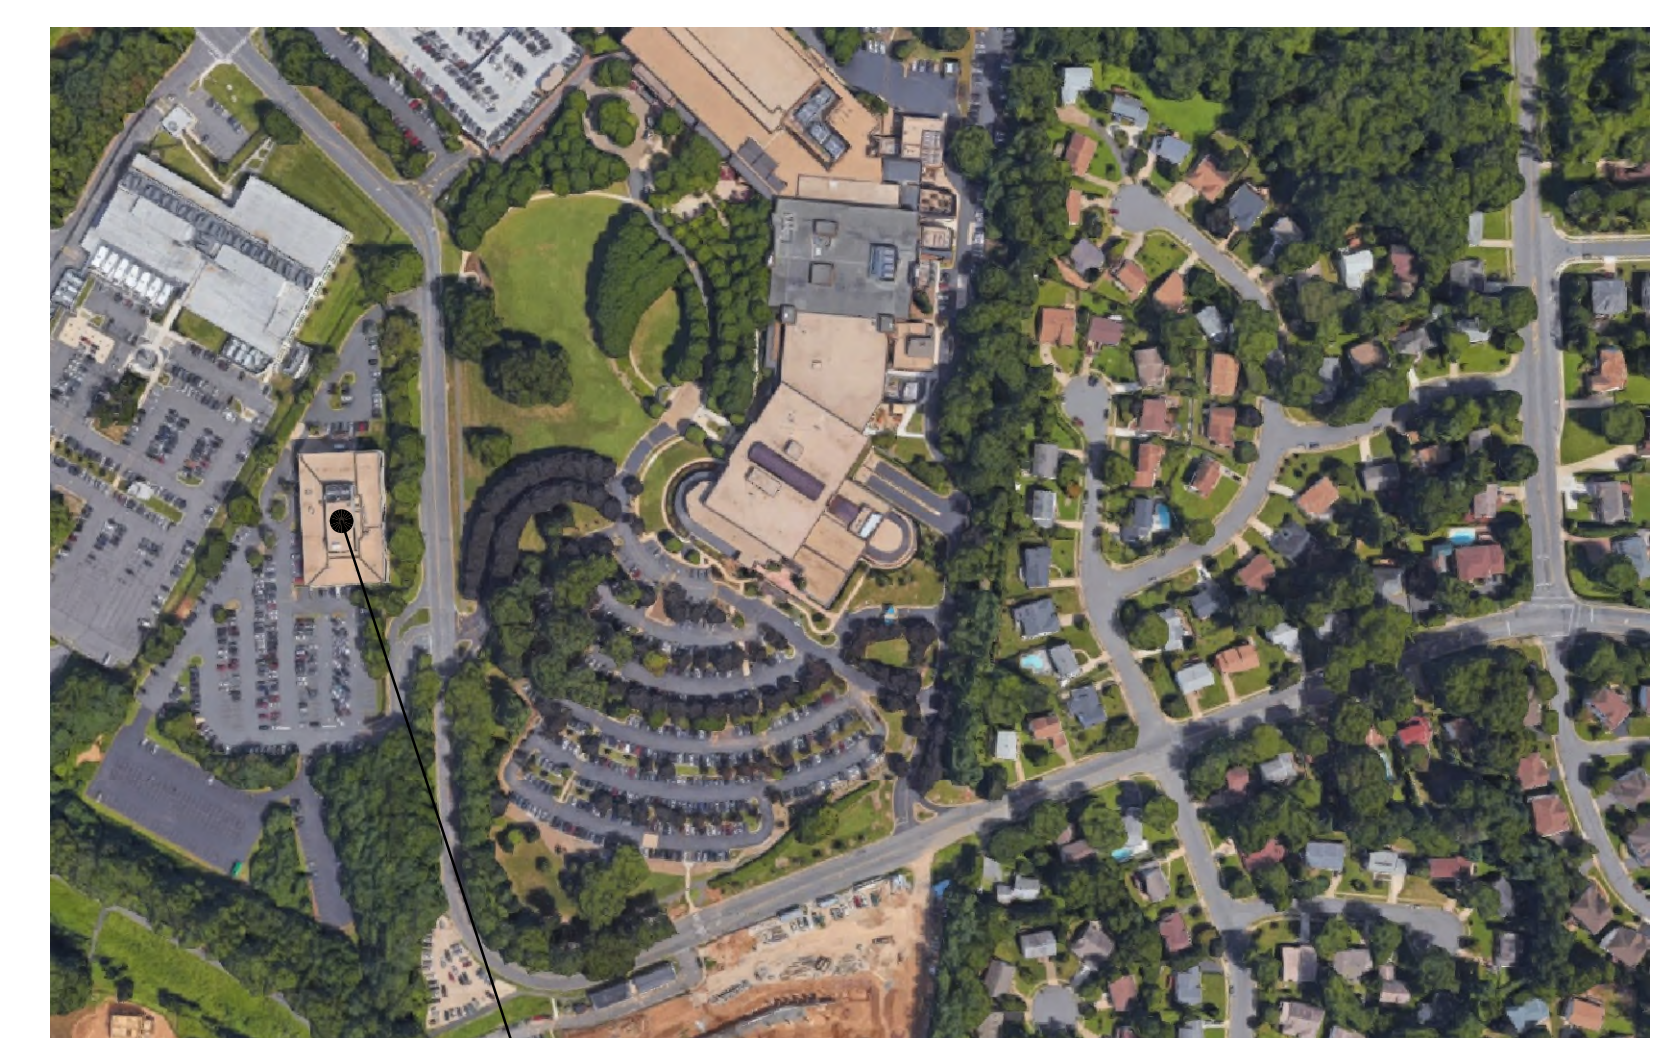

901 FOLLIN LANE  
 Location Plan  
 No Scale

Seal

Drawing Title

**Cover Sheet**

North

Scale


As Noted

No.	Date	Description
1	06/13/19	Review
2	07/10/19	Review

Project 1252

Sheet

# A1.0

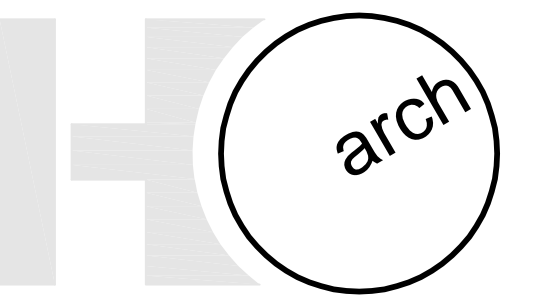

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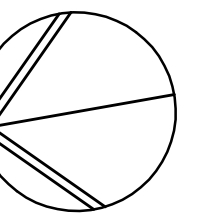
**Main Entrance  
 Canopy**

Seal

Drawing Title


**Construction  
 Plan and Notes**

North



Scale

1/2" = 1'-0"

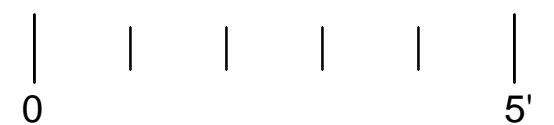


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2	07/10/19	Review


Project 1252

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**A1.1**

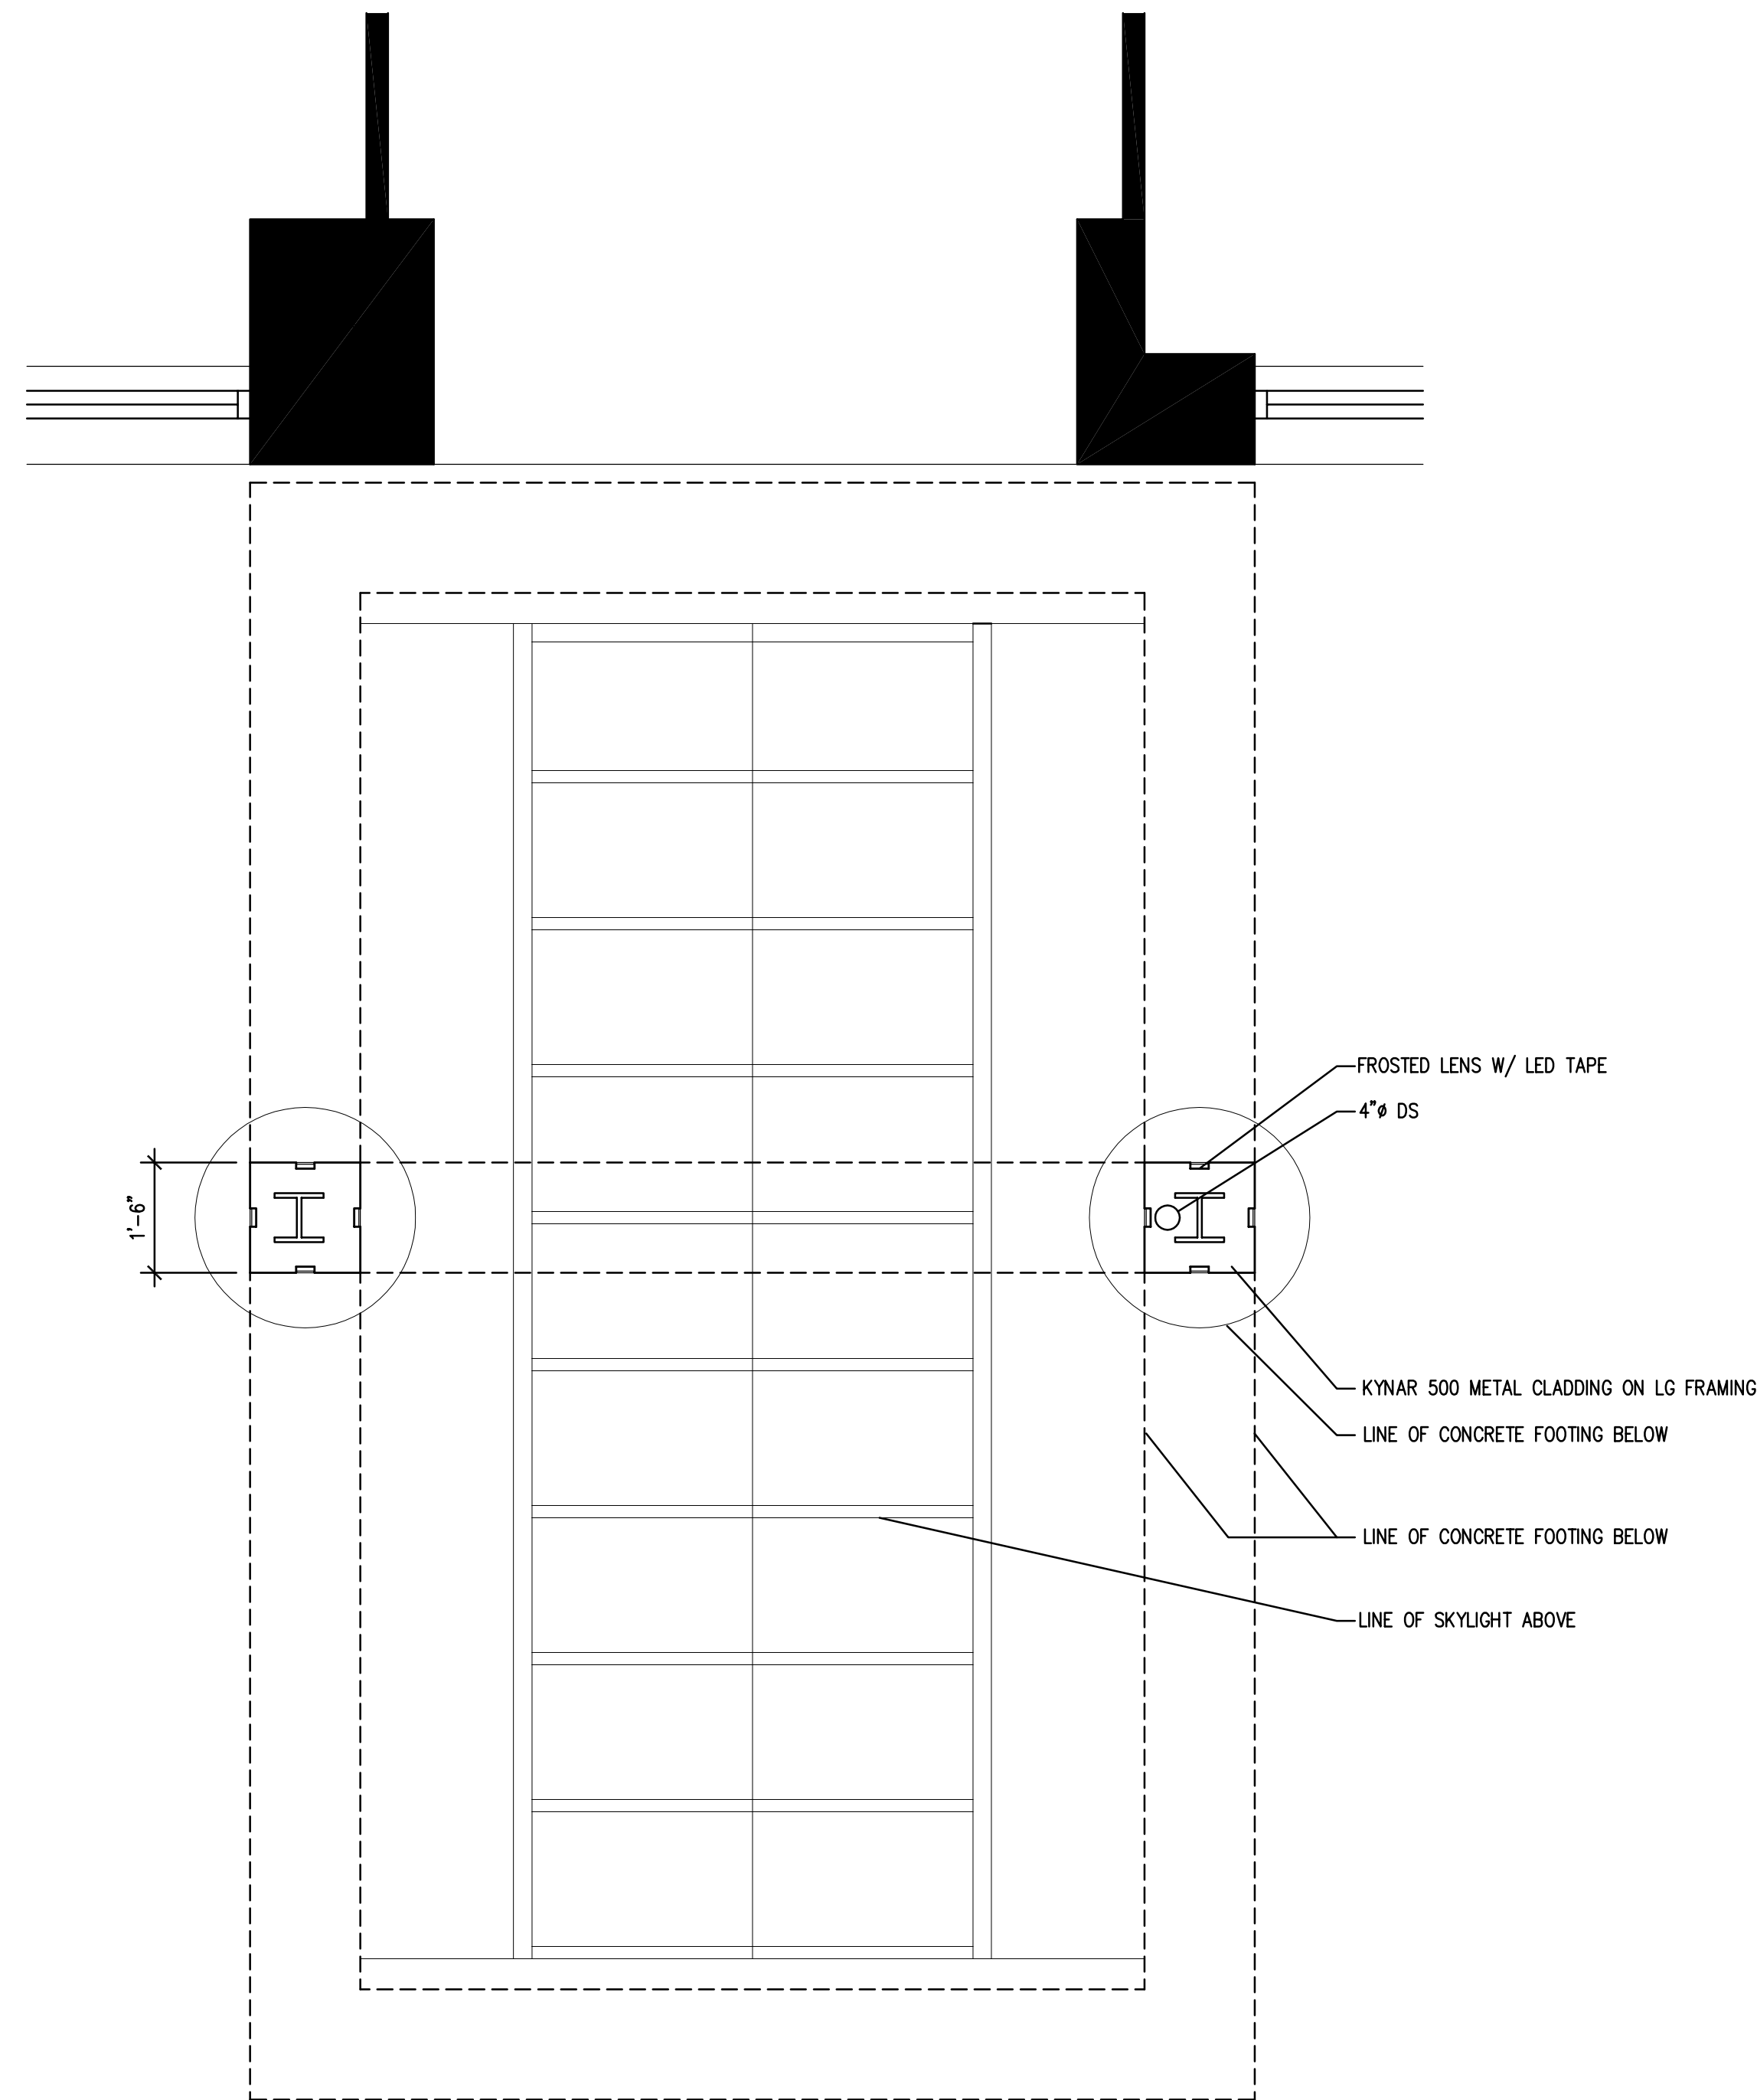

PLAN AT GRADE

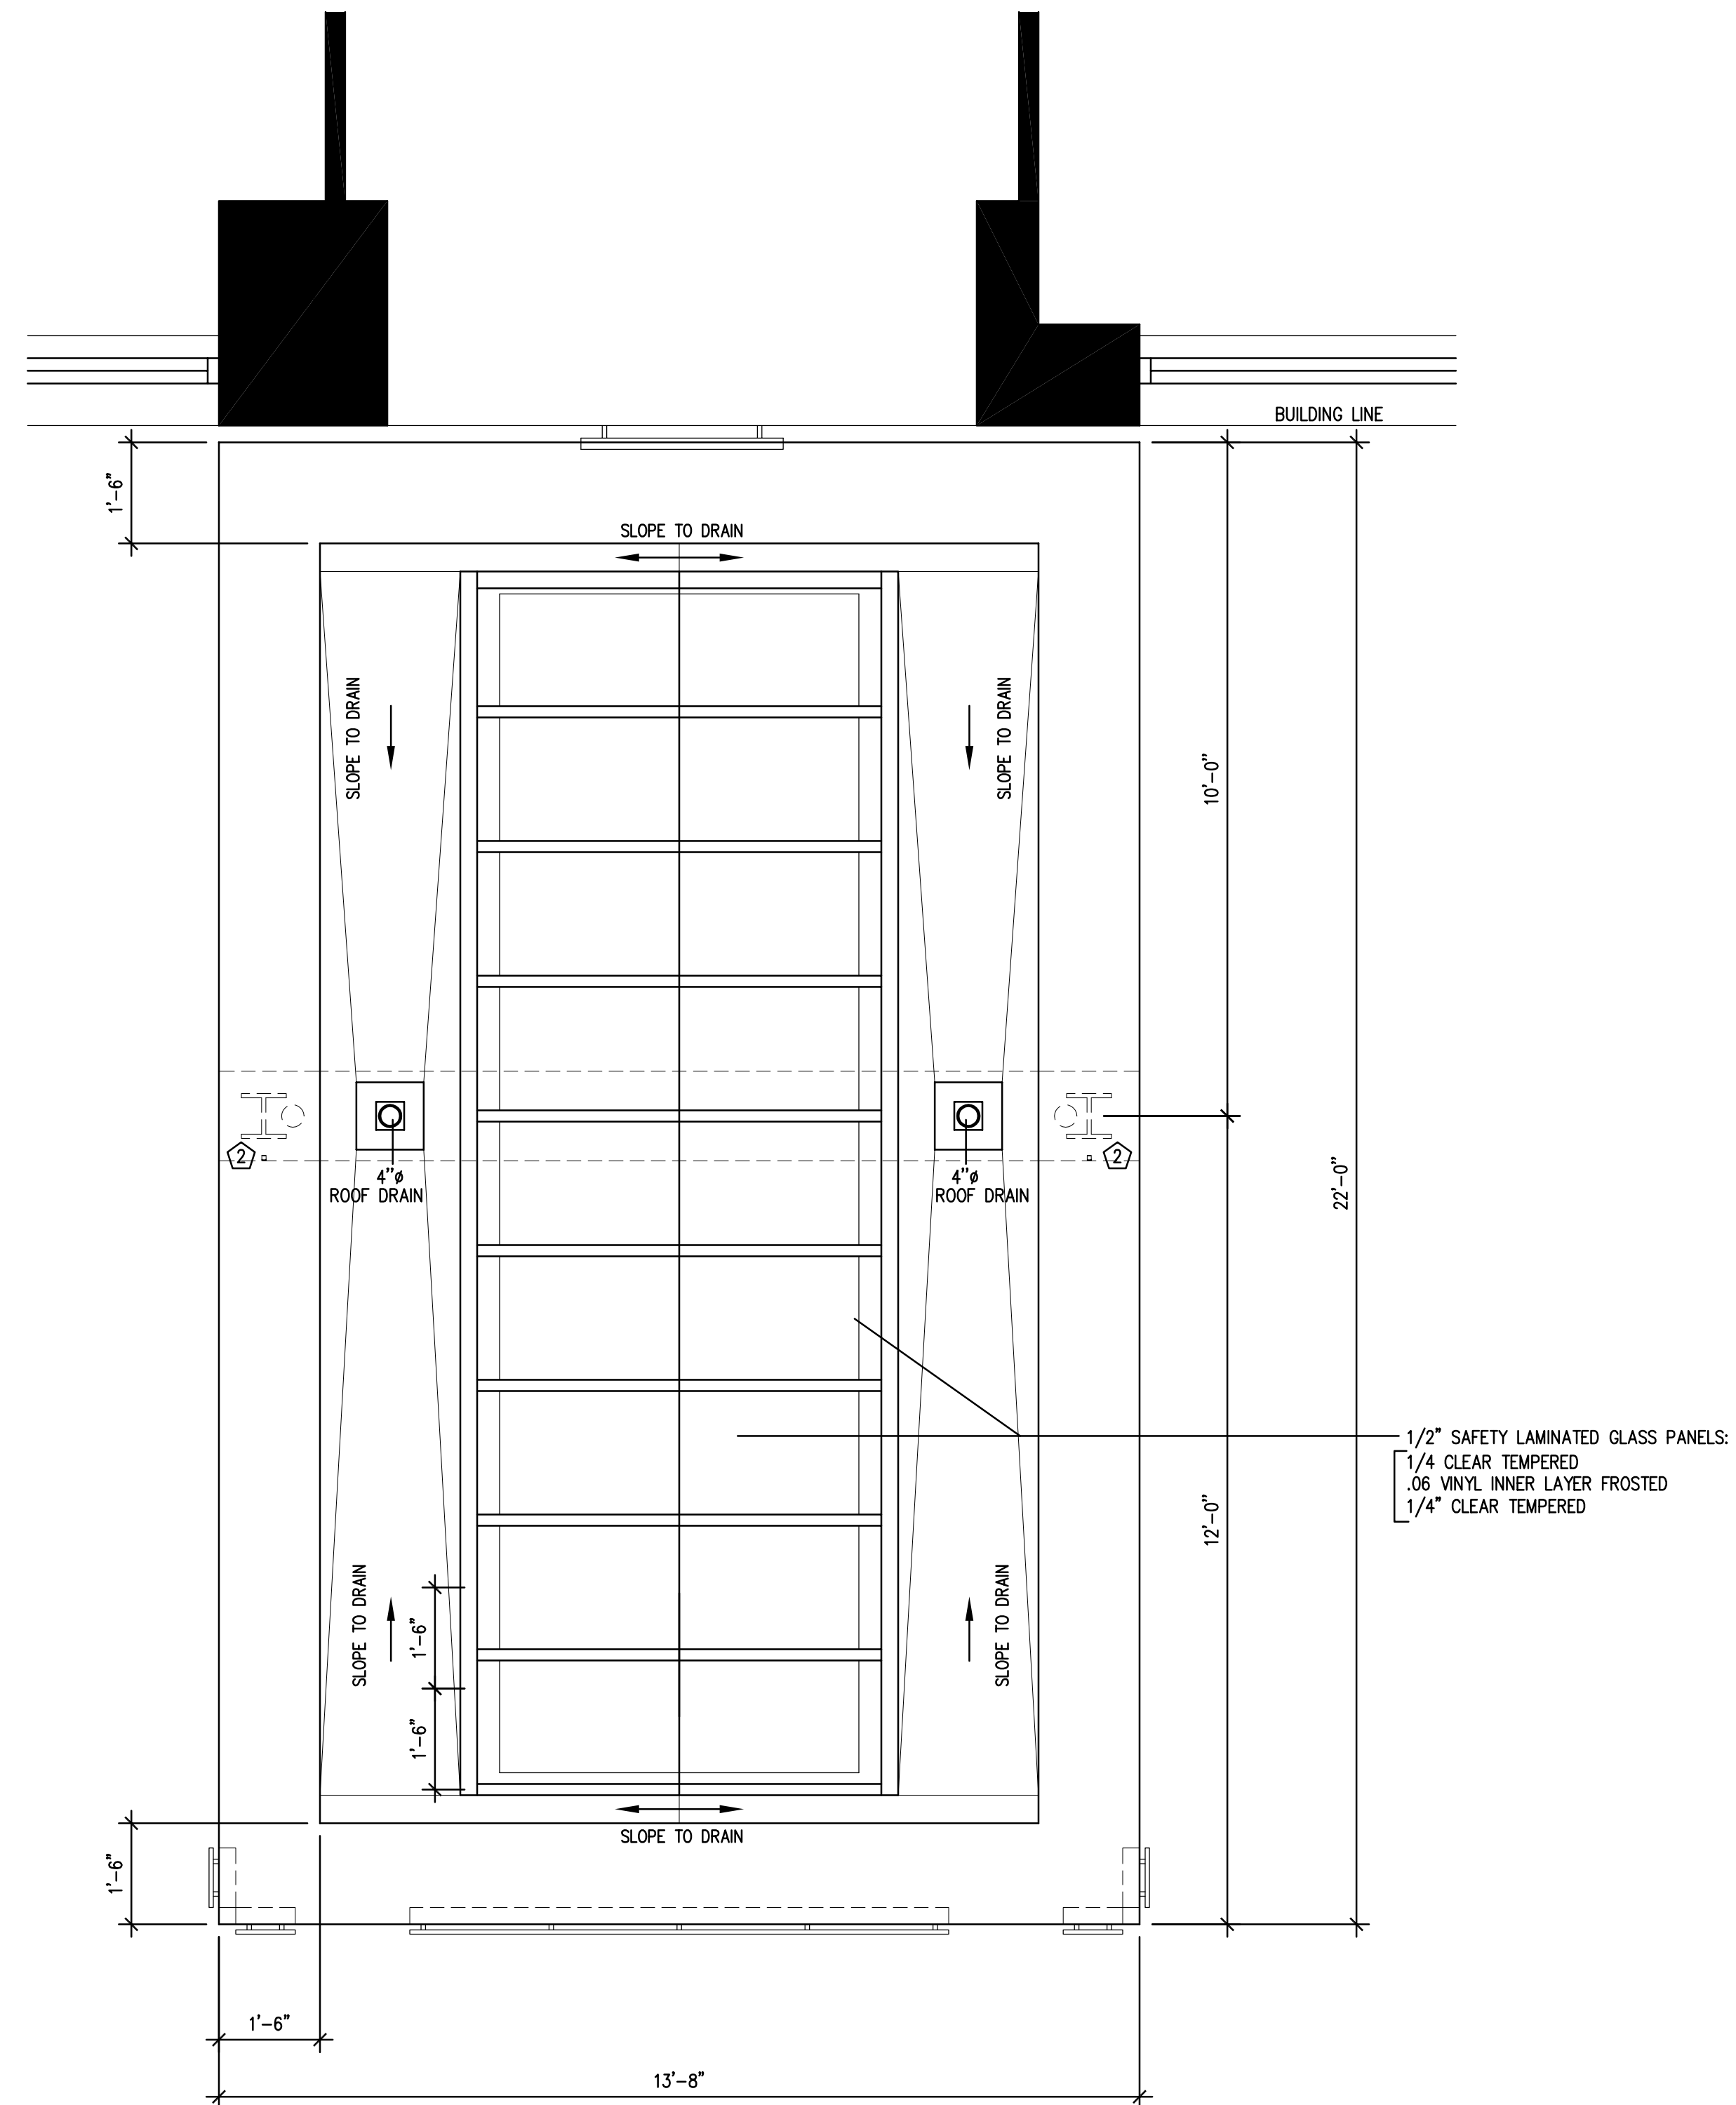

PLAN AT ROOF

**CONSTRUCTION NOTES**

- ① METAL CLADDING SHALL BE KYNAR 500 COATED PACLAD ALUMINUM PANELS.
- ② AT LOCATION INDICATION, INSTALL NEW STEEL COLUMN, PLATE AND FOOTING.
- ③ CONTRACTOR SHALL SUBMIT SHOP DRAWINGS FOR 1/2" SAFETY LAMINATED GLASS PANEL SKYLIGHT.
- ④ SIGNAGE AND INSTALLATION SHALL BE BY OTHERS WITH ELECTRICAL CONNECTIONS BY GC.



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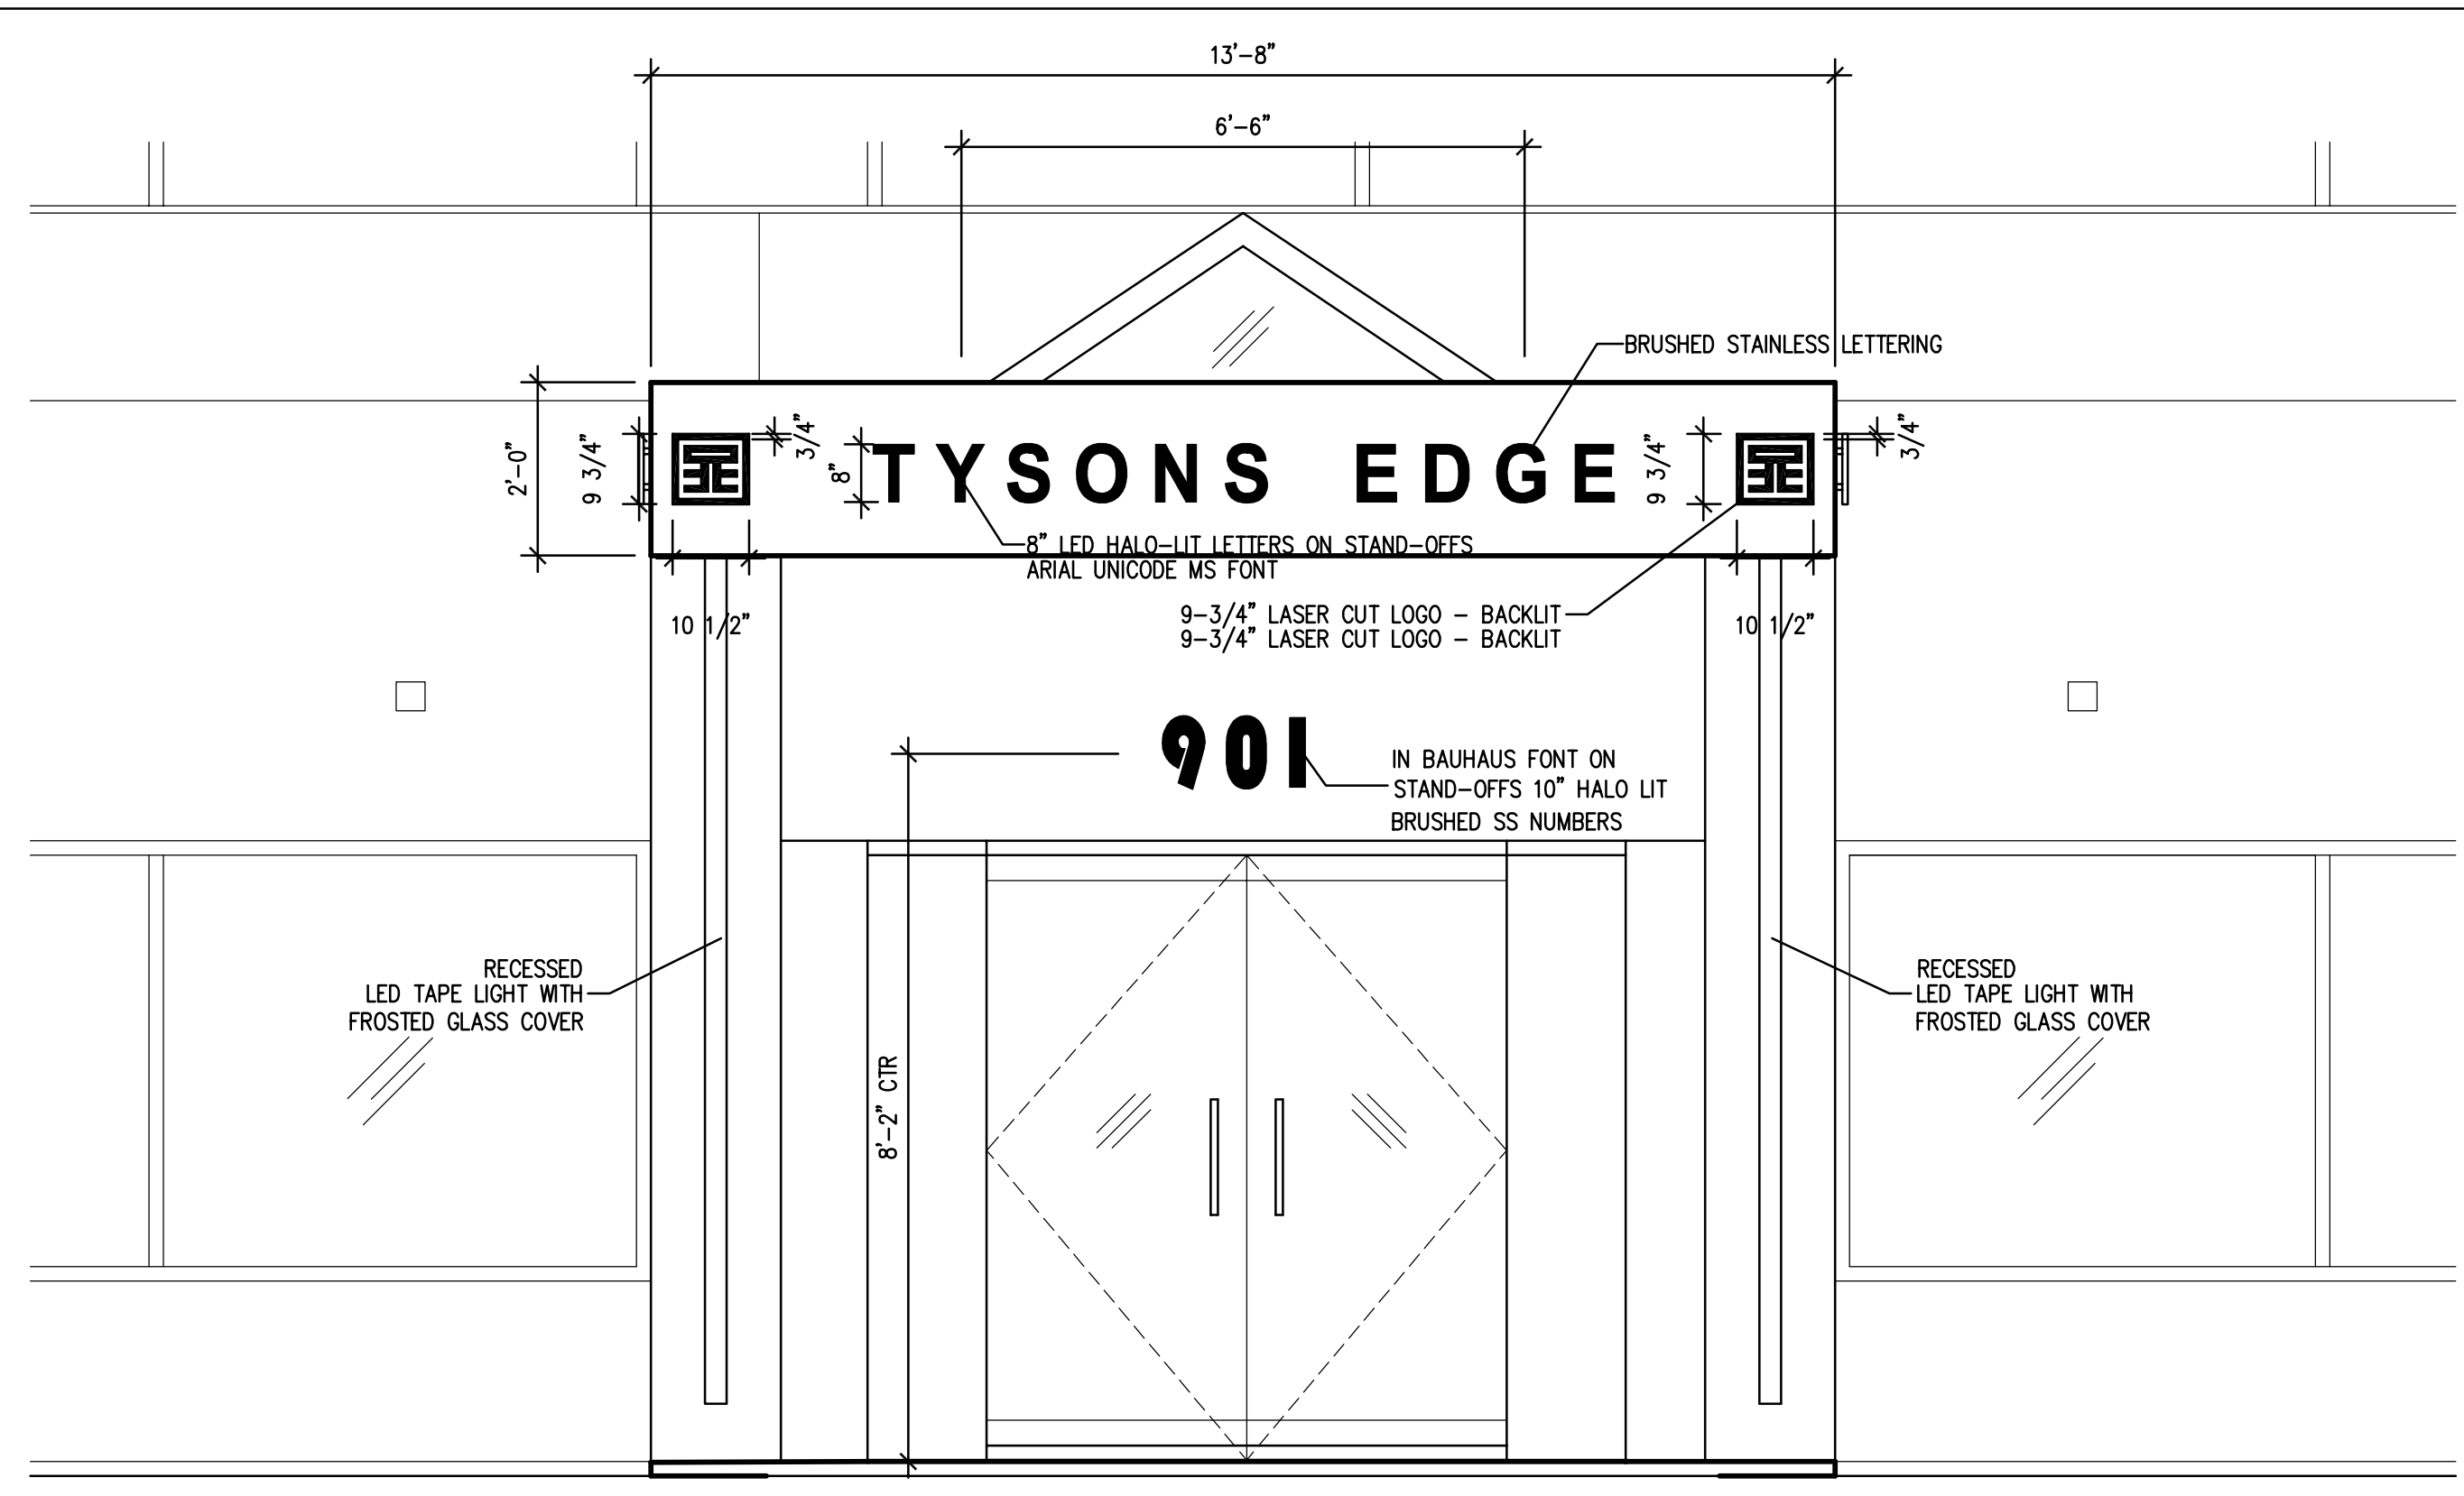
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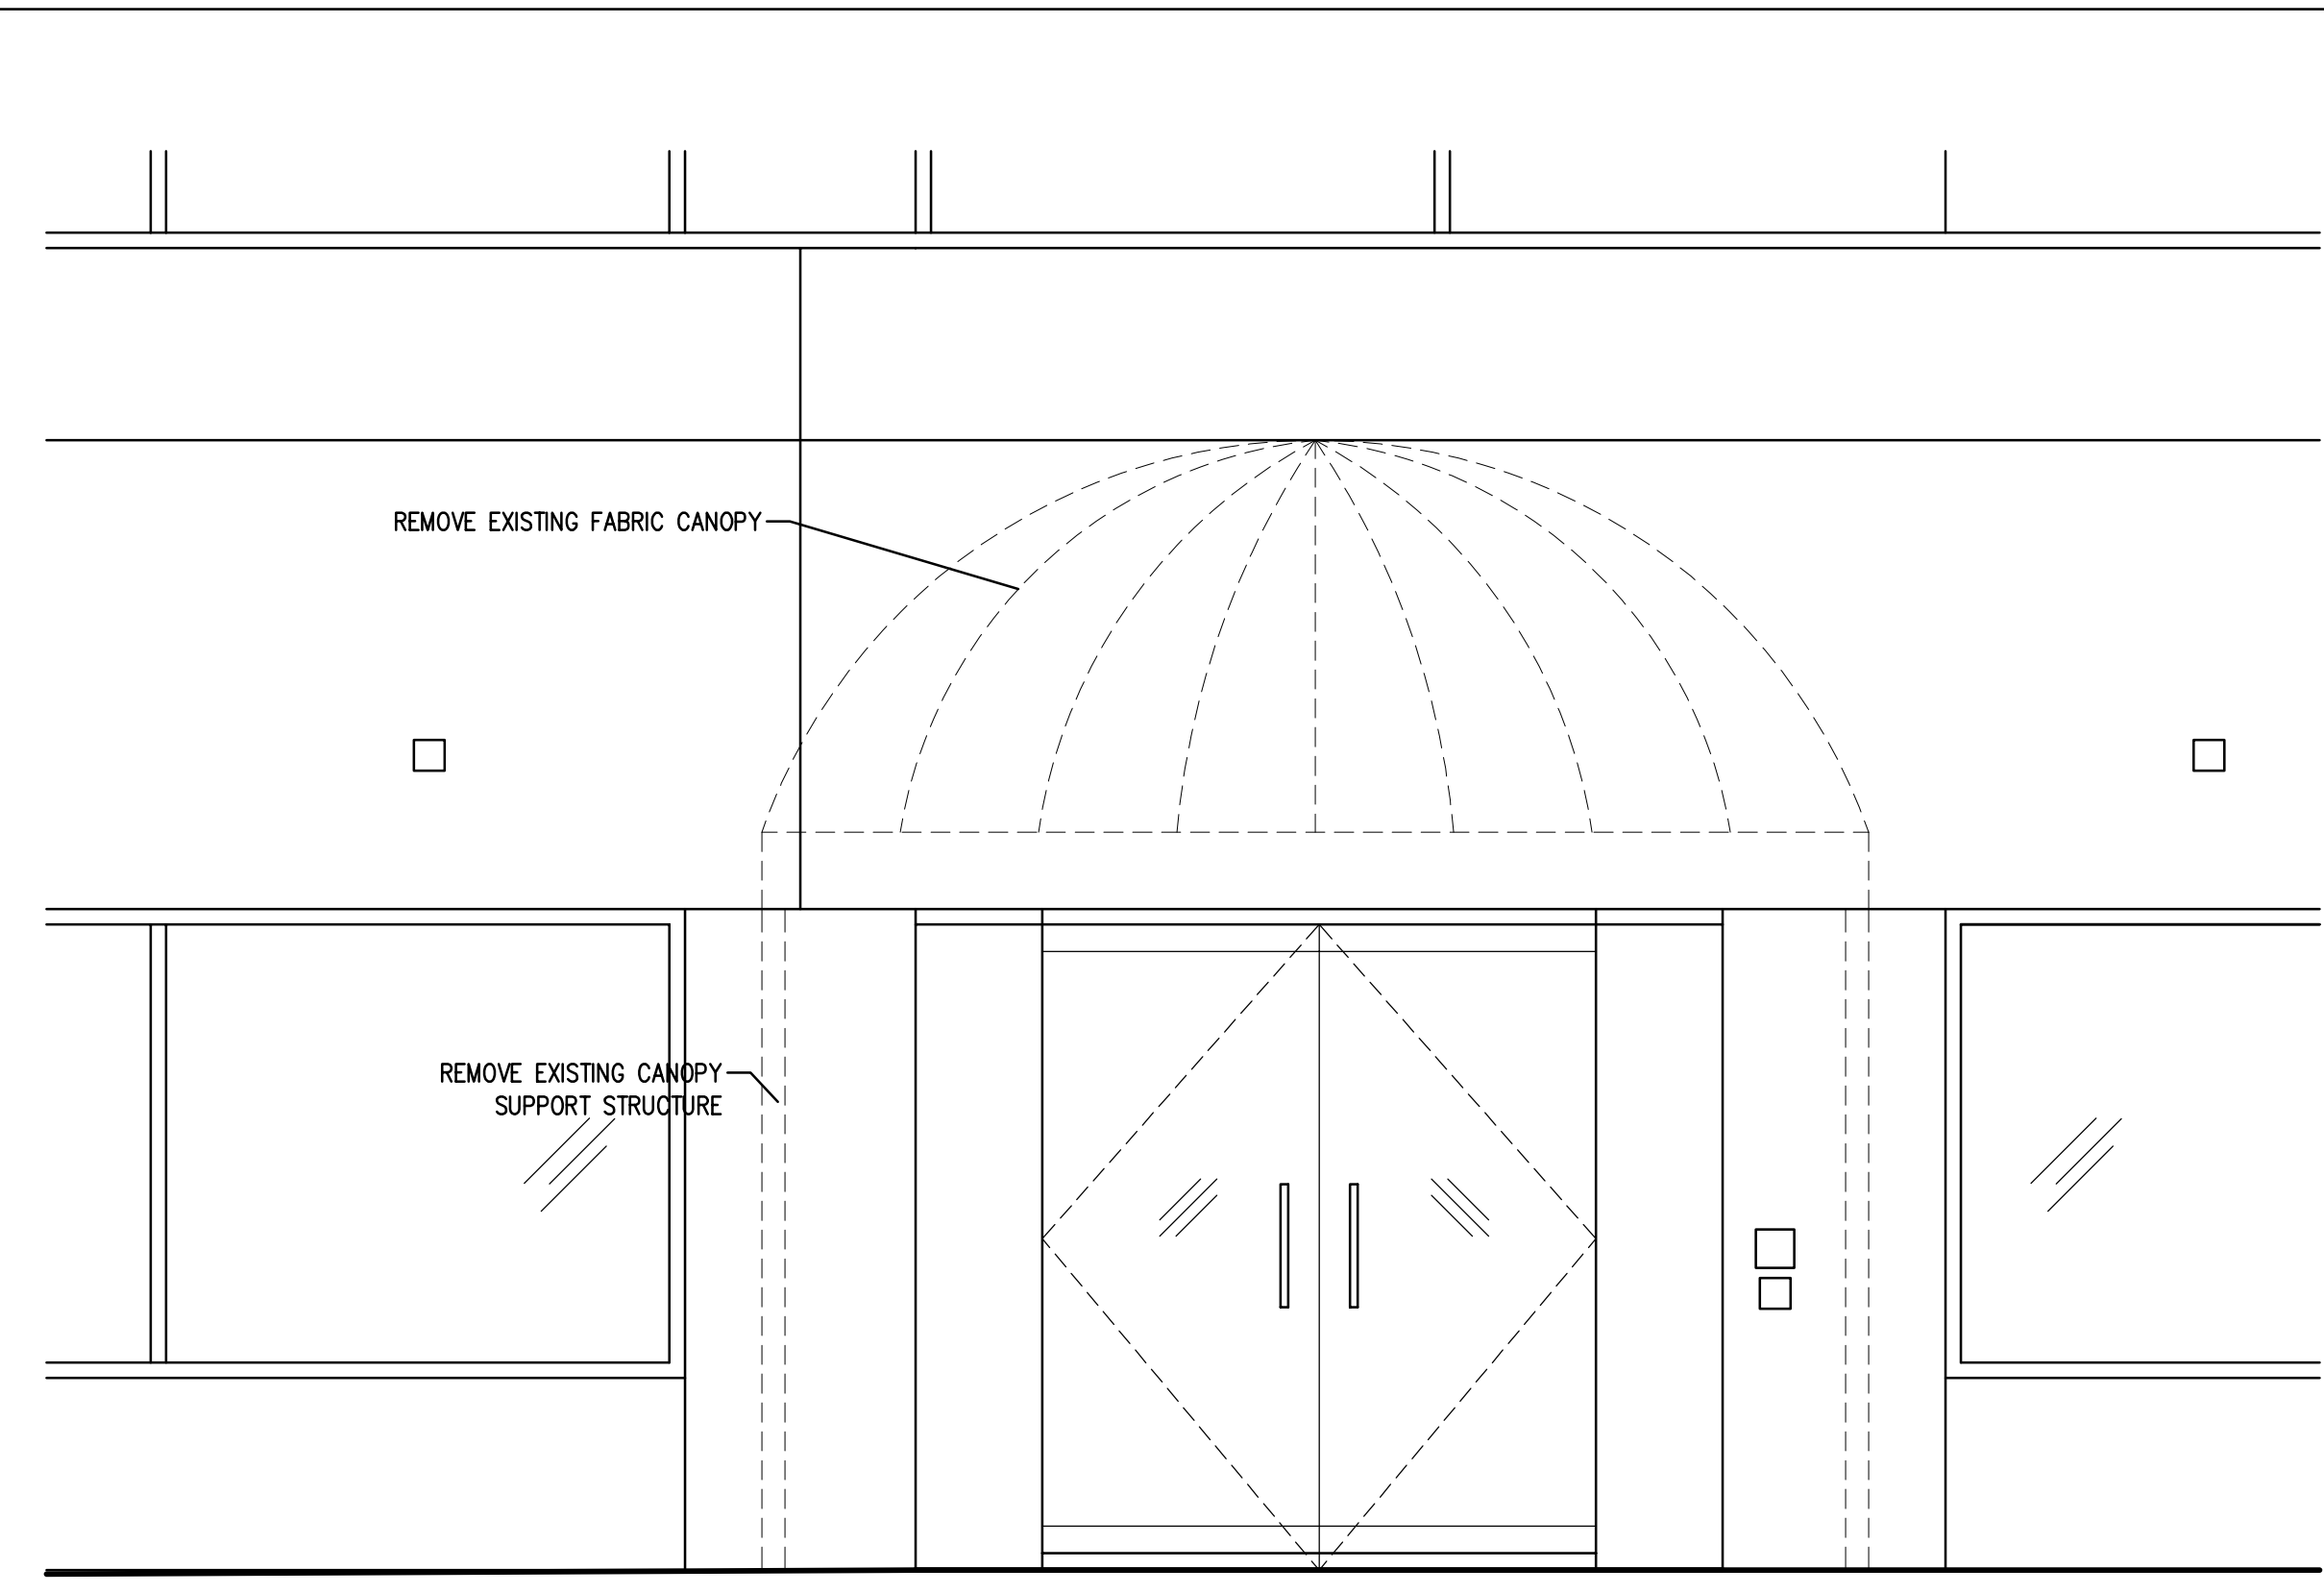
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Project


**Main Entrance Canopy**




Proposed Canopy Elevation  
 1/2" = 1'-0" 2



Existing Canopy Elevation  
 1" = 1'-0" 1

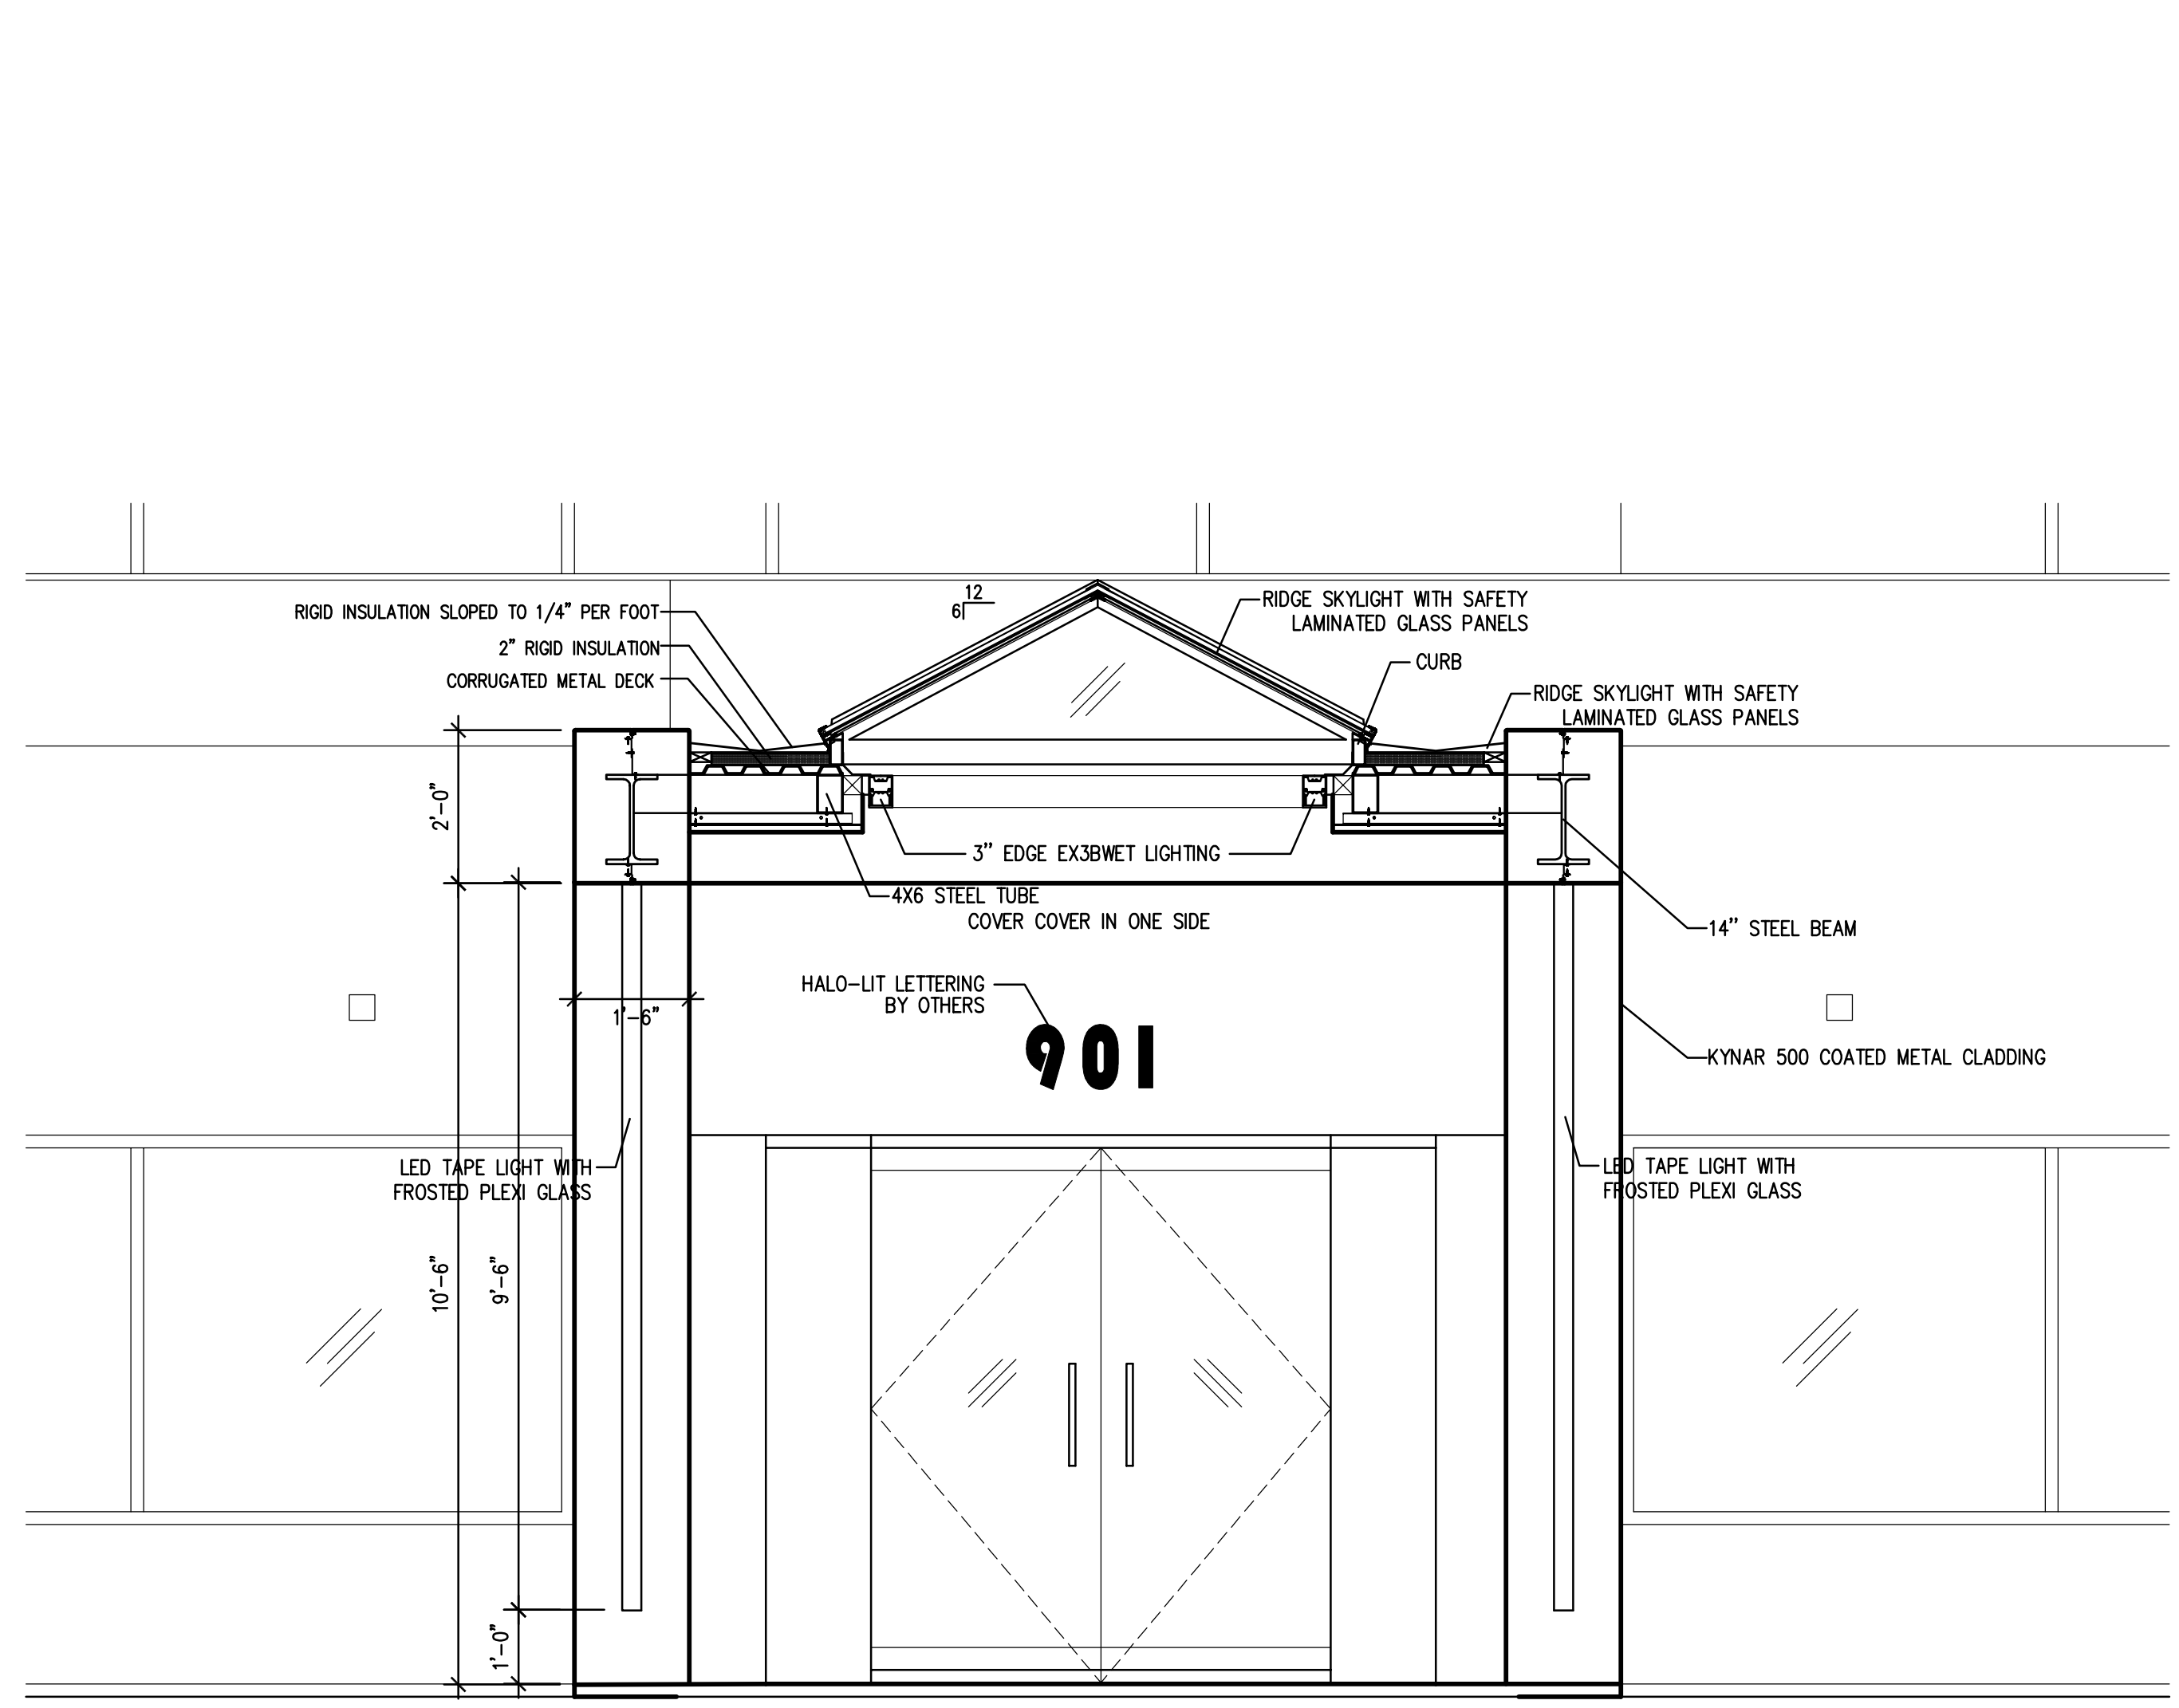

Canopy Cross Section  
 1/2" = 1'-0" 4

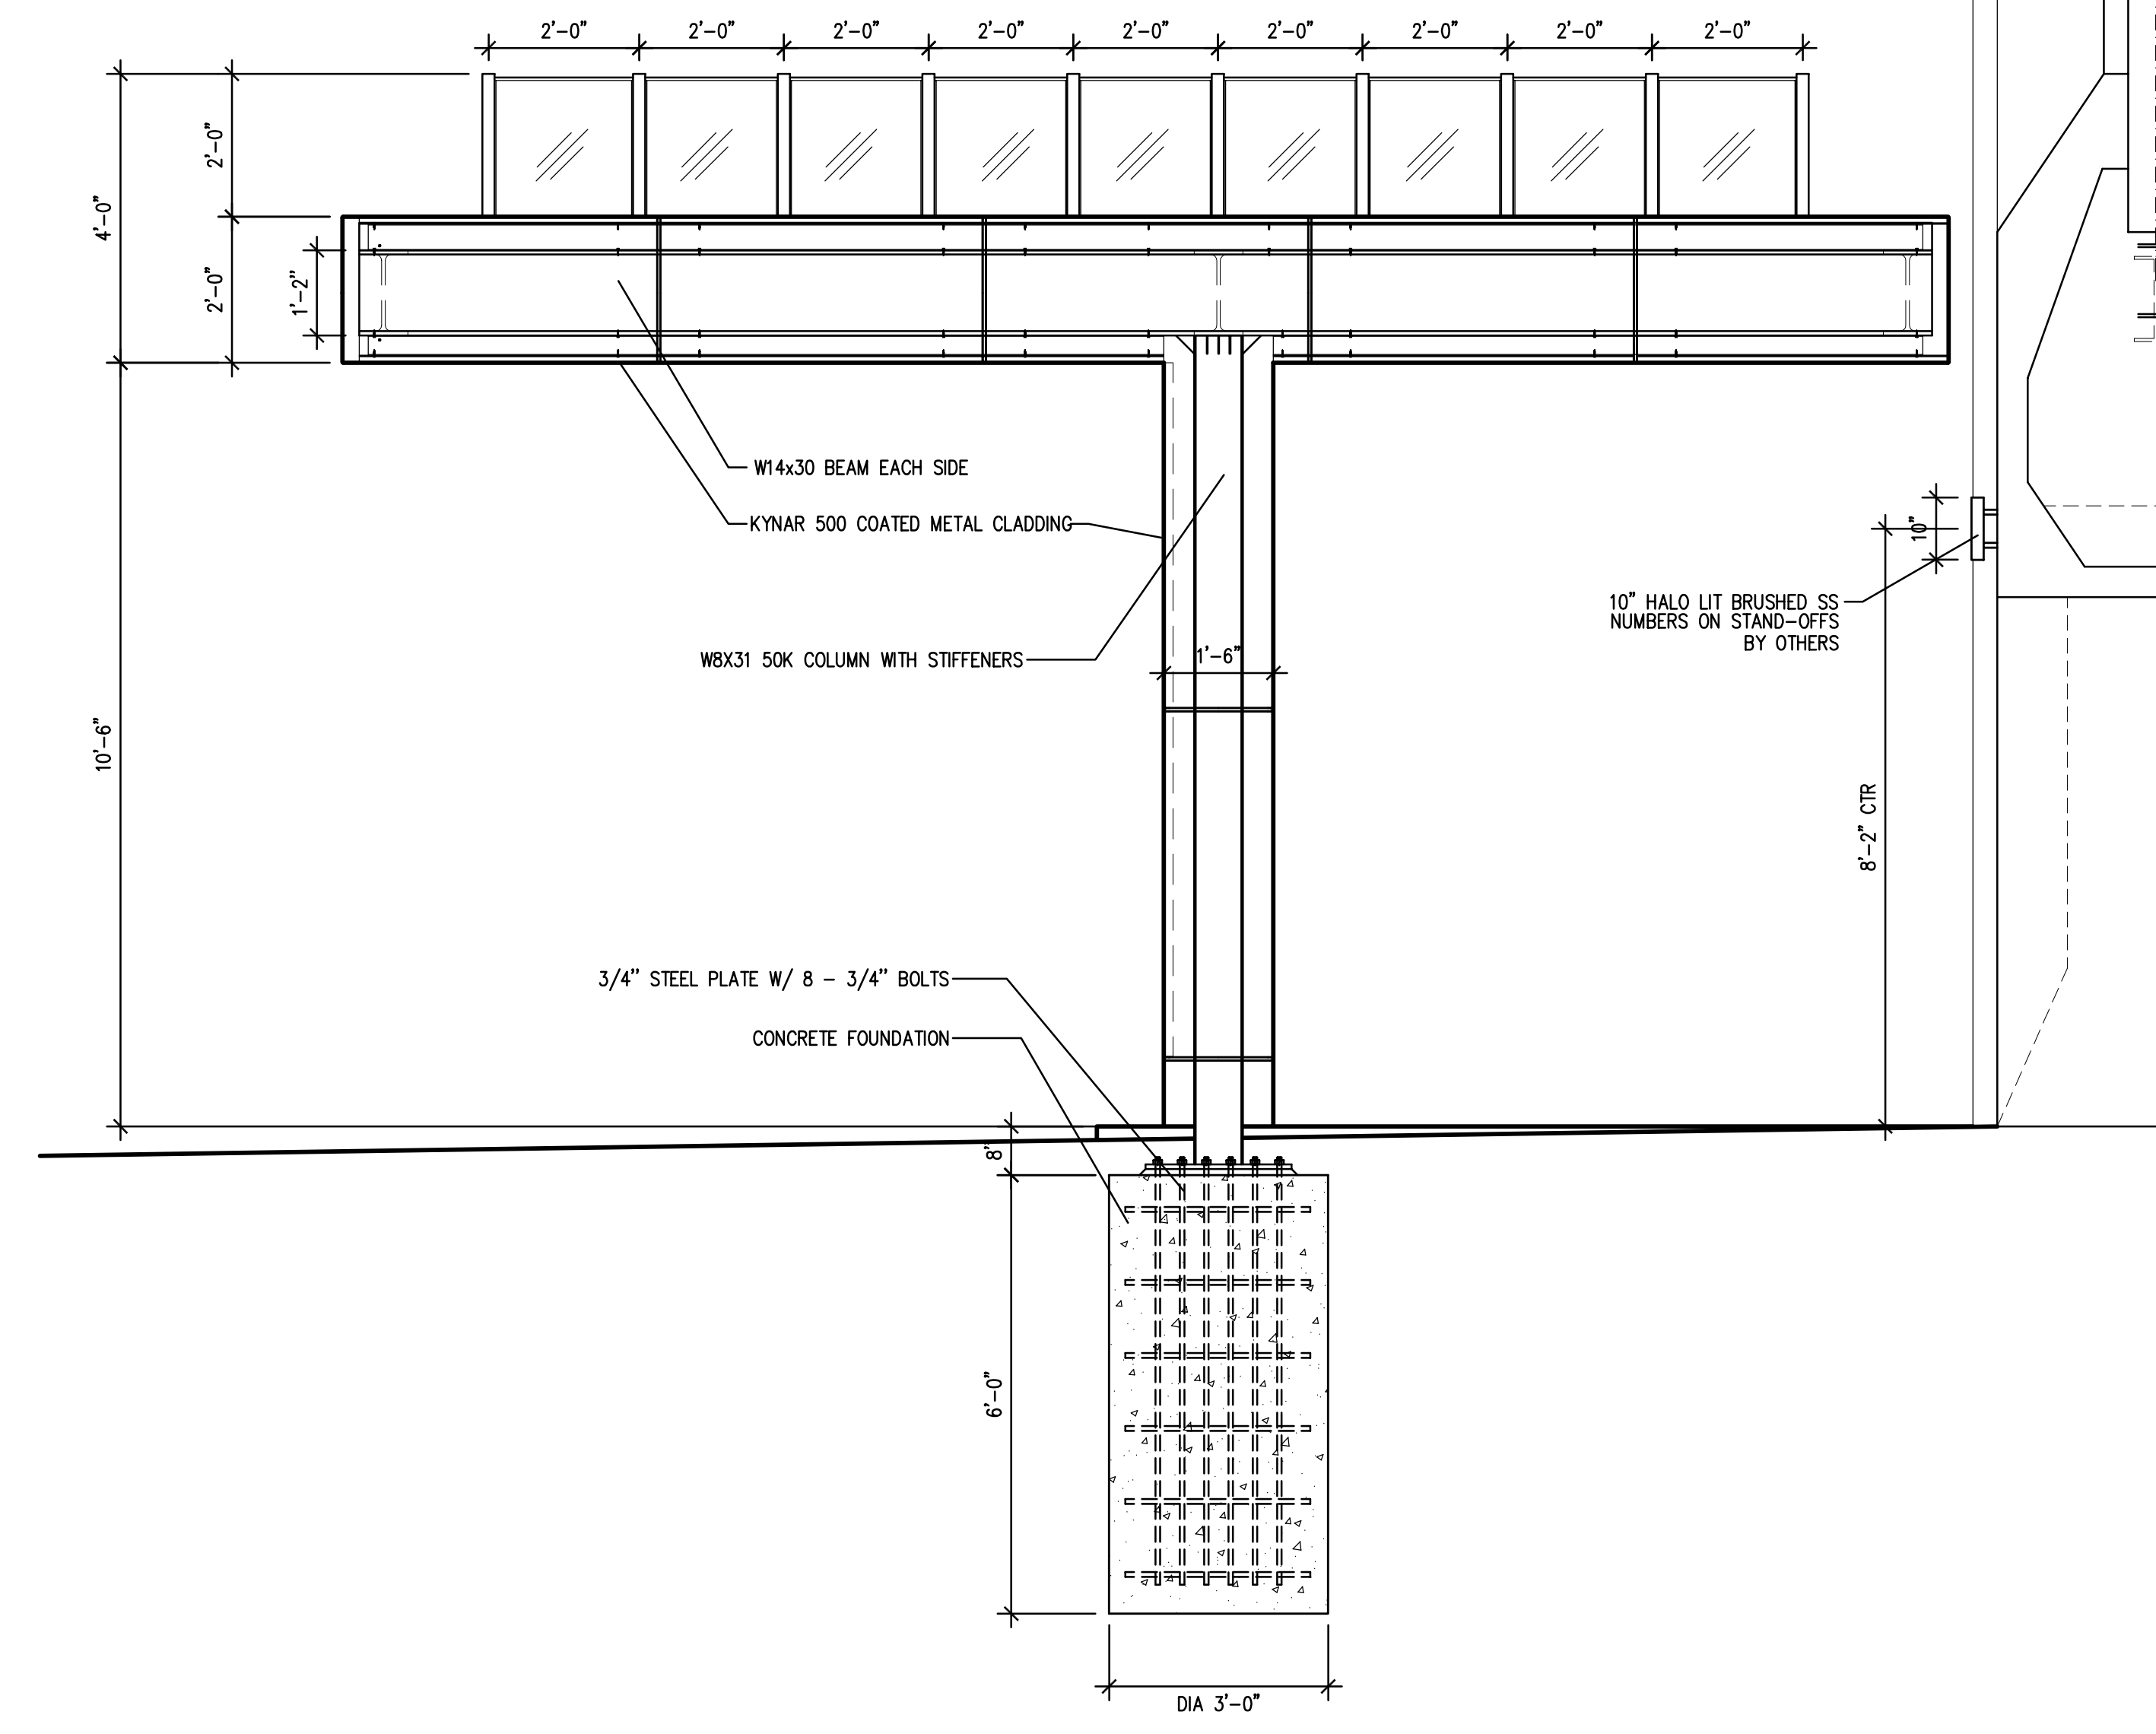


Canopy Transverse Section  
 1/2" = 1'-0" 3

Seal


Drawing Title  
**Canopy Details**

North

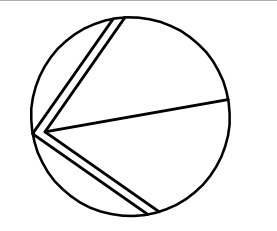

Scale

1/2" = 1'-0"

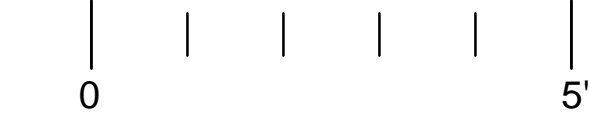


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Project 1252

Sheet

**A1.2**

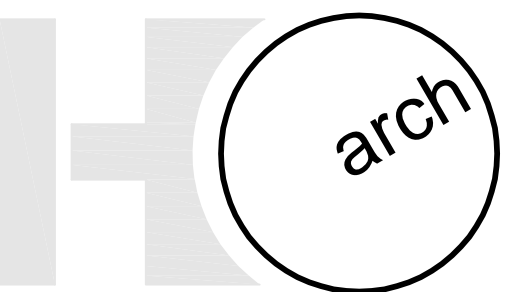

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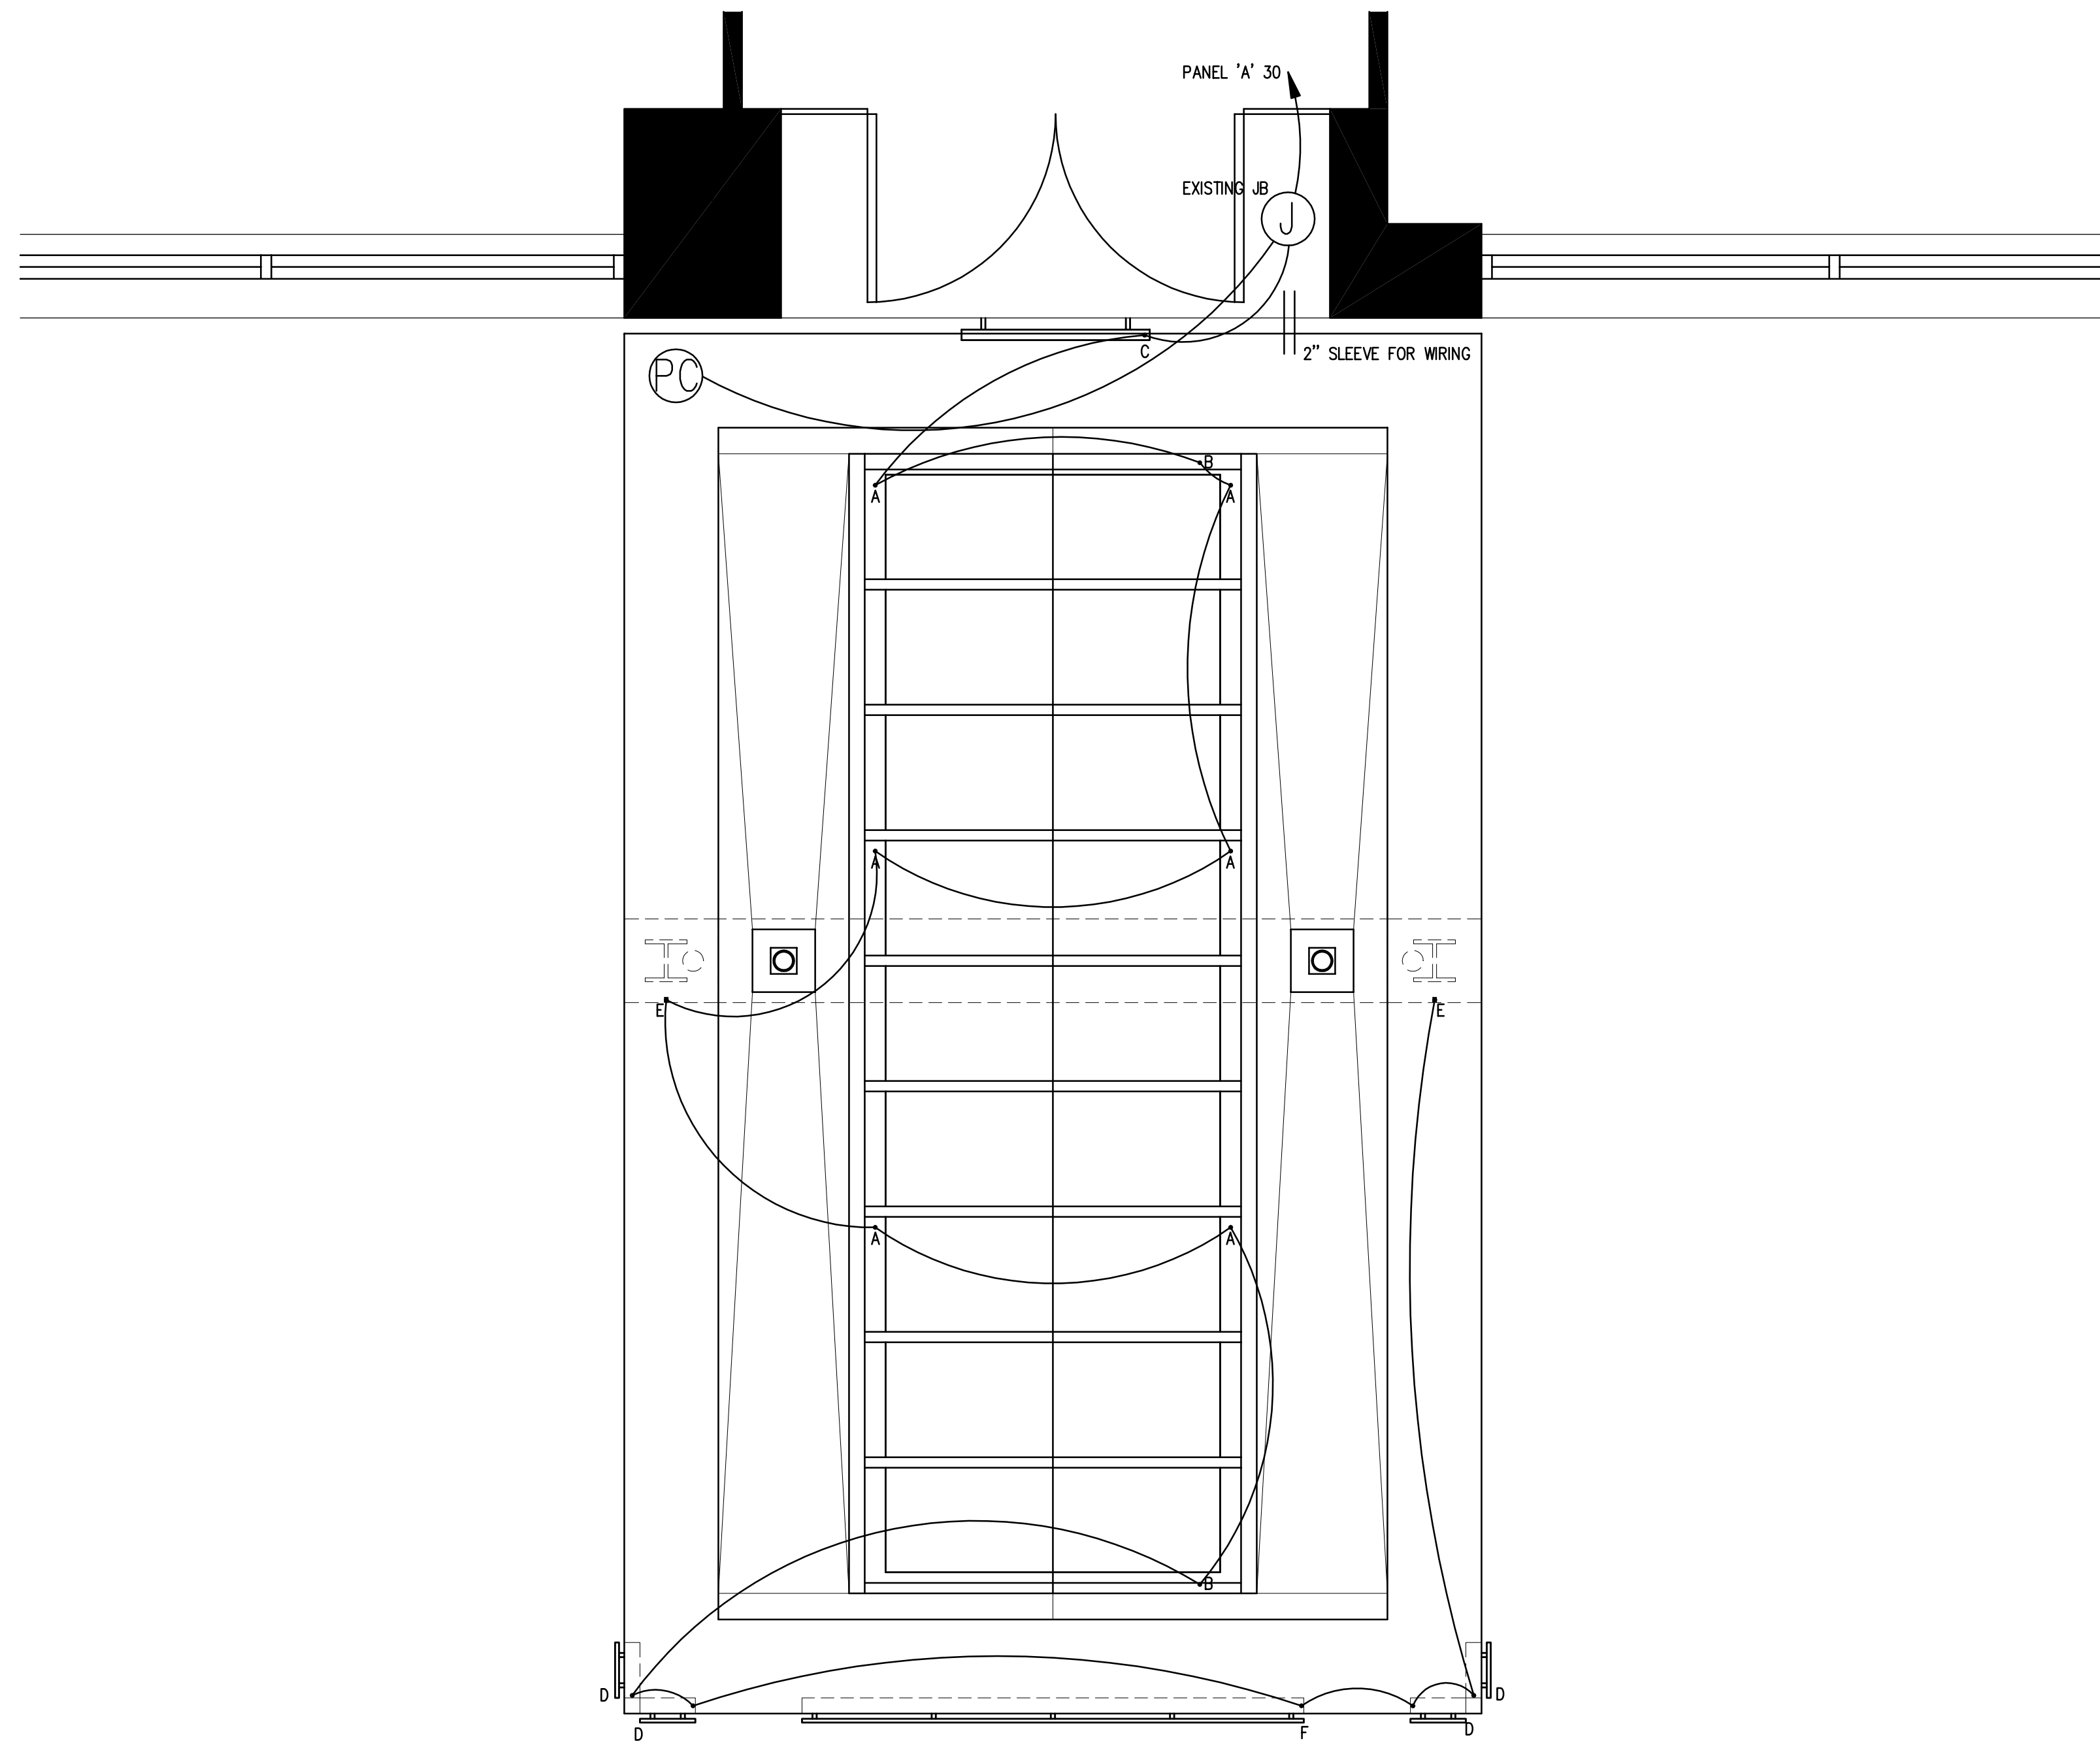
Owner



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Project

**Main Entrance  
 Canopy**



**LIGHTING SYMBOLS**

- A 6' X 3" EDGE EX3BWET WALL MOUNTED  
NEW UNLESS OTHERWISE NOTED
- B 5' X 3" EDGE EX3BWET WALL MOUNTED  
NEW UNLESS OTHERWISE NOTED
- C LED HALO LIGHT SIGN TYSONS EDGE LOGO  
9 3/4" X 10 1/2"  
NEW UNLESS OTHERWISE NOTED
- D LED HALO LIGHT SIGN BUILDING ADDRESS NUMBER  
2' X 3'  
NEW UNLESS OTHERWISE NOTED
- F 9' X 8'-0" LED LIGHT  
ACOLYTE FLEXIBLE BACKLYTE, 10.7W PER SQ.FT.  
NEW UNLESS OTHERWISE NOTED
- E 3' X 9'-6" LED LIGHT TAPE
- PC MOUNTED PHOTOCELL  
FOR DAYLIGHT SAVING  
NEW UNLESS OTHERWISE NOTED
- PC JUNCTION BOX  
NEW UNLESS OTHERWISE NOTED

**LIGHTING NOTES**


- 1 EMERGENCY LIGHT FIXTURE(S) SHALL BE CONNECTED TO BUILDING EMERGENCY CIRCUITS AHEAD OF ANY SWITCHES.
- 2 AT LOCATION INDICATED, DAYLIGHT PHOTOCELL SHALL BE MOUNTED ON TOP OF CANOPY SURFACE.
- 3 AT LOCATIONS INDICATED, CONTRACTOR TO VERIFY LIGHT LOCATION WITH LETTERING.

Seal

Drawing Title


**Lighting Plan  
 and Notes**

North

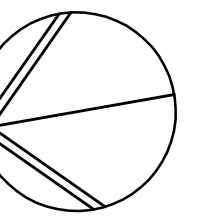

Scale

1/2" = 1'-0"

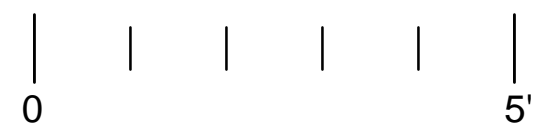

No.	Date	Description
1	06/13/19	Review
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Project 1252

Sheet

**A1.3**