




















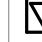





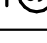
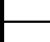
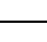
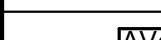
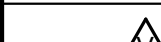






## POWER SYMBOLS

SYMBOL		DESCRIPTION
CEILING MTD	NORMAL WALL MTD	EMERGENCY RECESSED MTD
STUB UP	FLOOR MTD	
SIMPLEX OUTLETS		<u>SUBSCRIPTS</u>
		*AC = ABOVE COUNTER *C = SWITCH CONTROLLED (PER ASHRAE 90.1/CAT24) *GF = GROUND FAULT BREAKER *IG = GROUND FAULT *IG = ISOLATED GROUND *UC = UNDER COUNTER *USB* = w/ USB PORTS *WP = WEATHERPROOF BOX *WR = WEATHER RESISTANT
SPECIALTY OUTLETS (NEMA TYPE AS SHOWN)		
JUNCTION BOX		<u>SUBSCRIPTS</u>
COMBINATION AV, DATA & POWER BOX (SEE APPLICABLE SCHEDULE FOR SIZE, ETC.)		*P = FURNITURE POWER CONNECTION *T = FURNITURE TELECOM CONNECTION
<u>SUBSCRIPTS</u>		
	PUSH BUTTON	
	EQUIPMENT CONNECTION	
	POWER/TELECOM POLE	
	MOTOR	
	MANUAL MOTOR STARTER, FRACTIONAL HORSEPOWER (SEE STARTER SCHEDULE FOR SIZE, ETC.)	
	NON-FUSIBLE SAFETY SWITCH (SEE DISCONNECT SCHEDULE FOR SIZE, ETC.)	
	FUSIBLE SAFETY SWITCH (SEE DISCONNECT SCHEDULE FOR SIZE, ETC.)	
	COMBINATION MOTOR STARTER/SAFETY SWITCH, ENCLOSED CIRCUIT BREAKER (SEE APPLICABLE SCHEDULES FOR SIZE, ETC.)	
	VARIABLE FREQUENCY DRIVE (VFD) (SEE APPLICABLE SCHEDULE FOR SIZE, ETC.)	
	DISCONNECT SWITCH (FURNISHED BY OTHERS)	
	SURGE SUPPRESSOR	
	GROUND BAR	
	GROUND ROD	
		<u>SUBSCRIPTS</u>
		*CR = CHEMICAL ROD *TW = TEST WELL
	SURFACE MOUNTED PLUGMOLD OR WIREMOLD (DEVICE QUANTITIES AND TYPES AS INDICATED)	
	POWER/TELECOMMUNICATIONS HANDHOLE	
	POWER/TELECOMMUNICATIONS MANHOLE	
<b>POWER DISTRIBUTION</b>		
	WALL MOUNTED PANEL (SHADING INDICATES ESSENTIAL BRANCH)	
	RECESSED PANEL (SHADING INDICATES ESSENTIAL BRANCH)	
	ELECTRICAL EQUIPMENT/GEAR SIZE, TYPE, AND MOUNTING AS SHOWN AND/OR NOTED.	
	UTILITY METER	

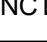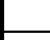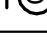








## LIGHTING SYMBOLS

SYMBOL		DESCRIPTION
NORMAL	EMERGENCY CRITICAL	T (BRACKET INDICATES WALL MOUNTED TYP.)
		SURFACE/RECESSED TROFFER LUMINAIRE
		DIRECT/INDIRECT PENDANT LUMINAIRE
		LINEAR WALL MOUNTED LUMINAIRE
		LINEAR RECESSED LUMINAIRE (RAY INDICATES DIRECTION OF WALL WASH)
		STRIP LUMINAIRE - SIZE AND TYPE AS SHOWN
		SURFACE/RECESSED CAN LUMINAIRE (RAY INDICATES DIRECTION OF WALL WASH)
		WALL SCONCE LUMINAIRE
		DECORATIVE/SPECIALTY LUMINAIRE (BY OTHERS, SIZE AND TYPE AS SHOWN)
		SITE LUMINAIRE - BOLLARD LUMINAIRE (RAY INDICATES DIRECTIONALITY)
		SITE LUMINAIRE - POLE MOUNTED LUMINAIRE (HEAD QUANTITY AND ORIENTATION AS SHOWN)
		SITE LUMINAIRE POST TOP (RAY INDICATES DIRECTIONALITY)
		SITE LINEAR LUMINAIRE (RAY INDICATES DIRECTIONALITY)
		SITE LUMINAIRE - IN-ON-GRADE ACCENT/SPOT LUMINAIRE
		CEILING MOUNTED EXIT SIGN FACES AND CHEVRONS AS SHOWN
		CEILING MOUNTED COMBINATION EXIT SIGN AND EMERGENCY LIGHT - FACES AND CHEVRONS AS SHOWN
		WALL MOUNTED EXIT SIGN FACES AND CHEVRONS AS SHOWN
		WALL MOUNTED COMBINATION EXIT SIGN AND EMERGENCY LIGHT - FACES AND CHEVRONS AS SHOWN
		REMOTE EMERGENCY HEAD
		REMOTE EMERGENCY BATTERY
		WALL MOUNTED EMERGENCY LUMINAIRE
		EMERGENCY LIGHTING CONTROL DEVICE
		TRACK LUMINAIRE
		SWITCH
		OCCUPANCY SENSORS
		OCCUPANCY SENSORS (LONG RANGE)
		DAYLIGHT SENSORS
		PHOTOCELL
		LIGHTING CONTROL PANEL, SURFACE - TYPE (CONTACTOR, RELAY, ROOM CONTROLLER, ETC.) AS SHOWN
		LIGHTING CONTROL PANEL, RECESSED - TYPE (CONTACTOR, RELAY, ROOM CONTROLLER, ETC.) AS SHOWN
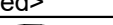
## AV, DATA & TELECOMMUNICATIONS SYMBOLS

SYMBOL				DESCRIPTION
CEILING MTD	WALL MTD	POST MTD	FLOOR MTD	
				CATV OUTLET
				<u>SUBSCRIPTS</u>
				DATA OUTLET
				"F" = OUTLET QTY "AC" = ABOVE COUNTER "IP" = INMATE PHONE "UC" = UNDER COUNTER "WAP" = WIRELESS ACCESS POINT "WP" = WEATHERPROOF BOX
				COMBINATION TELEPHONE & DATA OUTLET
				TELEPHONE OUTLET
				JUNCTION BOX
				<u>SUBSCRIPTS</u>
				CLOCK
				"F" = FURNITURE POWER CONNECTION "T" = FURNITURE TELECOM CONNECTION
				SPEAKER
				FLAT PANEL DISPLAY
				AV CONTROL PANEL
				AV INTERFACE PANEL
				VOLUME CONTROL
				MICROPHONE JACK
				POWER/TELECOMMUNICATIONS POLE
				POWER/TELECOMMUNICATIONS HANDHOLE
				POWER/TELECOMMUNICATIONS MANHOLE

## CIRCUIT SYMBOLS

WIRES	DESCRIPTION
	HOME RUN. NUMERALS INDICATE PANELBOARD AND CIRCUIT NUMBERS.
	HOME RUN. MULTIPLE ARROWS INDICATES NUMBER OF CIRCUITS INCLUDED IN CONDUIT (1, 2 OR 3).
	UNCONTROLLED/UNSWITCHED CIRCUIT
	INDICATES CIRCUIT CONTINUATION
	STUB INTO ACCESSIBLE CORRIDOR CEILING SPACE UNO
	CAP END OF CONDUIT
	INDICATES CONDUIT RISER UP
	INDICATES CONDUIT RISER DOWN
	CONDUIT SLEEVE

## **STANDARD WALL MOUNTING HEIGHTS**

DEVICE OR EQUIPMENT TYPE	MOUNTING HEIGHT (AFF/AFG)	MEASURED TO	NOTES
EMERGENCY LIGHTS	96"	TOP	1, 2
ENCLOSED CIRCUIT BREAKERS	78"	TOP	1, 3
EXIT SIGNS	SEE NOTES	TOP	1, 4
FA NOTIFICATION DEVICES	84"	BOTTOM	1
FA PULL STATIONS	48"	TOP	1
LIGHT SWITCHES	48"	TOP	1
PANELBOARDS	78"	TOP	1, 3
PLUGMOLD AND WIREMOLD	SEE NOTES	TOP	1, 5
RECEPTACLES - NORMAL AREAS	18"	CENTER	1
RECEPTACLES - ABOVE COUNTER	SEE NOTES	TOP	1, 5
RECEPTACLES - EXTERIOR AREAS	18"	CENTER	1
RECEPTACLES - UNDER COUNTER	18"	CENTER	1
SAFETY SWITCHES	78"	TOP	1, 3
SENSORS - WALL MOUNTED	96"	TOP	1, 2

## NOTES

1. UNLESS NOTED OTHERWISE, WALL MOUNTING HEIGHTS INDICATED ON DRAWINGS OR DETAILS SHALL SUPERSEDE STANDARD WALL MOUNTING HEIGHTS LISTED HERE. COORDINATE ALL DEVICE LOCATIONS WITH OTHER TRADES PRIOR TO INSTALLATION. COORDINATE EXACT HEIGHT AND LOCATION WITH ARCHITECTURAL INTERIOR ELEVATIONS AND CASEWORK SHOP DRAWINGS PRIOR TO INSTALLATION. ADJUST TO MATCH MASONRY COURSES, IF APPLICABLE. MOUNT ALL BOXES TRUE AND PLUMB.
2. CEILING HEIGHT PERMITTING, OTHERWISE MOUNT 12" BELOW CEILING TO TOP OF BOX.
3. MOUNTING HEIGHT AS MEASURED TO TOP OF ENCLOSURE OR CENTER OF OPERATING HANDLE AT HIGHEST POSITION, WHICHEVER IS HIGHER. STACKING OF CIRCUIT SWITCHES, ENCLOSED CIRCUIT BREAKERS AND MOTOR STARTERS IS PERMITTED.
4. CEILING HEIGHT PERMITTING, MOUNT EXIT SIGN 18" ABOVE TOP OF DOOR FRAME AS MEASURED FROM TOP OF SIGN. FOR ALL OTHER AREAS AND CEILING HEIGHT PERMITTING, MOUNT 96" AFF TO TOP OF BOX. OTHERWISE, MOUNT 12" BELOW CEILING TO TOP OF BOX.
5. MOUNT 6" ABOVE COUNTERTOP OR BACKSPLASH (IF APPLICABLE) TO TOP OF BOX. COORDINATE EXACT HEIGHT AND LOCATION WITH ARCHITECTURAL INTERIOR ELEVATIONS AND CASEWORK SHOP DRAWINGS PRIOR TO INSTALLATION.

## STANDARD DETAILING SYMBOLS

	SYMBOL	DESCRIPTION
		CALLOUT
		BUILDING/WALL SECTION
		VIEW TITLE
		LEVEL LINE
		GRID LINE
		NORTH INDICATOR
		ROOM TAG
		REVISION TAG
		REVISION CLOUD
		KEYNOTE TAG (PER SHEET NUMBERS)
		SPOT ELEVATION SYMBOL
		POINT OF CONNECTION
		POINT OF DISCONNECTION
	LINETYPES	
	_____	BACKGROUND
	_____	EXISTING
	-----	DEMOLITION
	_____	NEW
	_____	FUTURE
	_____	HIDDEN/UNDER OBSTRUCTION

## DRAWING LIST - ELECTRICAL

E-001	ELECTRICAL SYMBOLS & ABBREVIATIONS
E-002	ELECTRICAL SPECIFICATIONS
E-101	ELECTRICAL SITE PLAN
E-111	ELECTRICAL PAVILION PLAN
E-501	ELECTRICAL DETAILS
E-601	SCHEDULES AND DIAGRAMS
Grand total: 6	

## ABBREVIATIONS - ELECTRICAL

THIS IS A MASTER ABBREVIATIONS LIST. SOME ABBREVIATIONS MAY NOT APPLY TO THIS PROJECT.

AMP	AMPERE
AC	ALTERNATING CURRENT
ADA	AMERICANS WITH DISABILITIES ACT
AF	AMPERE FRAME
AFCI	ARC FATAL CIRCUIT INTERRUPTER
AFF	ABOVE FINISH FLOOR
AHJ	AUTHORITY HAVING JURISDICTION
AIC	AMPERES INTERRUPTING CAPACITY
AL	ALUMINUM
ANSI	AMERICAN NATIONAL STANDARDS INSTITUTE
AT	AMPERE TRIP
ATC	AUTOMATIC TRANSFER SWITCH
AWG	AMERICAN WIRE GAUGE
BAS	BUILDING AUTOMATION SYSTEM
BLDG	BUILDING
BMS	BUILDING MANAGEMENT SYSTEM
BKRR, BKR	BREAKER
C	CONDUIT
C/B, CB	CIRCUIT BREAKER
CATV	CABLE TELEVISION
CCTV	CLOSED CIRCUIT TELEVISION
CD	CANDELA
CKT	CIRCUIT
CL	CENTERLINE
CL	CEILING
COL	COLUMN
COMM	COMMUNICATION
CRI	COLOR RENDERING INDEX
CT	CURRENT TRANSFORMER
CU	COPPER
DC	DECIBEL
DC	DIRECT CURRENT
DB	DOWN
DWG	DRAWING
E, EX. (E)	EXISTING
EA	EACH
EC	ELECTRICAL CONTRACTOR
ECB	ENCLOSED CIRCUIT BREAKER
EGC	EQUIPMENT GROUNDING CONDUCTOR
ELEC	ELECTRIC, ELECTRICAL
ELEV	ELEVATOR
EM, EMERG	EMERGENCY
EMCS	ENERGY MANAGEMENT CONTROL SYSTEM
ENR	ENGINEERING MACHINE ROOM
EMT	ELECTRICAL METALLIC TUBING
EO	ELECTRICALLY OPERATED
EOL	END OF LINE RESISTOR
EPO	EMERGENCY POWER OFF
ERMS	ENERGY REDUCTION MAINTENANCE SWITCH
F	FUSE
FA	FIRE ALARM
FC	FULL-CANDLE
FCA	FAULT CURRENT AVAILABLE
FCL	FAULT CURRENT RATING
FLA	FULL LOAD AMPS
FLR	FLOOR
FSS	FUSED SAFETY SWITCH
FTL	FUSED THRU LUGS
FURN	FURNITURE
G, GND	GROUND
GEN	GENERATOR

## ABBREVIATIONS - ELECTRICAL

THIS IS A MASTER ABBREVIATIONS LIST. SOME ABBREVIATIONS MAY NOT APPLY TO THIS PROJECT.

GFI, GF, GFI	GROUND FAULT CIRCUIT INTERRUPTER
GFP	GROUND FAULT PROTECTION
GRC, GRMC	GALVANIZED RIGID METALLIC CONDUIT
HID	HIGH INTENSITY DISCHARGE
HOA	HAND OFF AUTO
HP	HORSE POWER
HV	HIGH VOLTAGE
HVAC	HEATING, VENTILATION AND AIR CONDITIONING
HZ	HERTZ, FREQUENCY
IDF	INTERMEDIARY DISTRIBUTION FRAME
IG	ISOLATED GROUND
JB, JBOX	JUNCTION BOX
K	KELVIN
KCMIL, MCM	THOUSAND CIRCULAR MILLS
KK	KIRK KEY
KV	KILOVOLT
KVA	KILOVOLT-AMPERES
KW	KILOWATT
KWH	KILOWATT-HOUR
LC, CP	LIGHT CONTROL PANEL
LED	LIGHT EMITTING DIODE
LFMC	LIQUID TIGHT FLEXIBLE METALLIC CONDUIT
LRA	LOCKED ROTOR AMPS
LS	LIFE SAFETY
LSIG	LONG, SHORT, INSTANTANEOUS & GROUND
LTG	LIGHTING
LTS	LIGHTS
LV	LOW VOLTAGE
MC	METAL CLAD CABLE
MCA	MINIMUM CIRCUIT AMPACITY
MCC	MAIN CIRCUIT BREAKER
MCC	MOTOR CONTROL CENTER
MCCB	MOLDED CASE CIRCUIT BREAKER
MDCB	MAIN DISTRIBUTION FRAME
MDP	MAIN DISTRIBUTION PANEL
MECH	MECHANICAL
MFR	MANUFACTURER
MI	MINERAL INSULATED
MLO	MAIN LUGS ONLY
MOCP	MOLDED OVERCURRENT PROTECTION
MTS	MANUAL TRANSFER SWITCH
MV	MEDIUM VOLTAGE
MW	MEGAWATT
N.C.	NORMALLY CLOSED
N.O.	NORMALLY OPEN
NO	NOT AVAILABLE
NEMA	NATIONAL ELECTRIC CODE
NEMA	NATIONAL ELECTRICAL MANUFACTURERS ASSOCIATION
NF	NON-FUSED
NFPA	NATIONAL FIRE PROTECTION ASSOCIATION
NFSA	NON-FUSED SAFETY SWITCH
NIC	NOT IN CONTRACT
NIC	NOT TO SCALE
NCPS	OVERCURRENT PROTECTIVE DEVICE
NP	POLE
P	PULL BOX
PH, Ø	PHASE
PLC	PROGRAMMABLE LOGIC CONTROLLER
PNC	PANEL

## ABBREVIATIONS - ELECTRICAL

THIS IS A MASTER ABBREVIATIONS LIST. SOME ABBREVIATIONS MAY NOT APPLY TO THIS PROJECT.

POE	POWER OVER ETHERNET
PT	POTENTIAL TRANSFORMER
PVC	POLYVINYL CHLORIDE
PWR	POWER
QTY	QUANTITY
R	REMOVE
RCP	REFLECTED CEILING PLAN
REC, RECP	RECEPTACLE
REQ, REQ'D	REQUIRED
RMC	RIGID METALLIC CONDUIT
RNC	RIGID NON-METALLIC CONDUIT
RNS	REMOTE TEST SWITCH
RSP	REMOTE PROTECTIVE DEVICE
SPTD	SINGLE POLE DOUBLE THROW
SSST	SINGLE POLE SINGLE THROW
SS	SAFETY SWITCH
ST	SHUNT TRIP
SWBD	SWITCHBOARD
SWGR	SWITCHGEAR
SYM	SYMBOL
TEL, TELE	TELEPHONE
TEMP	TEMPORARY
TGB	TELECOMMUNICATIONS GROUND BAR
THD	TOTAL HARMONIC DISTORTION
TYP	TYPICAL
UG	UNDERGROUND
UL	UNDERWRITERS' LABORATORY
UNO	UNINTERRUPTED OTHERWISE
UPS	UNINTERRUPTABLE POWER SUPPLY
USB	UNIVERSAL SERIAL BUS
V	VOLTS
VA	VOLT AMPERES
VDF/VFC	VARIABLE FREQUENCY DRIVE
VOIP	VOICE OVER INTERNET PROTOCOL
W	WIRE
W	WATT
WG	WIRE GUARD
WP	WEATHERPROOF
XFMR	TRANSFORMER

NAVY FEDERAL CREDIT UNION

3320 FOLLIN LANE SE  
VIENNA, VA 22180  
PROGRESS SET



## KEY PLAN

## SCALE

## REVISIONS

[illegible]

DRAWN BY	_____	PH
APPROVED BY	_____	RH

DATE OCTOBER 23, 2025

**TITLE**

# ELECTRICAL SYMBOLS & ABBREVIATIONS

PROJECT NO.	50188638
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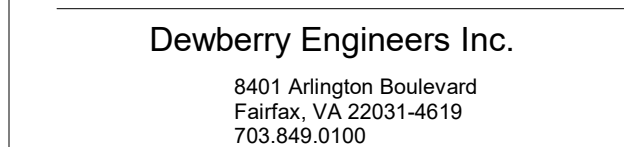
E-001







1. ELECTRICAL EQUIPMENT, PULL BOXES, CONDUIT, AND ELECTRICAL DEVICES INDICATED ON PLAN ARE NEW, UNLESS NOTED OTHERWISE.
2. THE CONTRACTOR SHALL COORDINATE WITH THE ARCHITECTURAL DRAWINGS AND FIELD CONDITIONS REGARDING EXACT AND FINAL LOCATION(S) & ELEVATION(S) OF ELECTRICAL EQUIPMENT AND CONDUIT ROUTING.



SEAL

COMMONWEALTH OF VIRGINIA

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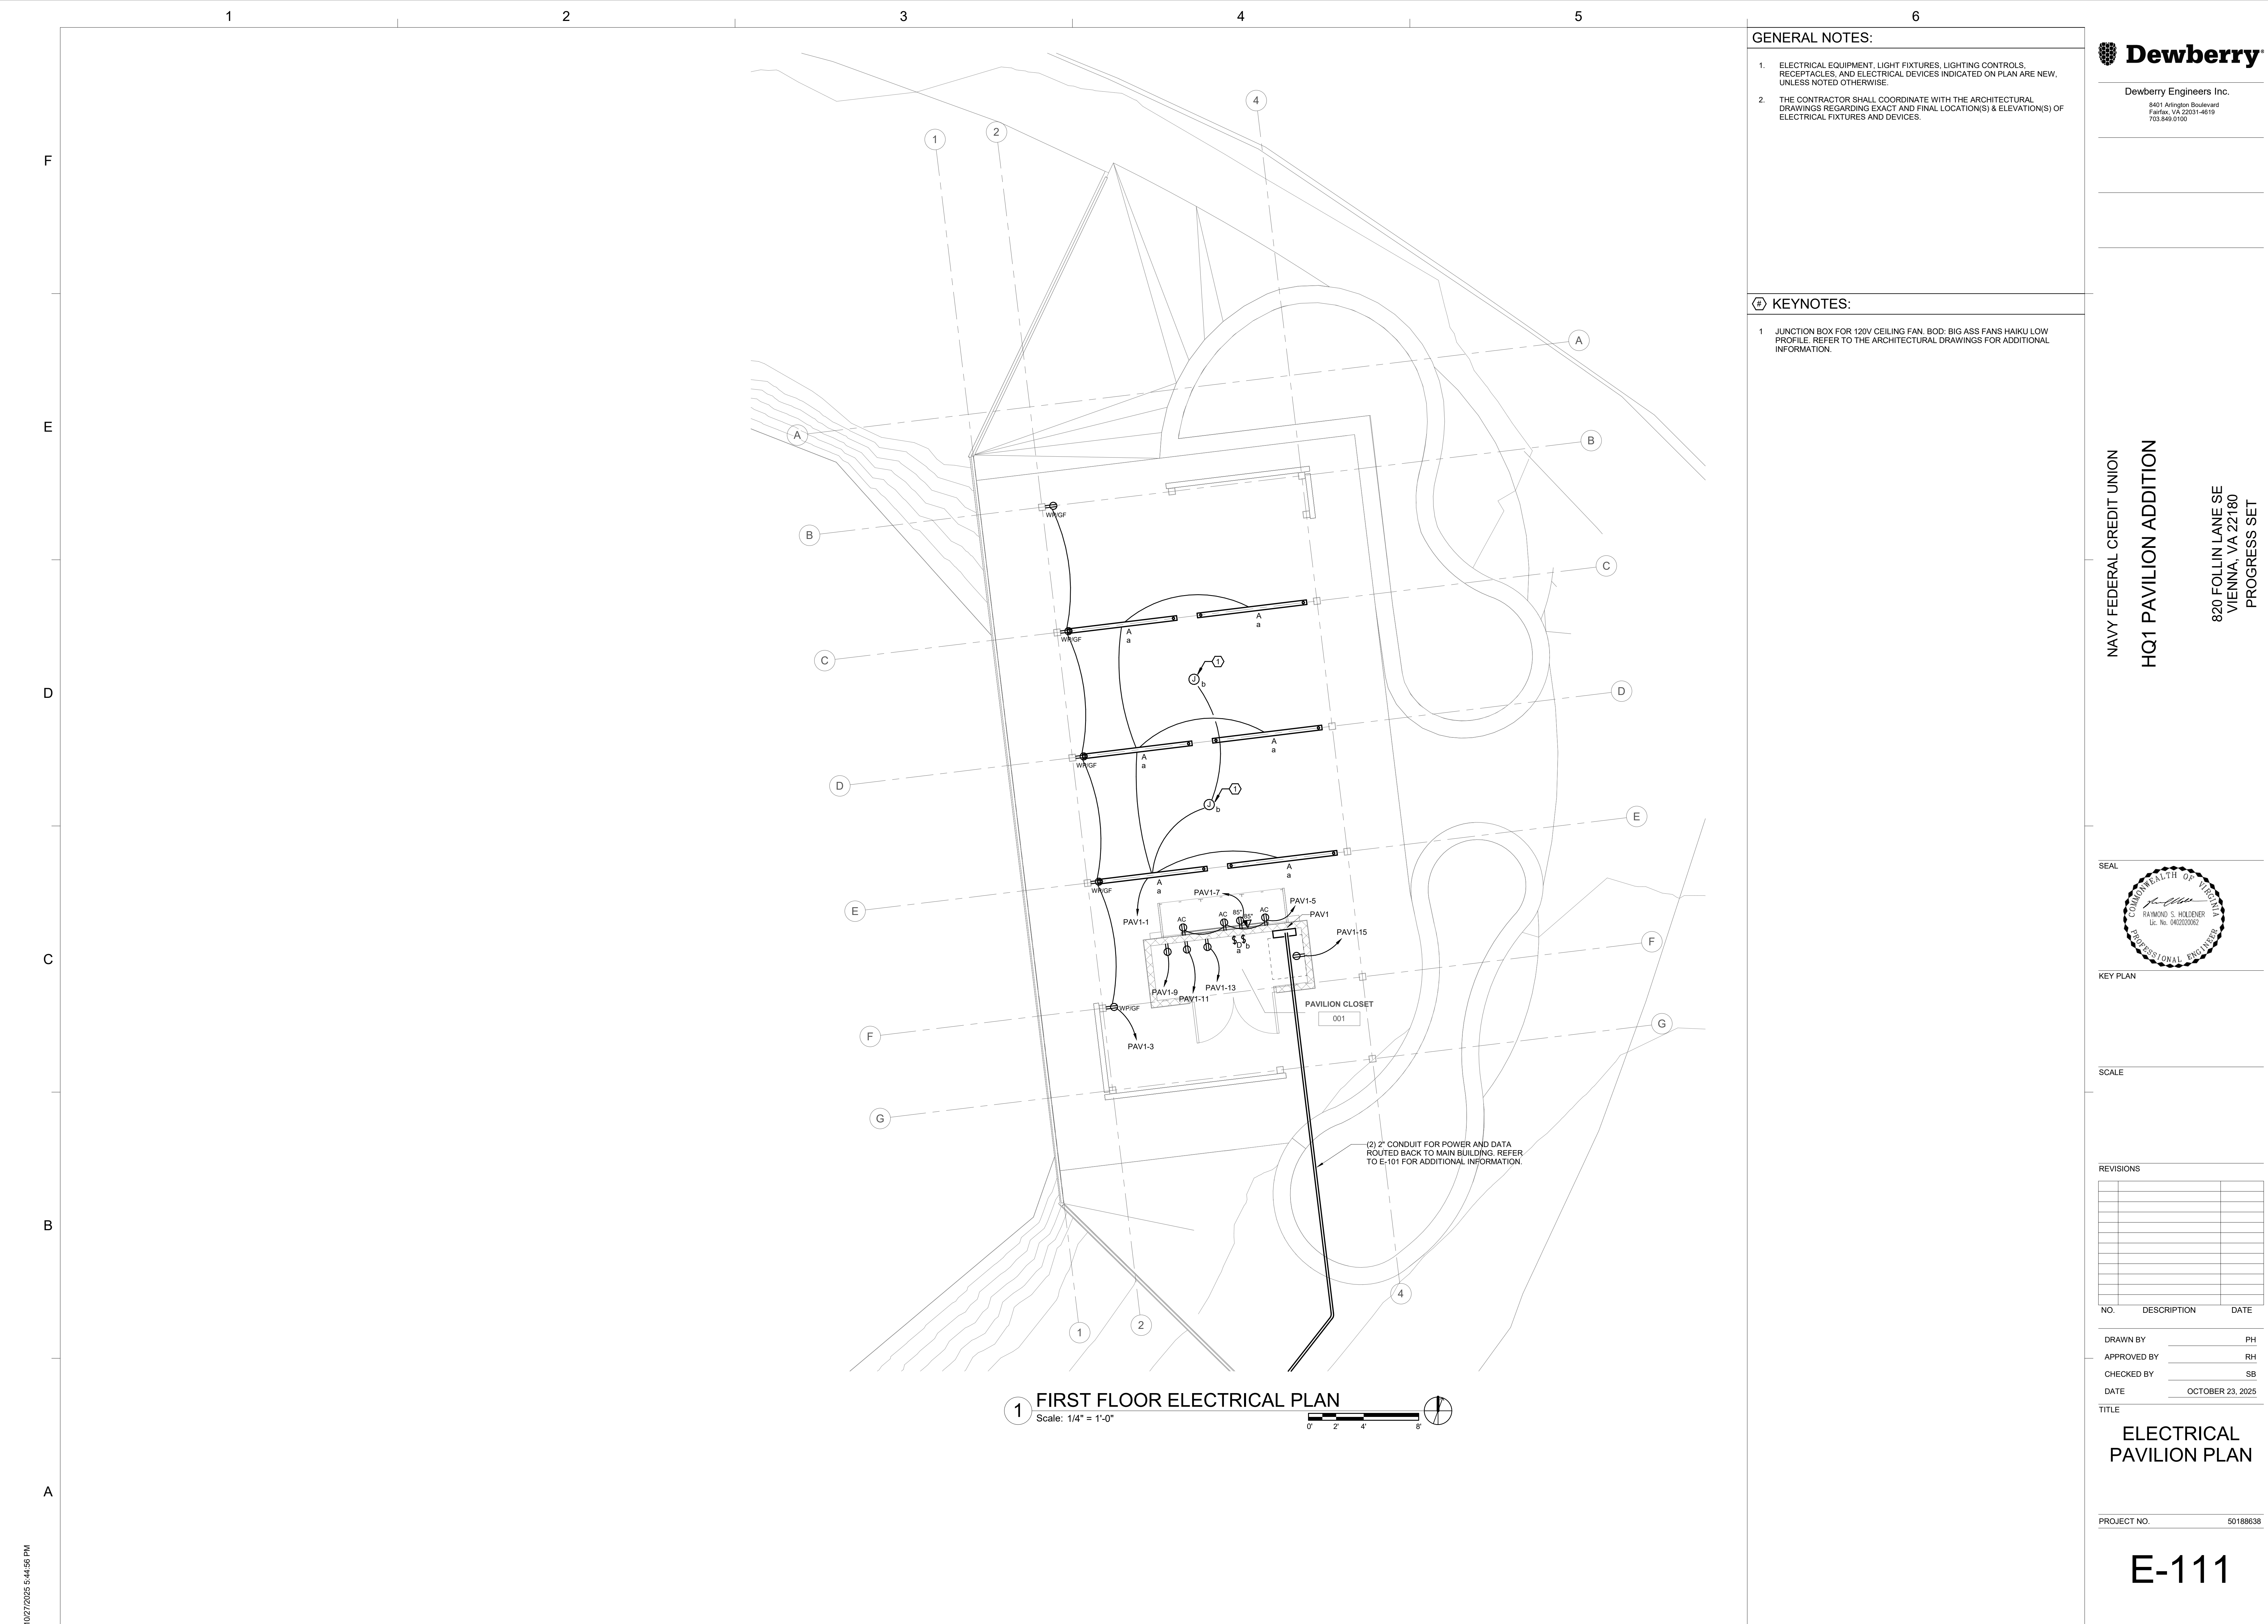
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DRAWN BY	Author
APPROVED BY	Approver
CHECKED BY	Checker
DATE	OCTOBER 23, 2025
TITLE	

## ELECTRICAL SITE PLAN

PROJECT NO.	50188638
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E-101



GENERAL NOTES:

1. ELECTRICAL EQUIPMENT, LIGHT FIXTURES, LIGHTING CONTROLS, RECEPTACLES, AND ELECTRICAL DEVICES INDICATED ON PLAN ARE NEW, UNLESS NOTED OTHERWISE.
2. THE CONTRACTOR SHALL COORDINATE WITH THE ARCHITECTURAL DRAWINGS REGARDING EXACT AND FINAL LOCATION(S) & ELEVATION(S) OF ELECTRICAL FIXTURES AND DEVICES.

KEYNOTES:

- 1 JUNCTION BOX FOR 120V CEILING FAN. BOD: BIG ASS FANS HAIKU LOW PROFILE. REFER TO THE ARCHITECTURAL DRAWINGS FOR ADDITIONAL INFORMATION.



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VIENNA, VA 22180  
PROGRESS SET

SEAL



KEY PLAN

SCALE

REVISIONS

NO.	DESCRIPTION	DATE

DRAWN BY \_\_\_\_\_ PH  
APPROVED BY \_\_\_\_\_ RH  
CHECKED BY \_\_\_\_\_ SB  
DATE \_\_\_\_\_ OCTOBER 23, 2025  
TITLE

ELECTRICAL  
PAVILION PLAN

PROJECT NO. 50188638

E-111

NOTE:

1. THIS FIGURE ILLUSTRATES THE WORKING SPACE IN FRONT OF THE ELECTRICAL EQUIPMENT REQUIRED BY SECTION 110.26(A) AND 110.26(F) OF THE NATIONAL ELECTRICAL CODE.




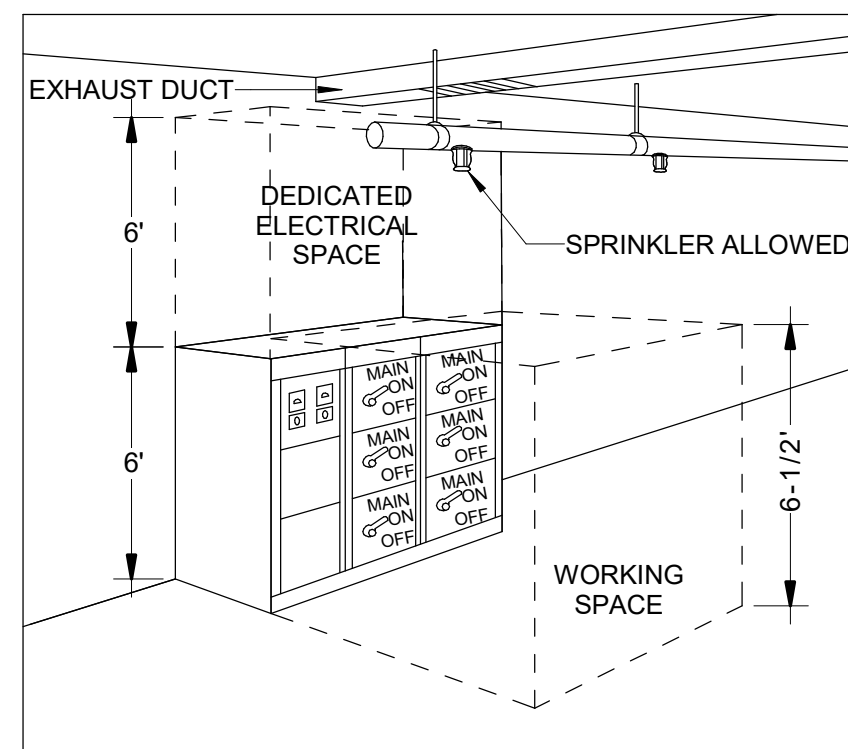


TABLE A - WORKING SPACES				
VOLTAGE TO GROUND NOMINAL	CONDITION:	MINIMUM CLEAR DISTANCE FEET		
		1	2	3
0-150		3	3	3
151-600		3	3-1/2	4

WHERE THE "CONDITIONS" ARE AS FOLLOWS

1. EXPOSED LIVE PARTS ON ONE SIDE AND NO LIVE OR GROUNDED PARTS ON THE OTHER SIDE OF THE WORKING SPACE, OR EXPOSED LIVE PARTS ON BOTH SIDES EFFECTIVELY GUARDED BY SUITABLE WOOD OR OTHER INSULATING MATERIALS. INSULATED WIRE OR INSULATED BUSBARS OPERATING AT NOT OVER 300V TO GROUND SHALL NOT BE CONSIDERED LIVE PARTS.
2. EXPOSED LIVE PARTS ON ONE SIDE AND GROUNDED PARTS ON THE OTHER SIDE. (CONCRETE BRICK OR TILE WALLS SHALL BE CONSIDERED AS GROUNDED.)
3. EXPOSED LIVE PARTS ON BOTH SIDES OF THE WORK SPACE (NOT GUARDED AS PROVIDED IN CONDITION 1) WITH THE OPERATOR BETWEEN.

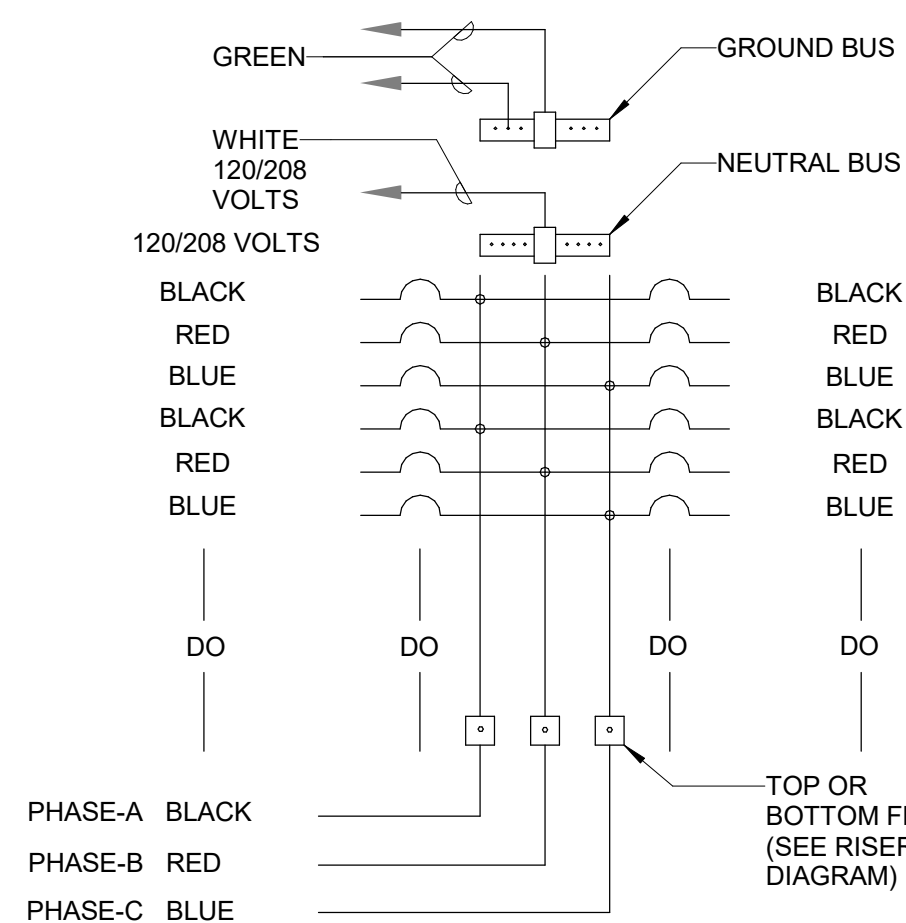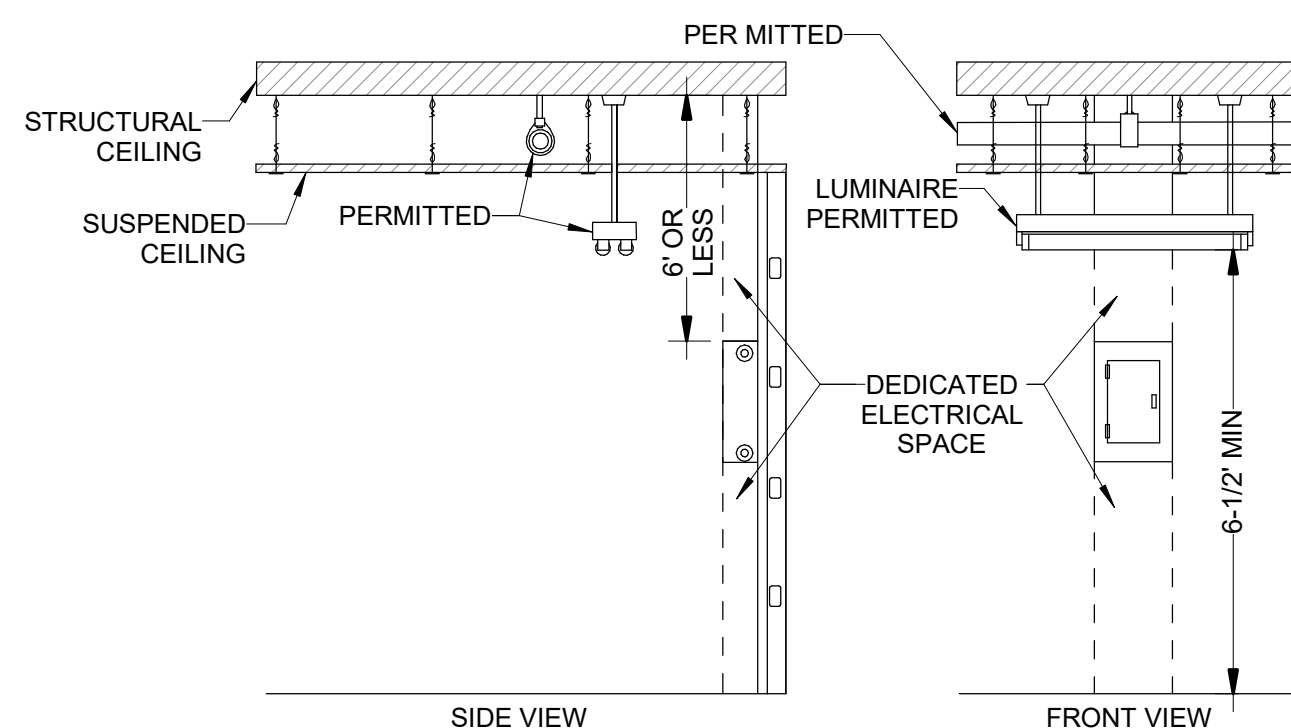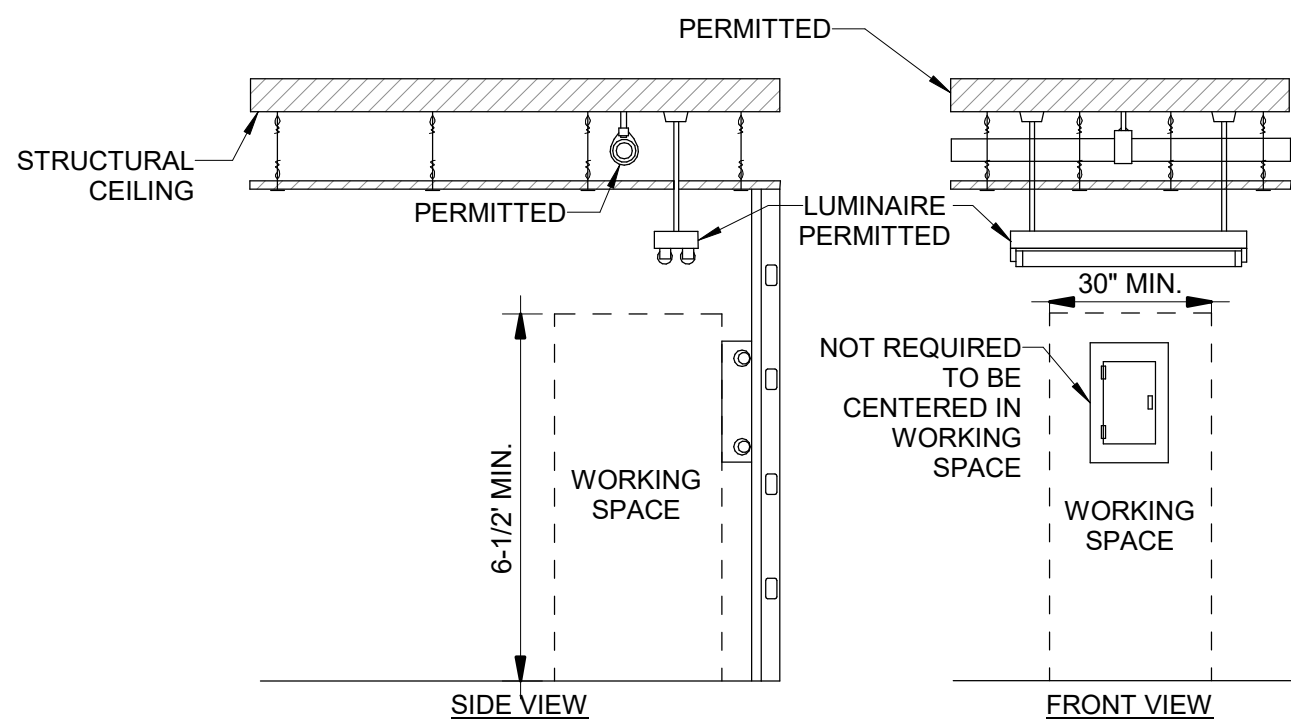


## 1 WIRE COLOR CODING 120/208V

Scale: N.T.S.

## WORKING CLEARANCE FOR ELECTRICAL EQUIPMENT


Scale: N.T.S.

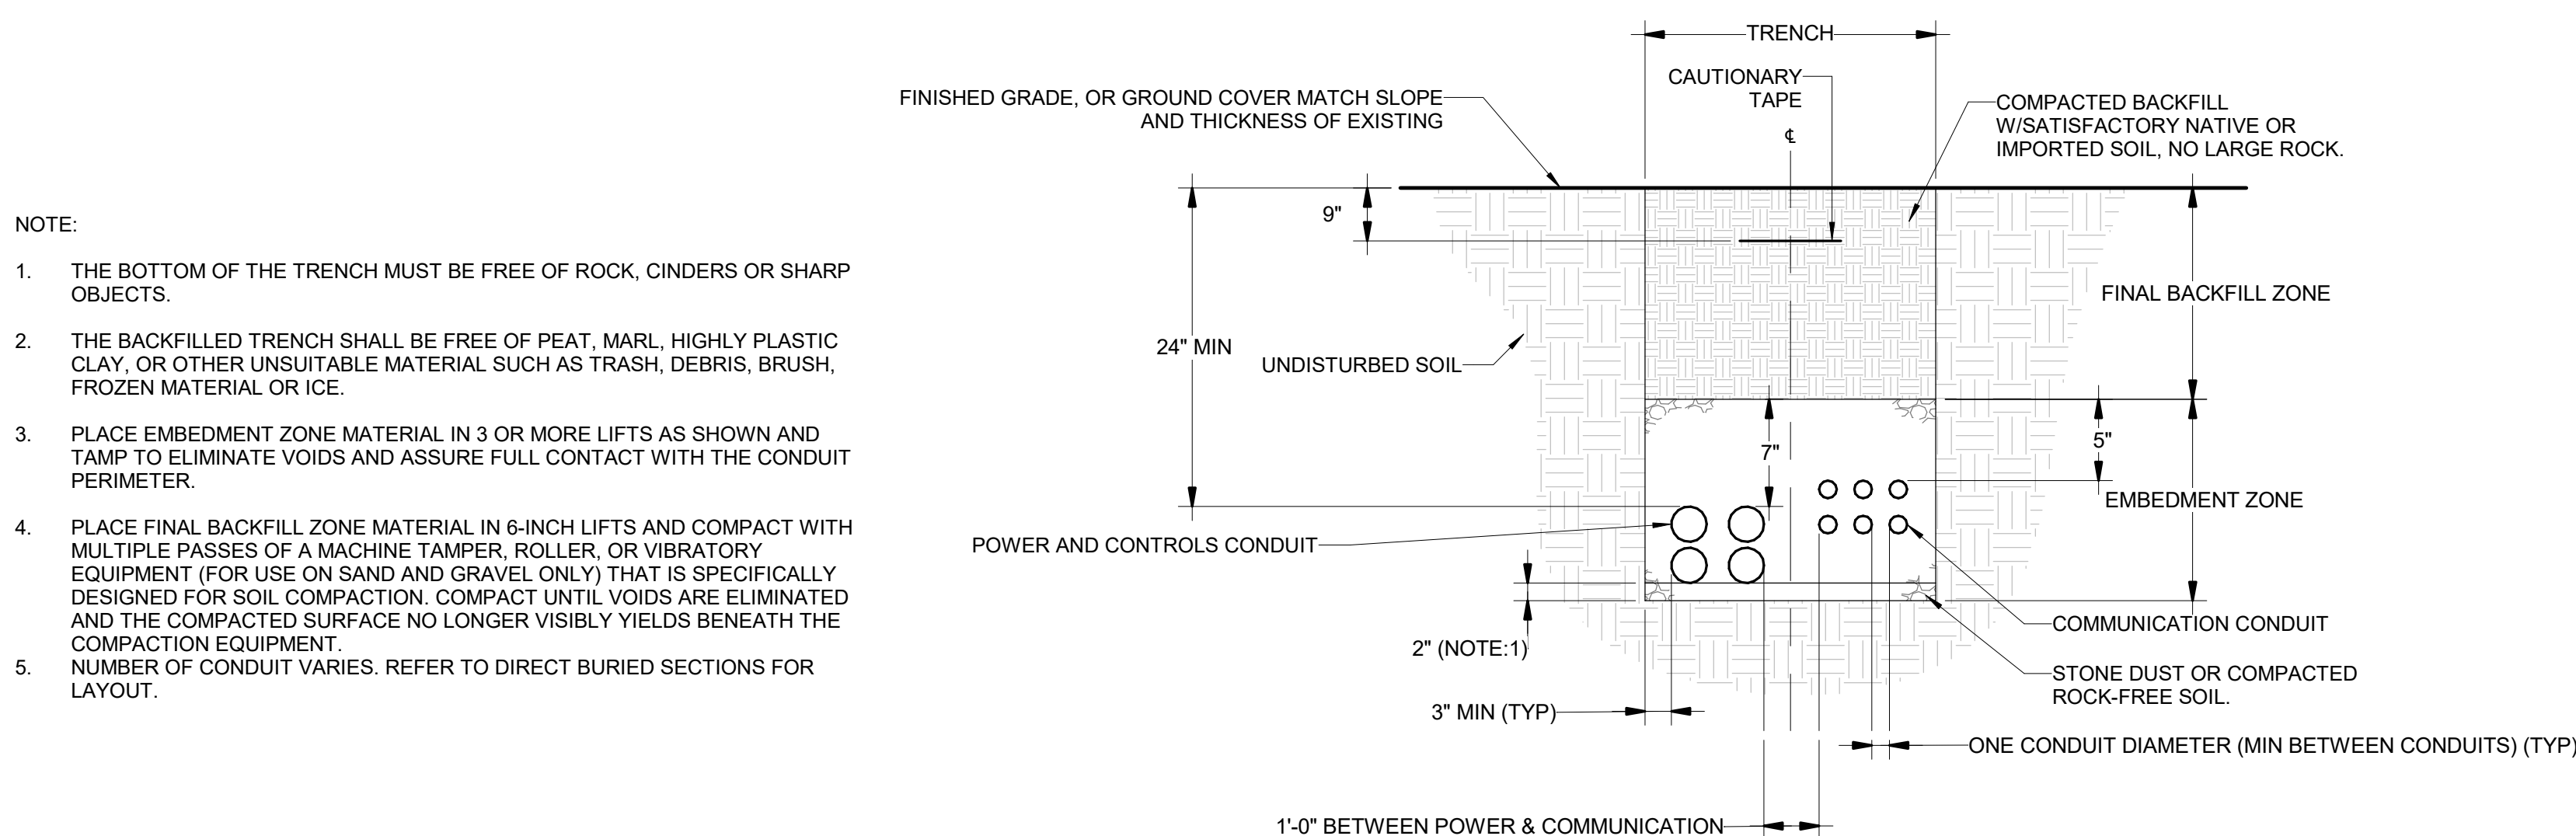

## 2 TYPICAL DIRECT BURIED CONDUIT INSTALLATION

Scale: N.T.S.

- NOTES:
1. HOUSING SHALL BE A POLYMER CONCRETE REINFORCED WITH A HEAVY WEAVE FIBERGLASS REINFORCING WITH COMPRESSIVE STRENGTH OF NO LESS THAN 10,000 psi.
  2. COVER AND BOX SHALL WITHSTAND A SERVICE LOAD OF NO LESS THAN 15,000 LBS OVER A 10" X 10" AREA.
  3. PROVIDE STAINLESS STEEL BOLTS AND INSERTS.
  4. PROVIDE WITH (2) 2-1/2" MOUSE HOLES.
  5. COVER LABEL SHALL READ "ELECTRICAL".

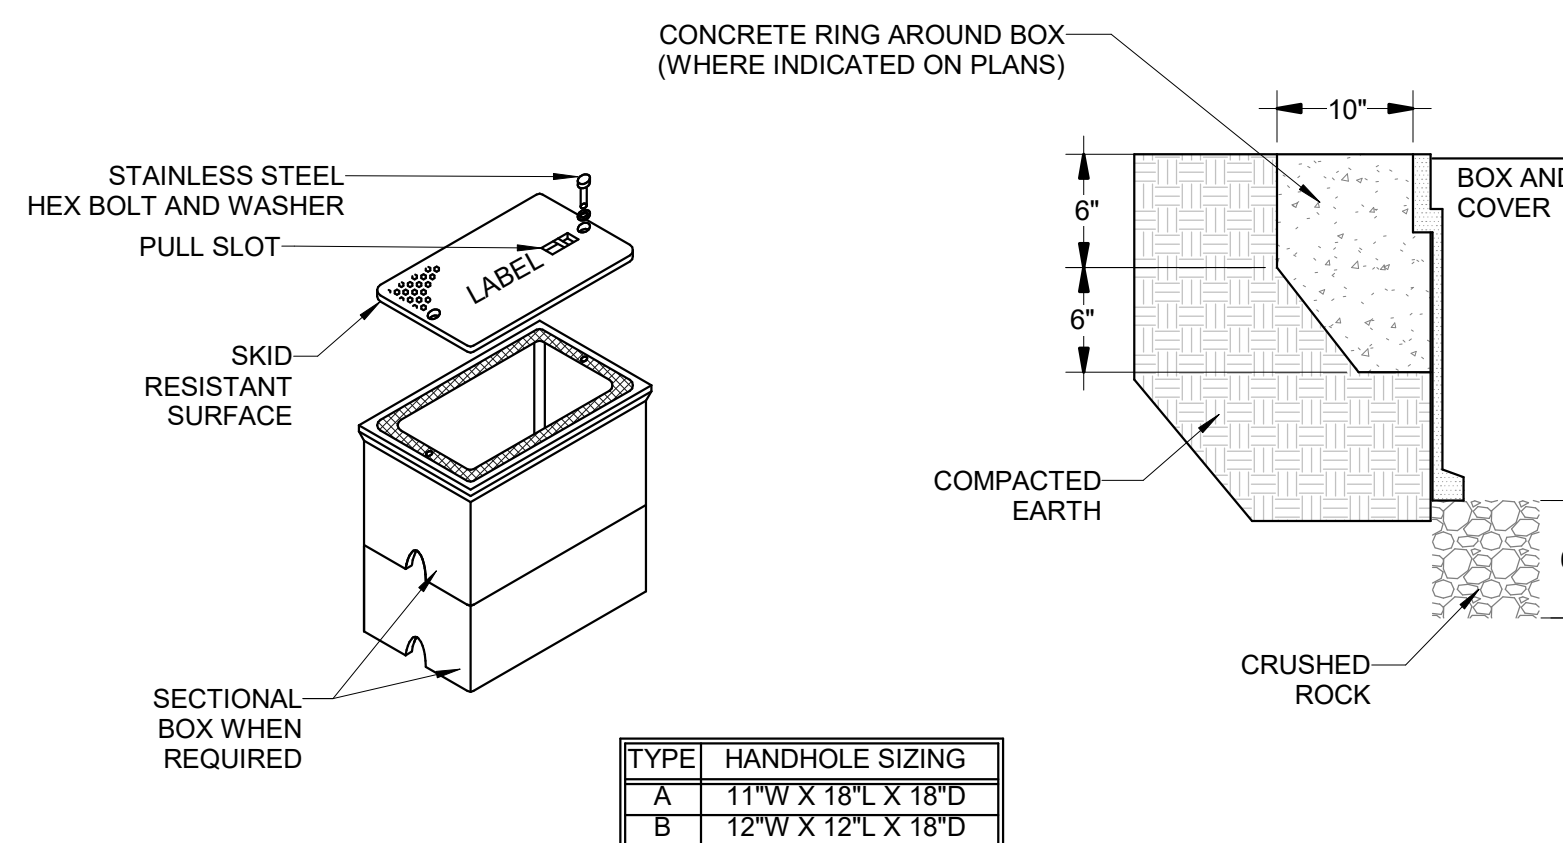

## 4 HANDHOLE DETAIL

Scale: N.T.S.

