- 1. TAX MAP# : 0391 12 0039
- 2. BOUNDARY INFORMATION WAS TAKEN FROM THE AVAILABLE RECORDS. NO TITLE REPORT WAS FURNISHED.
- 3. THE LOCATIONS AND DEPTH OF ALL UNDERGROUND UTILITIES SHOWN HEREON WERE TAKEN FROM AVAILABLE RECORDS AND ARE APPROXIMATE.THE LOCATIONS AND DEPTHS OF ALL EXISTING UNDERGROUND UTILITIES ARE TO BE VERIFIED BY THE CONTRACTOR PRIOR TO THE START OF CONSTRUCTION. INTERFERENCE OR DISRUPTION OF SAME WILL BE THE RESPONSIBILITY OF THE CONTRACTOR.
- 4. THE TOPOGRAPHY SHOWN HEREON IS BASED ON A FIELD RUN SURVEY PERFORMED BY THIS FIRM. THE DATUM IS BASED ON RIM ELEVATION OF THE SEWER MANHOLE AT THE LOCATION SHOWN ON THE SITE PLAN.
- 5. CONTRACTOR/OWNER:

M AND Z CONSTRUCTION AND CONSULTING LLC 4568 SUPERIOR SQ, FAIRFAX, VA 22030 EMAIL: MIRWAISZOHORI@GMAIL.COM PHONE: 571-623-5107

- 6. THE LOT DOES NOT FALLS WITHIN THE TOWN'S RESOURCE MANAGEMENT AREA (RMA).
- 7. THIS LOT IS NOT LOCATED WITHIN THE 100-YR FLOODPLAIN.
- 8. ALL THE DAMAGES TO EXISTING ROAD AS A RESULT OF CONSTRUCTION ACTIVITIES SHALL BE THE RESPONSIBILITY OF THE DEVELOPER/CONTRACTOR AND WILL BE RESTORED TO THE SATISFACTION OF DEPARTMENT OF PUBLIC WORK, TOWN OF VIENNA.
- 9. ALL CONSTRUCTION SHALL CONFORM TO THE CURRENT STANDARDS AND SPECIFICATIONS OF TOWN OF VIENNA.
- 10. NO GRAVE OR BURIAL SITE IS KNOWN TO EXIST ON THIS PROPERTY.
- 11. ANY DAMAGES TO THE PUBLIC STREET AND WALKWAY SHALL BE RESTORED TO THE ORIGINAL OR BETTER CONDITIONS.

GRADING NOTES

ALL FOOTING SHALL BE SET A MINIMUM OF 30" BELOW FINAL GRADE IN ORDER TO PROVIDE ADEQUATE FROST COVER PROTECTION.

THE AREA LOCATED ADJACENT TO DWELLING IS TO BE SLOPED AT 5 % AWAY FROM THE FOUNDATION WALL IN ORDER TO PROVIDE POSITIVE DRAINAGE AWAY FROM DWELLING.

NO DOWNSPOUTS TO BE DIRECTED STRAIGHT TO THE NEIGHBOR PROPERTY.

CONTRACTOR TO ENSURE POSITIVE DRAINAGE ACROSS ALL SURFACES TO PRECLUDE THE PONDING OF WATER EITHER IN YARDS OR ON PAVED SURFACES. THIS DOES NOT APPLY TO PONDING ASSOCIATED WITH STORMWATER MANAGEMENT FACILITIES.

A SMOOTH GRADE SHALL BE MAINTAINED ACROSS ALL PAVEMENT SURFACES TO PRECLUDE FORMING OF FALSE GUTTERS AND/OR THE PONDING OF WATER IN THE ROADWAY. FINISH PAVING SURFACES SHALL BE FLUSHED WITH ABUTTING SURFACES AT THE SAME ELEVATION (I.E. GUTTERS, SIDEWALK, APRONS, ETC).

ANY PROPOSED STRUCTURAL FILL MATERIALS MUST HAVE APPROVAL OF THE GEOTECHNICAL CONSULTANT PRIOR TO PLACEMENT OF COMPACTION. FILL MATERIALS SHALL BE COMPACTED IN ACCORDANCE WITH THE GEOTECHNICAL ENGINEERS SPECIFICATIONS AND UNDER HIS/HER GUIDANCE.

SANITARY SEWER LATERAL CONNECTION FROM PUBLIC MAIN TO REMAIN THE SAME; BUT TO BE VERIFIED BY THE TOWN OF VIENNA WATER AND SEWER INSPECTOR. A NEW 1" WATER SERVICE SHALL BE WET-TAPPED INTO THE MAIN AND NEW 1" METER IS REQUIRED.

ALL UTILITY SERVICES CONNECTION MUST BE DONE PER VIENNA TOWN CODE (§18-172.1) UNDERGROUND UTILITY SERVICES, IN ACCORDANCE WITH ACCEPTED STANDARDS OF UTILITY PRACTICE FOR UNDERGROUND CONSTRUCTION.

TOWN OF VIENNA GENERAL NOTES

- 1. A PRE-CONSTRUCTION MEETING MUST BE HELD PRIOR TO THE START OF CONSTRUCTION. CALL 703-255-6384 TO SCHEDULE THE PRE-CONSTRUCTION MEETING.
- 2. ALL CONSTRUCTION GENERATED DEBRIS MUST BE HAULED AWAY BY THE CONTRACTOR OR OWNER.
- 3. PRIOR TO THE REMOVAL OF ANY TOWN TREES (TREES WITHIN THE RIGHT OF WAY), THE APPLICANT OR THEIR REPRESENTATIVE SHALL CONTACT THE TOWN OF VIENNA ARBORIST AT 703-255-6360 TO COORDINATE HAVING THE TOWN ARBORIST ONSITE DURING ALL TOWN TREE REMOVAL.
- 4. TREE PROTECTION FOR ANY TOWN TREE, AS SHOWN ON PLAN, MUST BE INSTALLED PRIOR TO ANY SITE WORK.
- 5. IT IS UNLAWFUL TO PERFORM ANY CONSTRUCTION ABOVE FOUNDATION CORNERS PRIOR TO APPROVAL OF SETBACKS. WORK COMPLETED IN VIOLATION OF THIS REQUIREMENT IS SUBJECT TO DEMOLITION.
- 6. ALL DUMPSTERS/PODS ARE TO BE PLACED ON PRIVATE PROPERTY.
- 7. FRONT ELEVATION CHECKS ARE REQUIRED.
- 8. WALL CHECK SURVEYS ARE REQUIRED AND MUST BE SUBMITTED PRIOR TO CONSTRUCTION ABOVE FOUNDATION CORNERS.
- 9. A CERTIFICATE OF OCCUPANCY IS REQUIRED PRIOR TO OCCUPANCY. ALL REQUIRED DOCUMENTATION AND INSPECTIONS MUST BE SUBMITTED/COMPLETED BEFORE THE TOWN OF VIENNA WILL ISSUE A CERTIFICATE OF OCCUPANCY.
- 10. EXISTING SANITARY SEWER LATERALS ARE TYPICALLY CAPPED AT OR NEAR THE PROPERTY LINE. THE REUSE OF THE PORTION OF THE EXISTING SANITARY SEWER LATERAL BETWEEN THE TOWN OWNED SEWER MAIN AND THE CAPPED END MAY BE ALLOWED PROVIDING THAT A LICENSED PLUMBER CERTIFIES THAT THE EXISTING PIECE OF PIPE IS GRADED PROPERLY AND IN LIKE NEW CONDITION. THE REUSE OF A PORTION OF THE EXISTING LATERAL DOES NOT IMPLY THAT THE TOWN IS WARRANTING THE CONDITION IN ANY WAY.


CALL "MISS UTILITY"

TELEPHONE 1-800-552-7001FOR UTILITY LOCATION AT LEAST 48 HOURS BEFORE BEGINNING CONSTRUCTION.

WETLAND CERTIFICATE

I HEREBY CERTIFY THAT ALL WETLANDS PERMITS REQUIRED BY LAW WILL BE OBTAINED PRIOR TO COMMENCING LAND DISTURBANCE ACTIVITIES.


OWNER NAME:	SIGNATURE:	_	DATE:

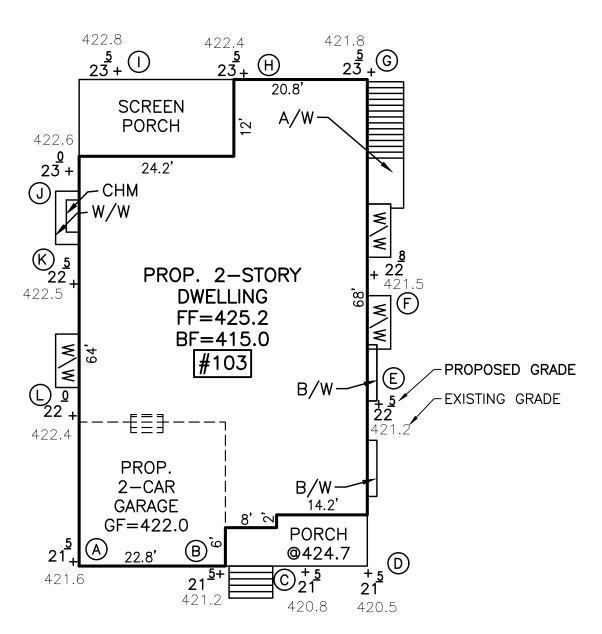

PROPOSED	AND	EXISTING	GRADES

LOT DEVIATION TABLE **ELEVATION** Deviation EXISTING PROPOSED -0.1 421.6 421.2 421.5 0.3 420.8 421.5 0.7 421.5 420.5 1.0 421.2 422.5 1.3 422.8 1.3 421.5 421.8 423.5 1.7 1.1 422.4 422.8 423.5 0.7 422.6 423.0 0.4 422.5 422. 0.0 422.4 422.0 -0.4

BUILDING HEIGHT COMPUTATIONS

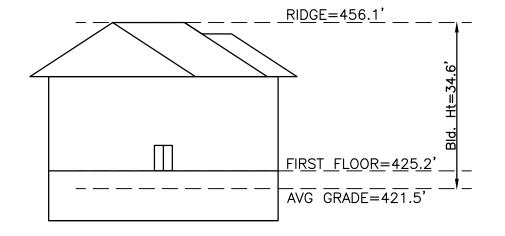

FRONT ELEVATION (N.T.S.)

Building Height Computation First Floor = 425.20 Ridge = 456.10 Average Grade (Avg, pt. A to D) = 421.50 Building Height = 34.60

STOCKPILE NARRATIVE:

THE SOIL FROM EXCAVATING FOUNDATION WILL BE STOCKPILED IN THE AREA SHOWN ON THE SITE PLAN. DURING CONSTRUCTION OF THE PROJECT, SOIL STOCKPILES AND BORROW AREAS SHALL BE STABILIZED OR PROTECTED WITH SEDIMENT TRAPPING MEASURES. ALL SOIL STOCKPILES, IF ANY, SHALL BE SEEDED AND MULCHED WITHIN 7 DAYS AFTER GRADING. THE HEIGHT OF THE STOCKPILES MATERIAL SHALL NOT EXCEED 4 FT.

THE STOCKPILE MATERIAL SHALL BE PROTECTED FROM DRAINING INTO ADJOINING NON DISTURBED AREA BY SILT FENCE OR ANY OTHER SEDIMENT CONTROL DEVICES. THE EXCESS OR UNUSED STOCKPILE MATERIALS SHALL BE REMOVED FROM THE SITE AND WILL BE DUMPED AT APPROVED DUMPING SITE AFTER THE COMPLETION OF THE PROJECT.

RESPONSIBLE LAND DISTURBER CERTIFICATION

Effective July 1, 2001.

Amendments to the Virginia Erosion Sediment Control Law, 10.1—563 and 10.1— 566 of the code of Virginia

OWNER/DEVELOPER/ INFORMATION

PROJECT NAME: 103 ST. ANDREWS DR NE
DISTRICT: HUNTER MILL TOWN OF VIENNA
TAX MAP AND PARCEL #: 0391 12 0039

OWNER/DEVELOPER/ PERMITTEE: M AND Z CONSTRUCTION AND CONSULTING LLC 4568 SUPERIOR SQ FAIRFAX, VA 22030

PHONE: 571-623-5107
RESPONSIBLE LAND DISTURBER INFORMATION


CERTIFICATE/LICENSE HOLDER NAME: MIR WAIS ZOHORI

TYPE OF CERTIFICATE: RLD, #17846
SIGNATURE

_____DATE_____

EMAIL: MIRWAISZOHORI@GMAIL.COM



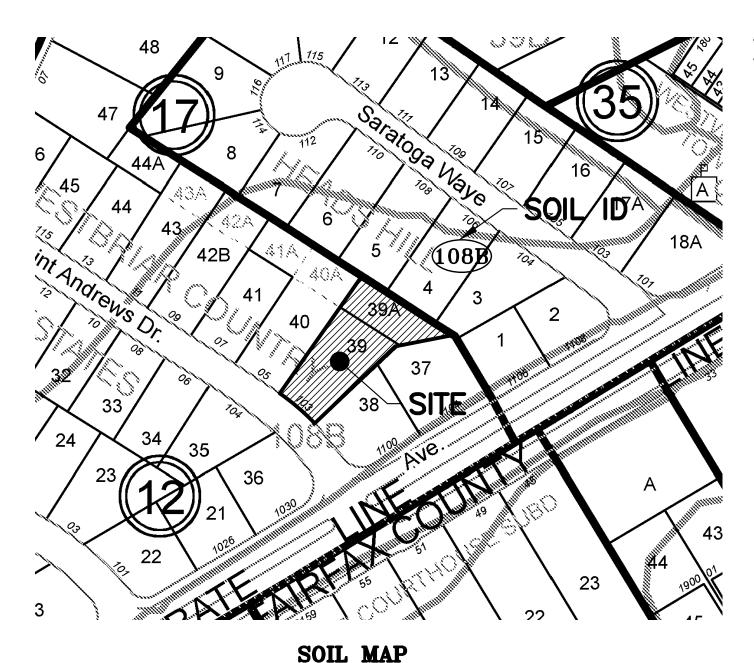

(SCALE: 1":150')

SOIL DATA


SOIL ID NUMBERS	SERIES NAME	FOUNDATION SUPPORT	SOIL DRAINAGE	SUITABILITY FOR SEPTIC DRAINFIELDS		EROSION POTENTIAL	SOIL HYDRO GROUP	SOIL PROBLEM CLASS
108	WHEATON-SUMERDUCK COMPLEX	MARGINAL	POOR	POOR	POOR	MEDIUM	D	IVB

SHEET INDEX

- 1. COVER SHEET
- 2. EXISTING CONDITION PLAN
 - SITE GRADING PLAN

 E&S CONTROL NARRATIVE AND DETAILS
- 5. E&S CONTROL NARRATIVE AND DETAILS
- 6. TREE CONSERVATION PLANS
- 7. LANDSCAPE PLAN
- 8. TCP NOTES AND DETAILS
 9. VRRM COMPUTATIONS
- 10. HYDROGRAPHS
- 11. HYDROGRAPHS
 12. SWM COMPUTATIONS AND OUTFALL ANALYSIS
- 13. BMP DETAIL & NOTES
- 4. SOIL REPORT

TOV APPROVAL STAMP

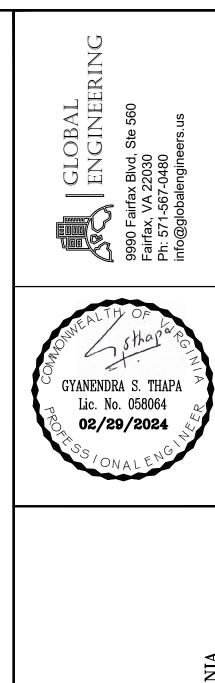

WESTBRIAR COUNTRY CLUB EST
LT 39 SEC 1
103 SAINT ANDREWS DRIVE N
MAGISTERIAL DISTRICT: HUNTER MILL TOWN OF VIENN

NO. DATE REVISION

DESIGN BY:


DRAWN BY:

CHECKED BY:


SCALE: AS NOTED

CUPPT. 1 A


SHEET: 1 OF <u>14</u>

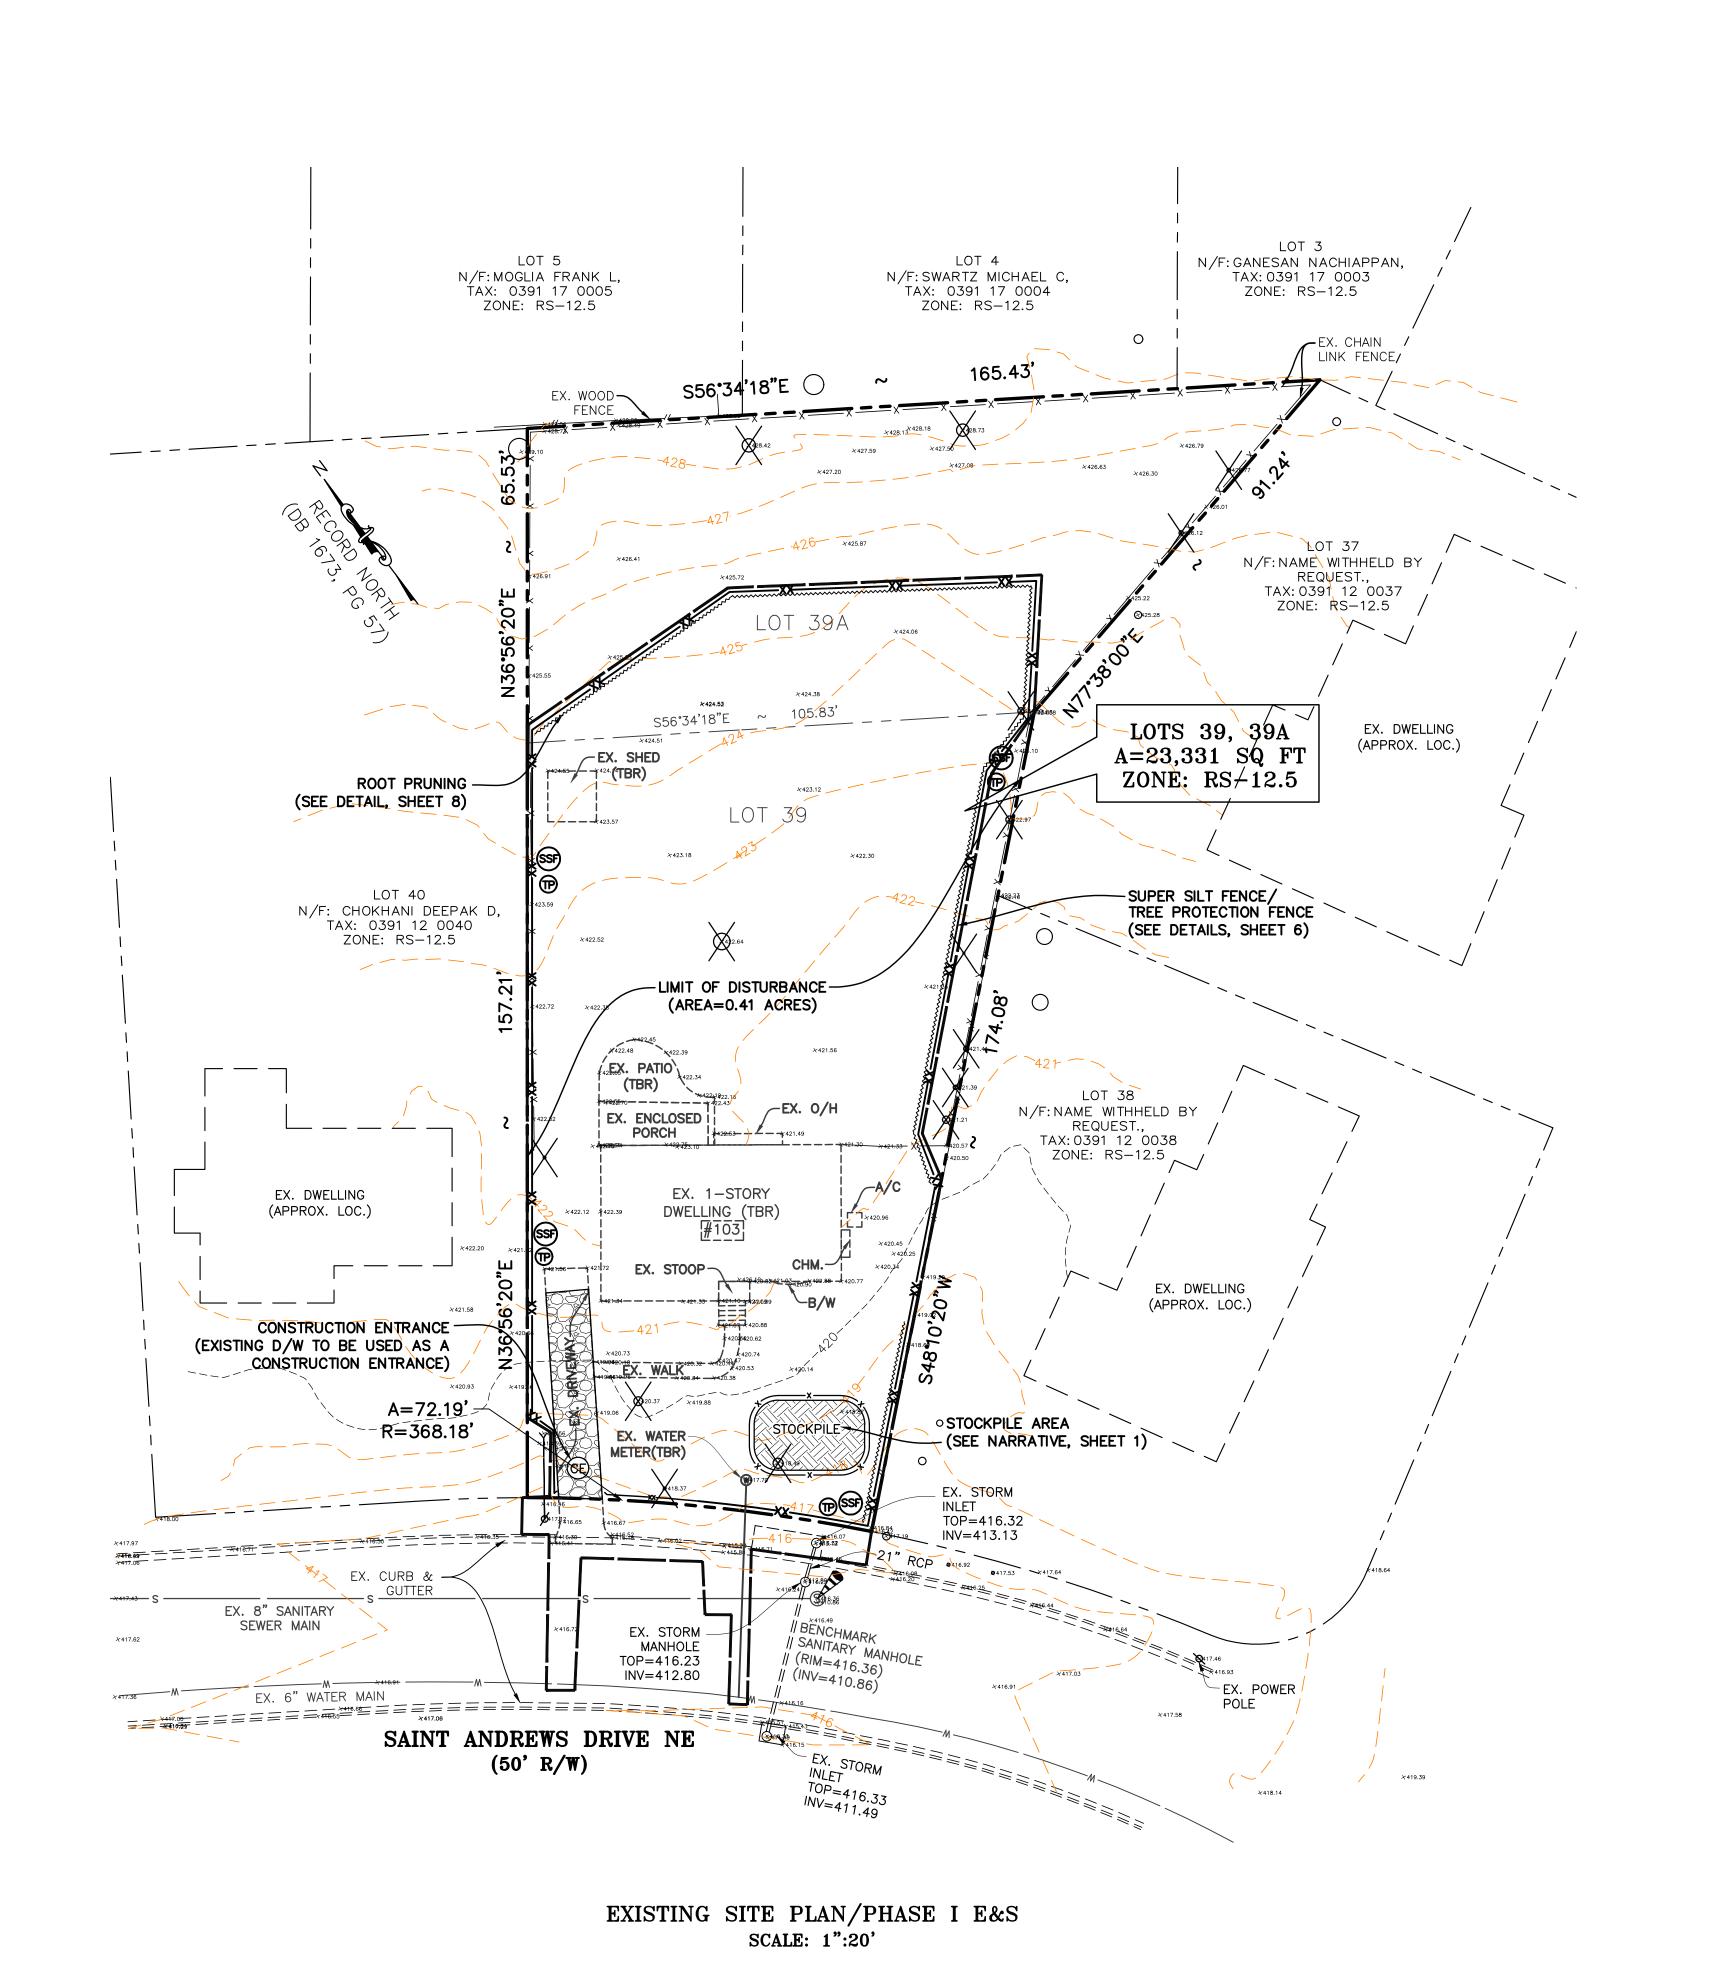


VIRGINIA UNIFORM CODING SYSTEM for Erosion and Sediment Control Practices

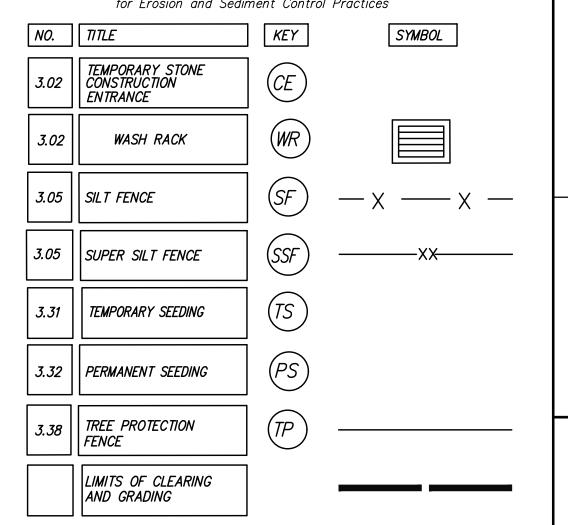

LEGENDS

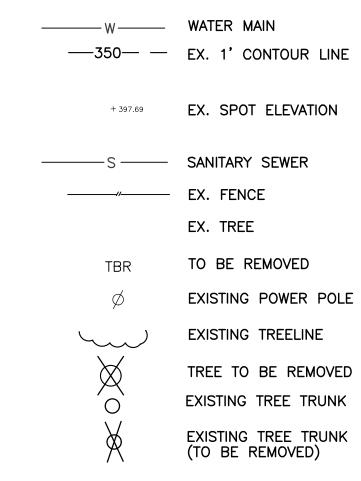

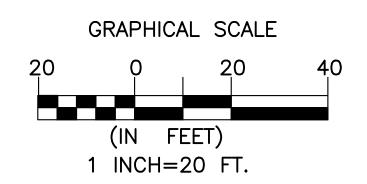

EXISTING CONDITION PLAN
WESTBRIAR COUNTRY CLUB ESTATES
LT 39 SEC 1

103 SAINT ANDREWS DRIVE NE

AAGISTERIAL DISTRICT: HUNTER MILL TOWN OF VIENNA, VIRGI

GYANENDRA S. THAPA

Lic. No. 058064

03/26/2024


DESIGN BY:

DRAWN BY:

CHECKED BY:

SCALE: 1":20'

SHEET: 2 OF <u>14</u>

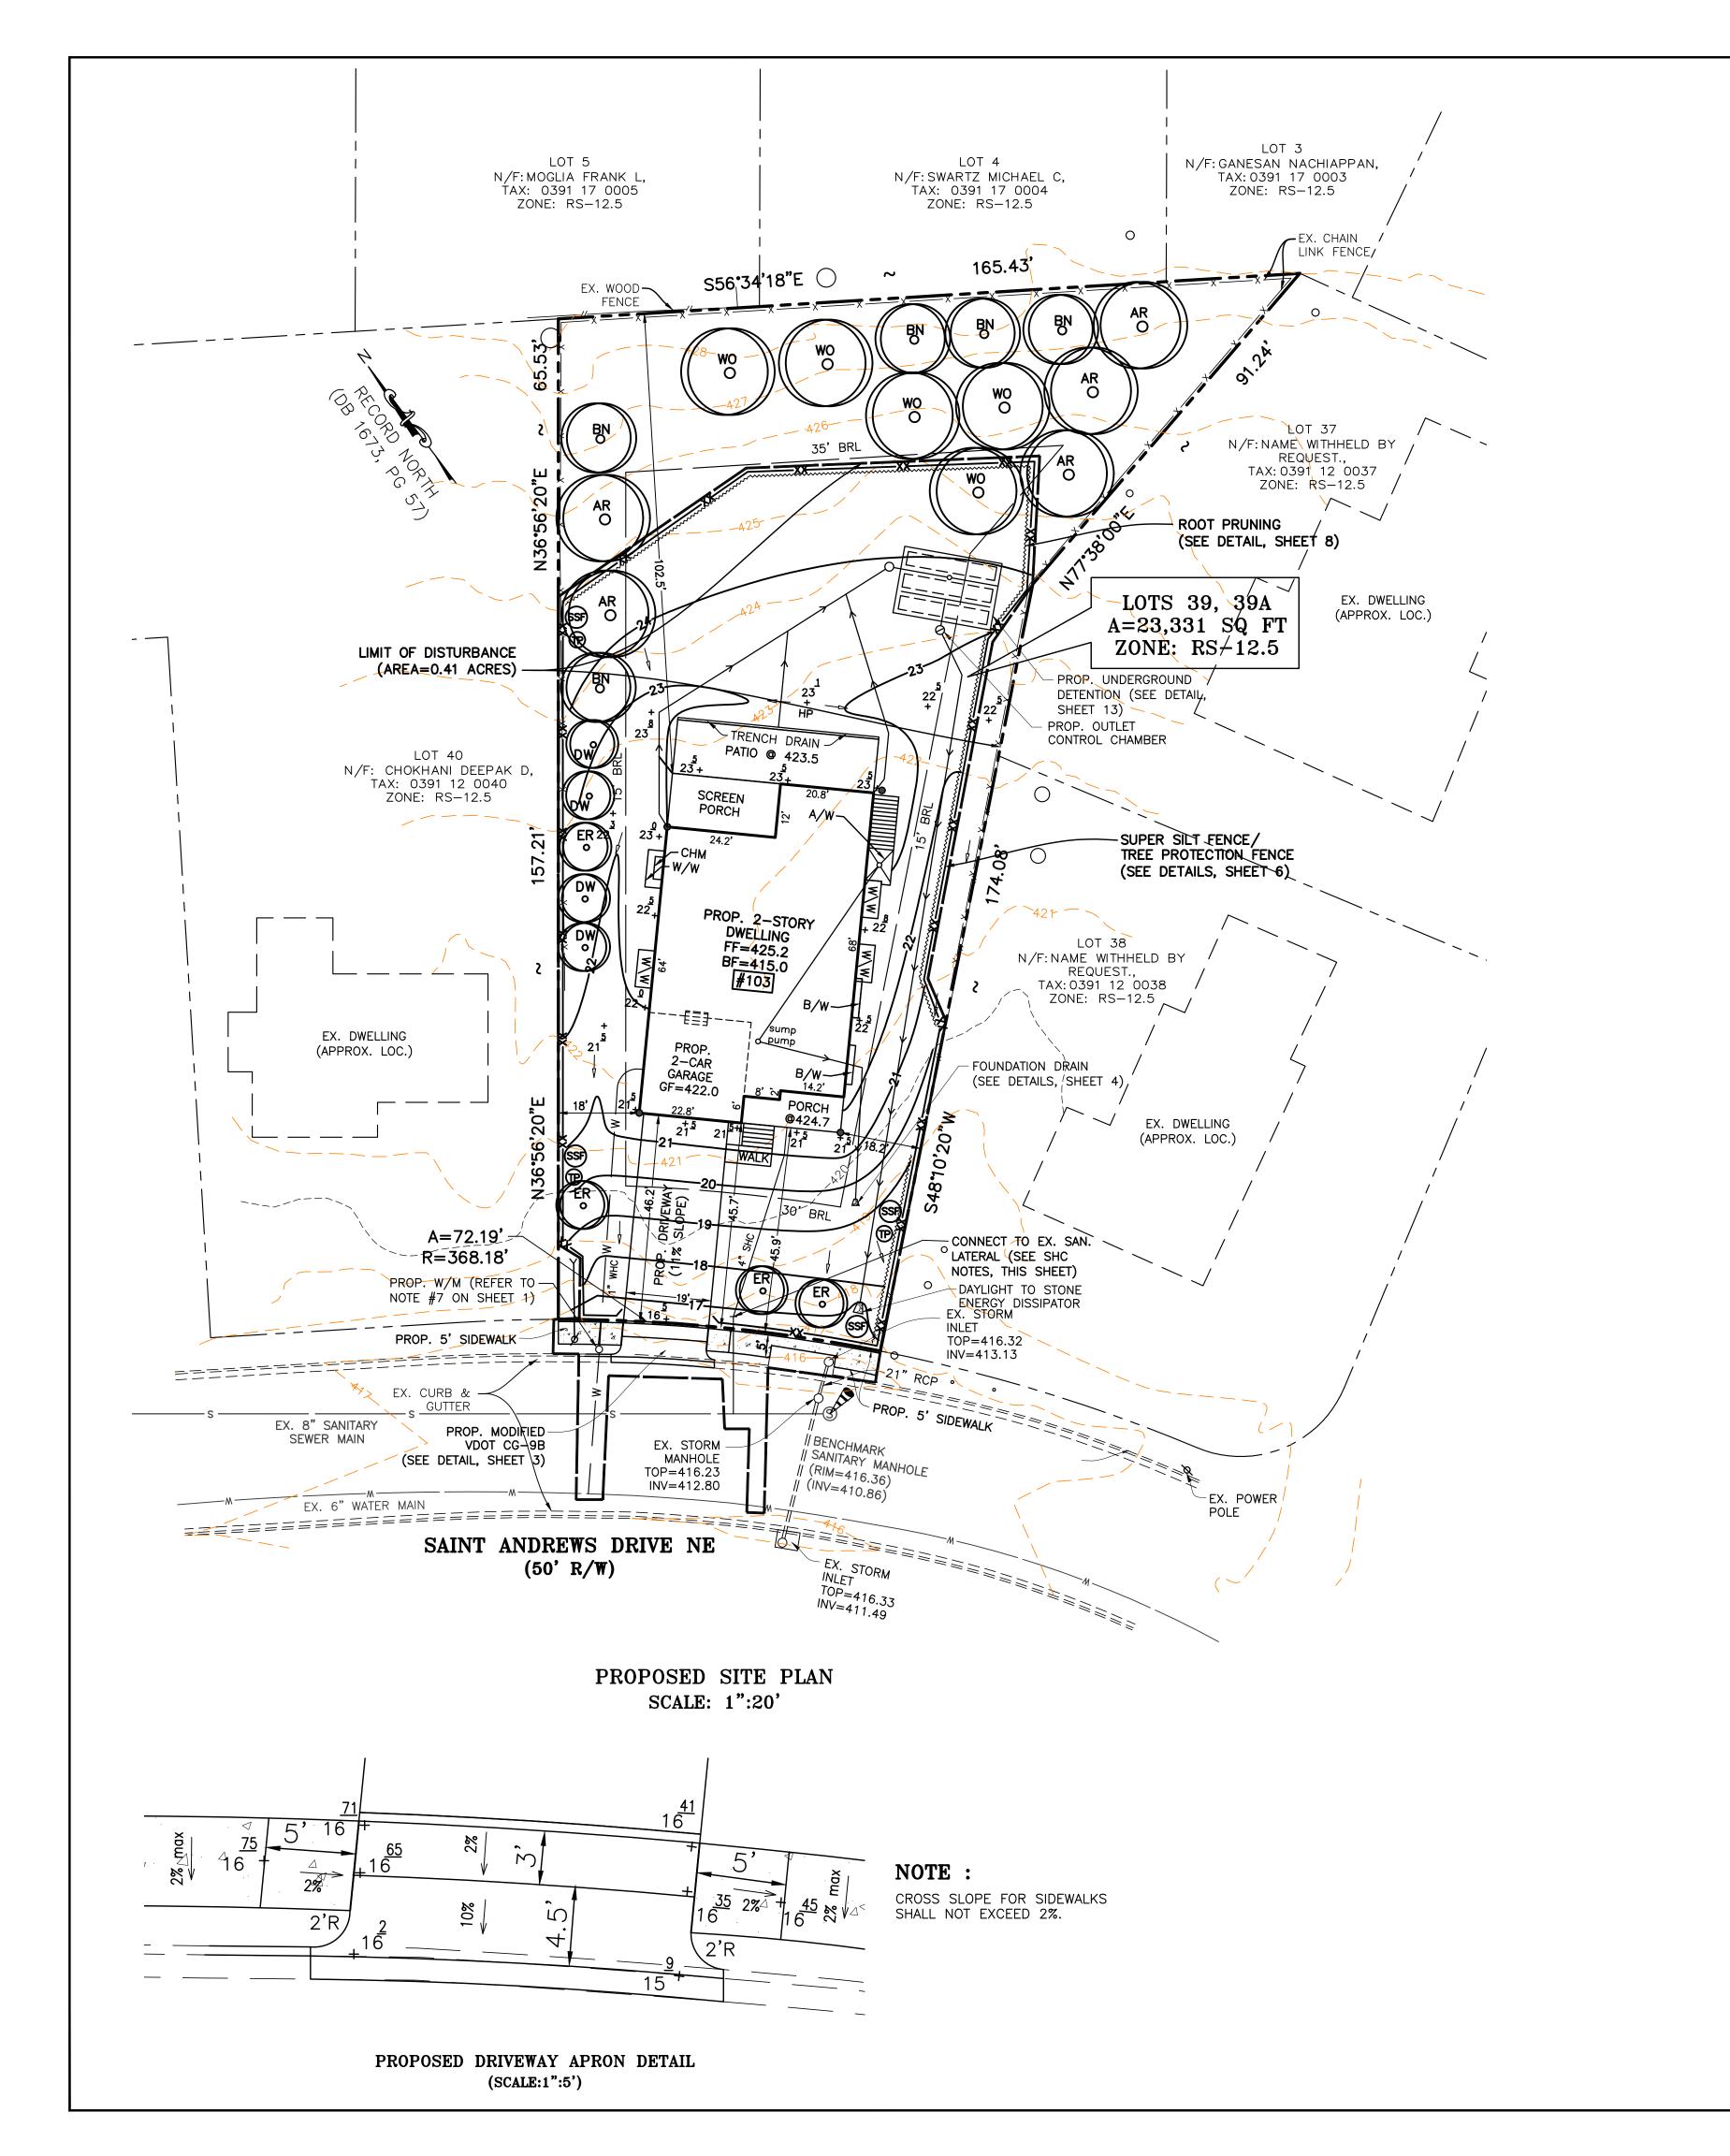

Impervious Area and Coverage Computation

DESCRIPTION	PRE-DEV	POST-DEV	Lot Coverage
Building	1,520	2,968	2,968
Driveway	430	873	873
Porch, Screen Porch	229	451	451
Walk, Steps, Areway	141	183	
Patio	150	540	540
Shed	107	-	1

2,577 5,015 4,832 Total Impervious area (SQ FT) 20,754 18,316 Total Pervious area 23,331 23,331 Total Site area

INCREASE IN IMPERVIOUSNESS = 2438 SQ FT Total % of Lot Coverage= 20.71% Deck Area = 0


Deck Coverage = 0.00%

SITE ANALYSIS						
DESCRIPTION	REQUIRED	PROVIDED/EXISTING				
ZONE	RS-12.5	RS-12.5				
LOT AREA	23331 SQ FT	23331 SQ FT				
MAX. LOT COVERAGE	25%	20.71%				
DECK COVERAGE	5% OF LOT AREA OR	0.0%				
DECK COVERAGE	1167 SQ FT	0 SQ FT				
BUILDING HEIGHT	35 FT	34.60 FT				
TREE COVER	20%	29.5%				

Lot Shape Factor						
	Existing	Proposed				
Area	14460 SQ FT	23331 SQ FT				
mieter	509.31 FT	725.68 FT				
ipe Factor	17.94	22.57				

NOTE:

THE LOTS SHALL BE CONSOLIDATED TO TAKE CREDIT FOR THE COMBINED SITE AREA FOR LOT COVERAGE COMPUTATION PURPOSES PRIOR TO THE ISSUANCE OF OCCUPANCY PERMIT.

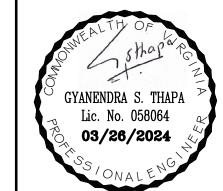

PLAN


GRADING

103 RIAL 1


VIRGINIA UNIFORM CODING SYSTEM

	for Erosion and Sediment Control Practices								
NO.	ππε	KEY	SYMBOL						
3.02	TEMPORARY STONE CONSTRUCTION ENTRANCE	CE							
3.02	WASH RACK	WR							
3.05	SILT FENCE	SF	—x ——x —						
3.05	SUPER SILT FENCE	SSF	XX						
3.31	TEMPORARY SEEDING	TS							
3.32	PERMANENT SEEDING	PS							
3.38	TREE PROTECTION FENCE	TP							
	LIMITS OF CLEARING AND GRADING								


LEGENDS

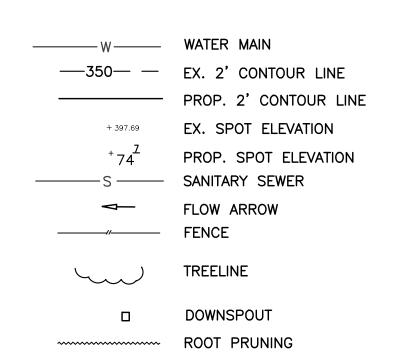


NOTE: DUAL SUMP PUMP WITH BACKUP POWER TO BE PROVIDED

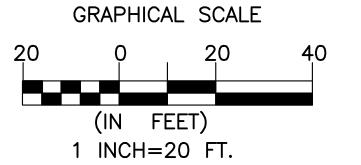

TOV APPROVAL STAMP

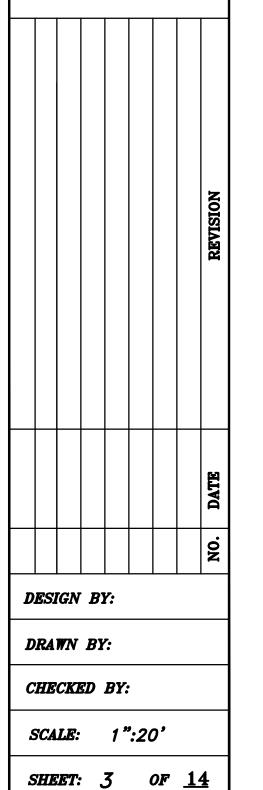

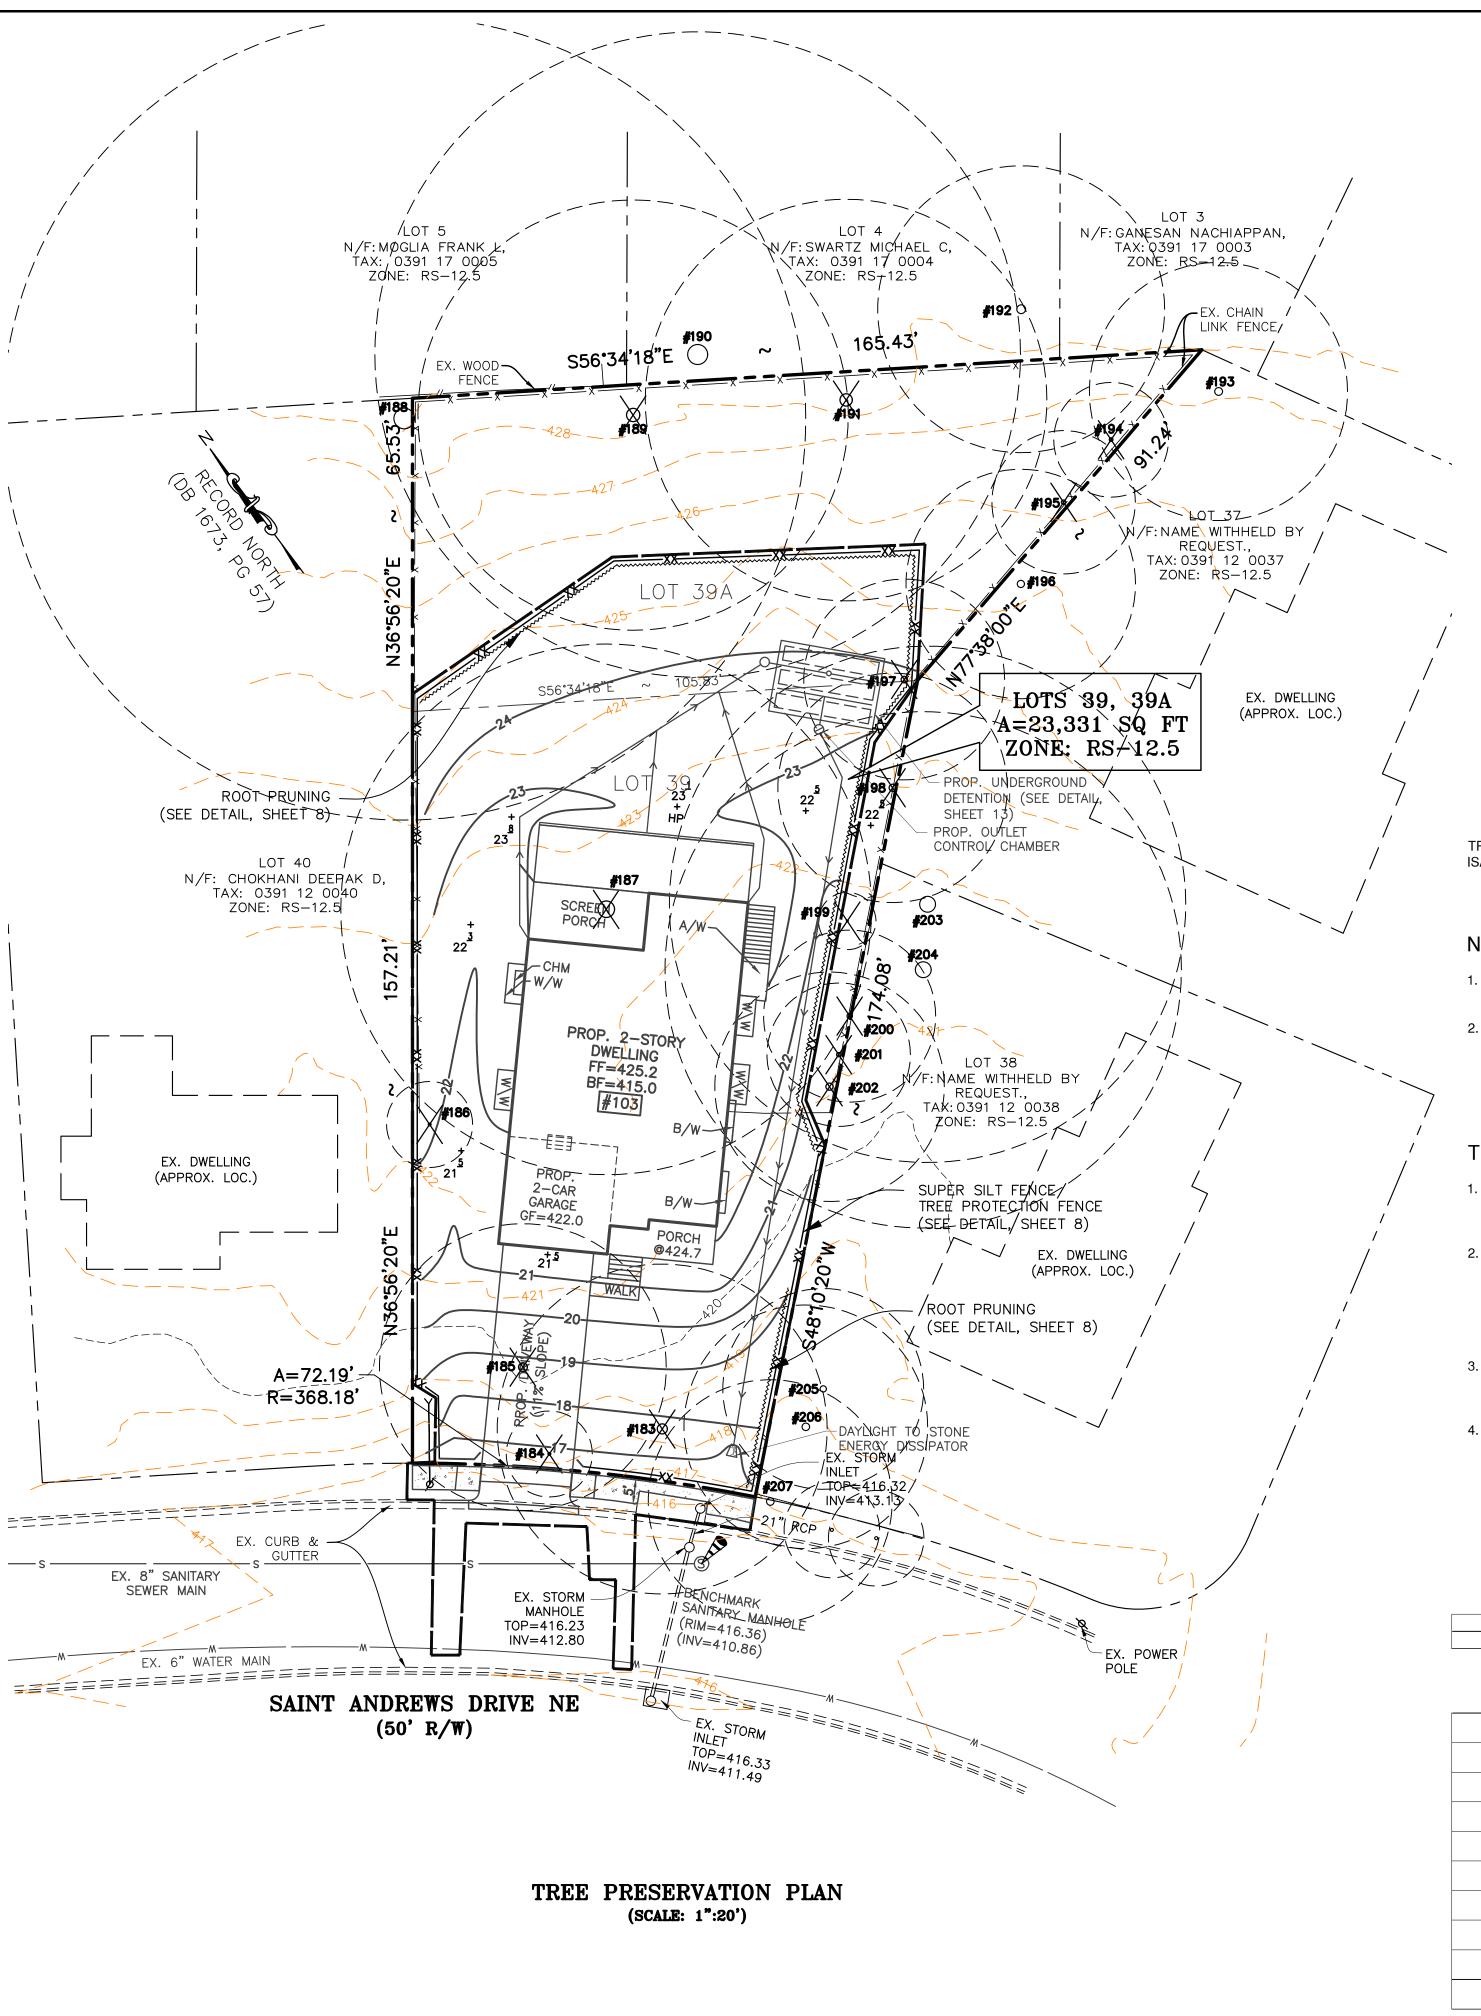

Tag#	Botanical Name	Common Name	Size	**TRZ*1.5	***Condition	Problems	Comments
			*DBH (in.)		%		
183	acer rubrum	red maple	22.5	34.5	45	deadwood, decline, decay	Remove, Inside Limits of disturbance
184	lagerstromia indica	crape myrtle	20ft	9	30	topped	Remove, Inside Limits of disturbance
185	acer rubrum	red maple	19.9	30	75	deadwood, decline, decay	Remove, Inside Limits of disturbance
186	hibiscus siriacus	rose of sharon	12ft	9	40		Remove, Inside Limits of disturbance
187	acer rubrum	red maple	36.5	55.5	45	deadwood, decline, decay	Remove, Inside Limits of disturbance
188	acer saccharinium	silver maple	56	84	55		Preserve, co-owned, Install preventive measures
189	magnolia grandiflora	southern magno	18,22	45	50	severe trunk decay	Remove, Trunk Decay
190	liriodendron tulipifera	tulip tree	45	67.5	65		Preserve, off site
191	magnolia grandiflora	southern magno	28	42	50	severe trunk decay	Remove, Trunk Decay
192	acer rubrum	red maple	20	30	60		Preserve, off site
193	quercus palustris	pin oak	18	27	75		Preserve, off site
194	morus alba	white mulberry	12	18	25	trunk decay	Remove, Trunk Decay
195	fraxinus pennsylvanica	green ash	10	15	20		Remove
196	quercus palustris	pin oak	16	24	75		Preserve, off site
197	prunus serotina	black cherry	14	21	30	decline	Remove, Inside Limits of disturbance
198	morus alba	white mulberry	16	24	50		Remove, Inside Limits of disturbance
199	prunus serrulata	flowering cherry	4	6	50		Remove, Inside Limits of disturbance
200	morus alba	white mulberry	12	18	50		Remove, Inside Limits of disturbance
201	diospyros virginiana	persimmon	10	15	75		Remove, Inside Limits of disturbance
202	morus alba	white mulberry	16	24	50		Remove, Inside Limits of disturbance
203	acer saccharinium	silver maple	36	54	55		Preserve, off site
204	acer saccharinium	silver maple	36	54	55		Preserve, off site
205	pinus strobus	white pine	14	21	40		Preserve, off site
206	pinus strobus	white pine	17	25.5	40		Preserve, off site
207	pinus strobus	white pine	17	25.5	40		Preserve, off site

TREE INVENTORY COLLECTED BY DON ZIMAR. ISA CERTIFIED ARBORIST #MA-0039

NOTE:

- 1. NEIGHBORING OWNER'S PERMISSION IS REQUIRED TO REMOVE OFFSITE OR CO-OWNED TREES.
- 2. OFFSITE TREES ARE NOT TAGGED TO AVOID CONFLICT.

TREE PRESERVATION NOTES:

- 1. THE USE OF HEAVY EQUIPMENT IS STRICTLY PROHIBITED WITHIN TREE PRESERVATION AREAS, INCLUDING FOR THE PURPOSE OF REMOVING UNWANTED TREES, STRUCTURES, PADS, GRADING, SODDING, ETC. ANY STRUCTURE WITHIN THE TREE PRESERVATION AREA SHALL BE REMOVED BY HAND.
- 2. ALL AREAS DELINEATED AS TREE PRESERVATION AREAS SHALL BE LEFT IN THEIR ORIGINAL CONDITION THROUGHOUT THE ENTIRE CONSTRUCTION PERIOD. FAILURE TO DO SO WILL RESULT IN DENIAL OF THE OCCUPANCY PERMIT AND REMEDIATION OF THE TREE PRESERVATION AREA WILL BE REQUIRED. REMEDIATION MUST BE DONE AT THE DIRECTION OF A CERTIFIED ARBORIST AND A WRITTEN REPORT COMPLETED BY A CERTIFIED ARBORIST SHALL BE SUBMITTED AND APPROVED BY VIENNA SURBAN ARBORIST PRIOR TO ANY REMEDIATION ACTIVITIES
- 3. AREAS DESIGNATED AS TREE PRESERVATION OR TREE SAVE AREA SHALL BE LEFT IN THE SAME CONDITION AS IT WAS PRE-CONSTRUCTION. IF A CHANGE TO THIS AREA IS TO BE MADE, APPROVAL FROM THE TOV URBAN ARBORIST IS REQUIRED. APPROVAL IS NOT REQUIRED IF MULCH IS INSTALLED TO THE TREE SAVE AREAS
- 4. ANY PROPOSED GRADE CHANGES WITHIN THE TREE SAVE AREA(S) SHALL BE REVIEWED WITH THE TOV URBAN ARBORIST DURING THE PRE-CONSTRUCTION MEETING

This plan was prepared by Donald E. Zimar, Maryland Registered Forester \$377, ISA Certified Arborist MA-0039, ISA Certified Tree Risk Assessor \$758, ASCA RCA \$446, Maryland Licensed Tree Expert \$587.

KZ Consulting, LLC' dba Your Consulting Arborist PO Box 825 Bristow, VA 20136 703-398-4644

Don Zimar


EXISTING TREE COVER CALCULATION EXISTING TREE CANOPY = 14476 SQ FT


% OF TREE COVER = 62.0%

PROPOSED TREE COVER CALCULATION

SITE AREA=	23331 SQ FT					
% OF TREE COVER REQUIRED=	20%					
TOTAL AREA OF TREE COVER REQUIRED=	4666 SQ FT					
TREE CANOPY AREA FROM PRESERVATION=	0 SQ FT					
25% CREDIT OF EXISTING TREES=	0 SQ FT					
PROPOSED TREE CANOPY AREA=	4800 SQ FT					
TOTAL TREE COVER PROVIDED=	4800 SQ FT					
TOTAL TREE COVER PROVIDED (%)=	20.6%					
TOTAL TREE COVER 4800 SQ FT >REQUIRED 4666 SQ FT, [OK]						



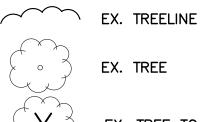


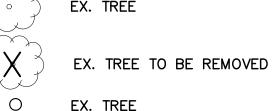


EX. TREE EX. TREE TO BE REMOVED



TP TREE PROCTECTION FENCE, SPEC 3.38 ROOT PRUNING

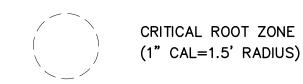

TOV APPROVAL STAMP

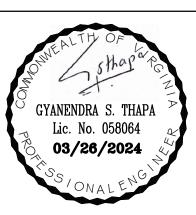

ESTATES

CLUB 103
MAGISTERIAL I


ONSERVATION

TRE

DESIGN BY: DRAWN BY:

CHECKED BY:

SCALE: 1":20' SHEET: 6 OF <u>14</u>

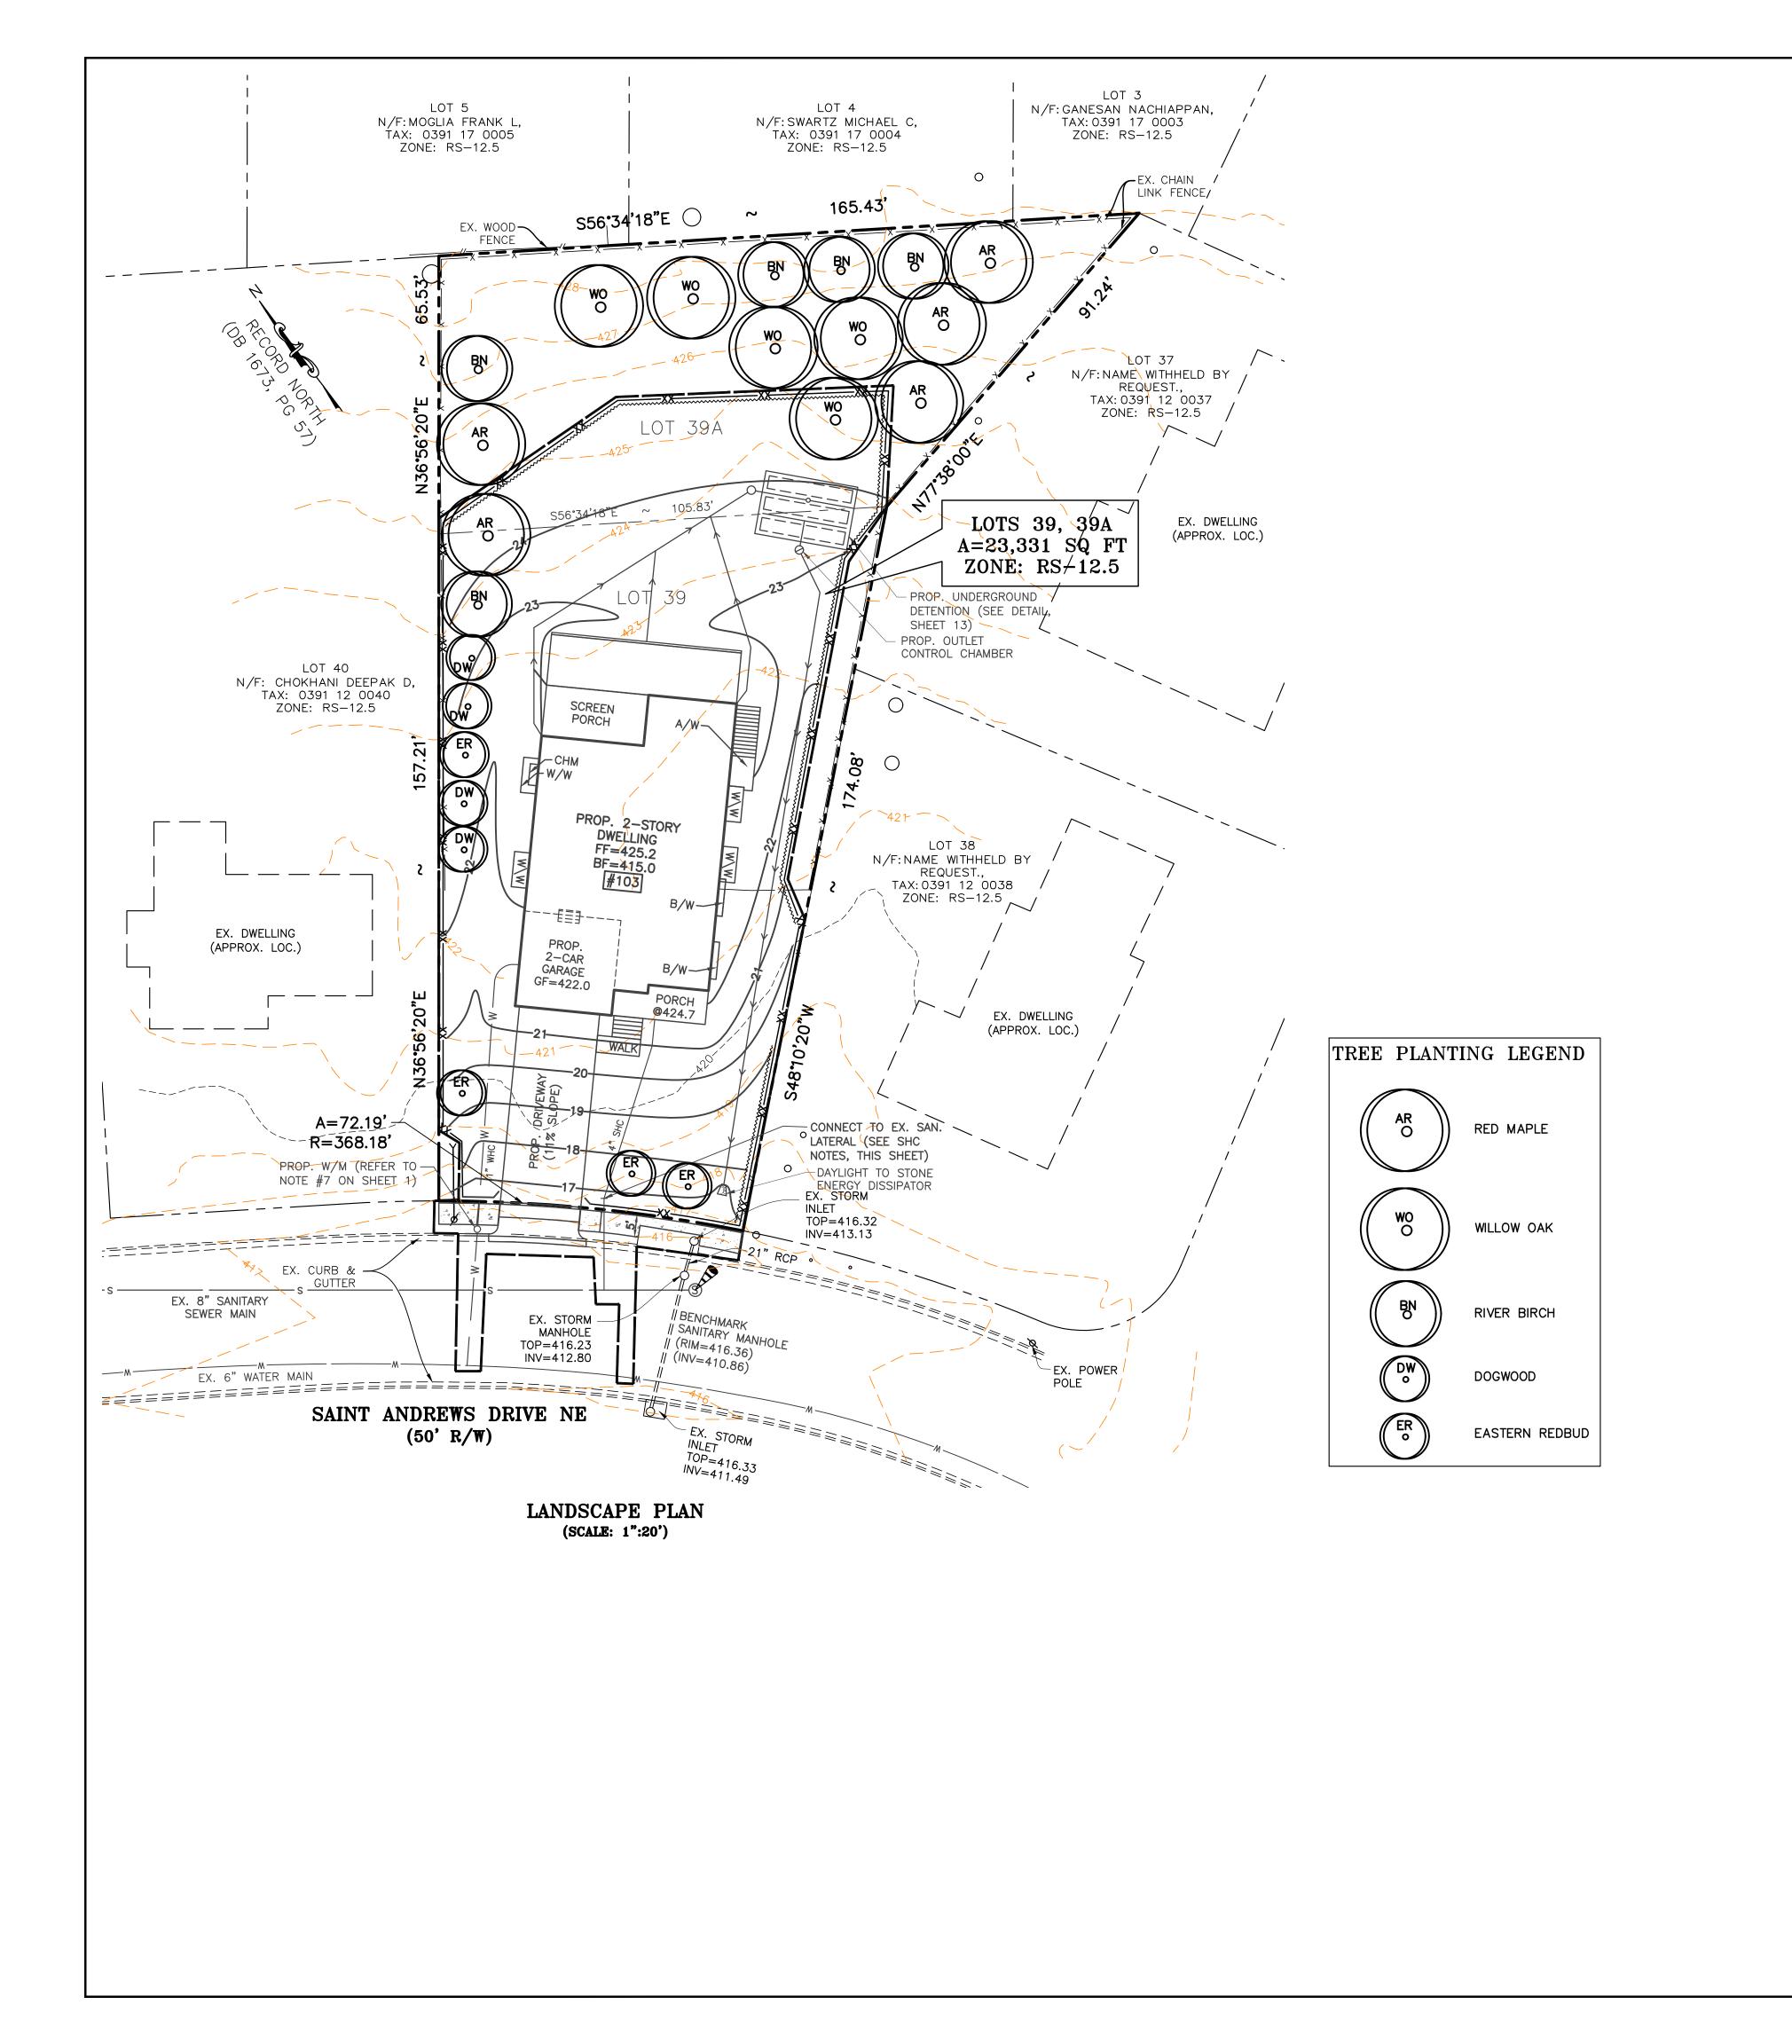

EXISTING TREE COVER CALCULATION

EXISTING TREE CANOPY = 14476 SQ FT

% OF TREE COVER = | 62.0%

PROPOSED TREE COVER CALCULATION

SITE ADEA -	23331 SQ FT
SITE AREA	233313QF1
% OF TREE COVER REQUIRED=	20%
TOTAL AREA OF TREE COVER REQUIRED=	4666 SQ FT
TREE CANOPY AREA FROM PRESERVATION=	0 SQ FT
25% CREDIT OF EXISTING TREES=	0 SQ FT
PROPOSED TREE CANOPY AREA=	4800 SQ FT
TOTAL TREE COVER PROVIDED=	4800 SQ FT
TOTAL TREE COVER PROVIDED (%)=	20.6%
TOTAL TREE COVER 4800 SQ FT >REQUIRED 4666 SC	Q FT, [OK]

	TREE PLANTING INVENTORY									
	TREE PLANTING INVENTORY									
KEY	BOTANICAL NAME	COMMON NAME	QTY	STOCK SIZE	STOCK	CROWN	TREE CANOPY			
				(HT/CALIPER)	TYPE	COVERAGE	SUB-TOTAL			
ER	Cercis canadensis	Eastern Redbud	4	2" CALIPER	BB	100	400			
DW	Cornus florida	Flowering Dogwood	4	2" CALIPER	BB	100	400			
AR	Acer rubrum	Red Maple	5	2" CALIPER	BB	300	1500			
WO	Qurecus phellos	Willow Oak	5	2" CALIPER	BB	300	1500			
BN	Betula nigra	River Birch	5	2" CALIPER	BB	200	1000			
						SUB-TOTAL=	4800			

This plan was prepared by Donald E. Zimar, Maryland Registered Forester \$377, ISA Certified Arbarist MA-0039, ISA Certified Tree Risk Assessor \$758, ASCA RCA \$446, Maryland Licensed Tree Expert \$587.

KZ Consulting, LLC' dba Your Consulting Arborist PO Box 825 Bristow, VA 20136 703-398-4644

Don Zimar

LEGEND



TREE CANOPY TO BE SAVED

EX. TREE TO REMAIN


TREE PROTECTION FENCE

TREE PROCTION FENCE, SPEC 3.38

ROOT PRUNING

TOV APPROVAL STAMP


| GLOBAL | ENGINEERING

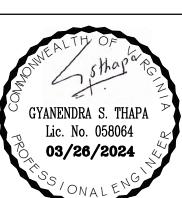

LANDSCAPE

SRIAR COUNTRY C

LT 39 SEC 103
MAGISTERIAL I

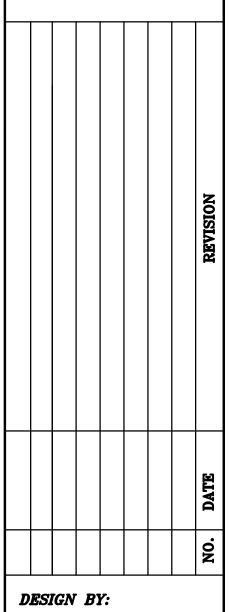

DRAWN BY: CHECKED BY:

SCALE: 1":10'

SHEET: 7 OF <u>14</u>