


Bank of America - Maple Ave. REMOTE WALK-UP ATM INSTALLATION CONSTRUCTION DOCUMENTS

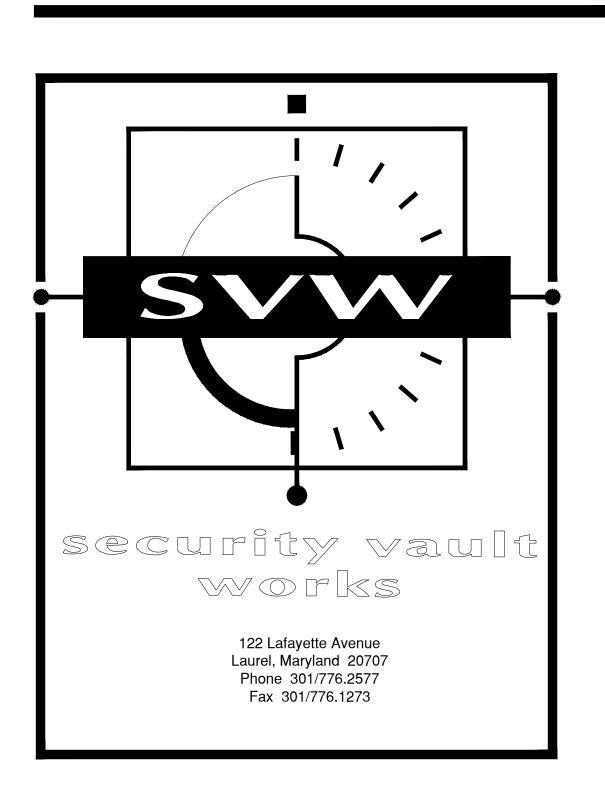

James M. Hamill **ARCHITECT**

580 Decker Drive Suite 170 Irving, Texas 75062 Phone 972/714.0420

Fax 972/714.0282

Local Address:

418 Maple Ave. Vienna, VA 22180

Developer/Applicant/Designer:


Heather McCarriher **Security Vault Works** 122 Lafayette Ave. Laurel, MD 20707 301-776-2577 Ext. 1016

Building Codes:

2015 Virginia Uniform Statewide Building Code 2014 National Electrical Code

Building Construction Type:

2B Unprotected non-combustible

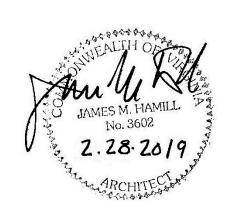

Schedule of Drawings

GENERAL

C.1 - Cover Sheet

ARCHITECTURAL

A.1 - Site Plan

A.2 - Plans

A.3 - Plan and Elevation

A.4 - Details

A.5 - Details

E.1 - Electrical Details

E.2 - Electrical Details


Scope of Work:

- Disconnect Electric
- Remove Existing ATM
- Remove Existing Kiosk
- Install New ATM
- Install New Kiosk
- Reusing existing electrical

Site Location Map

Scale: NOT TO SCALE



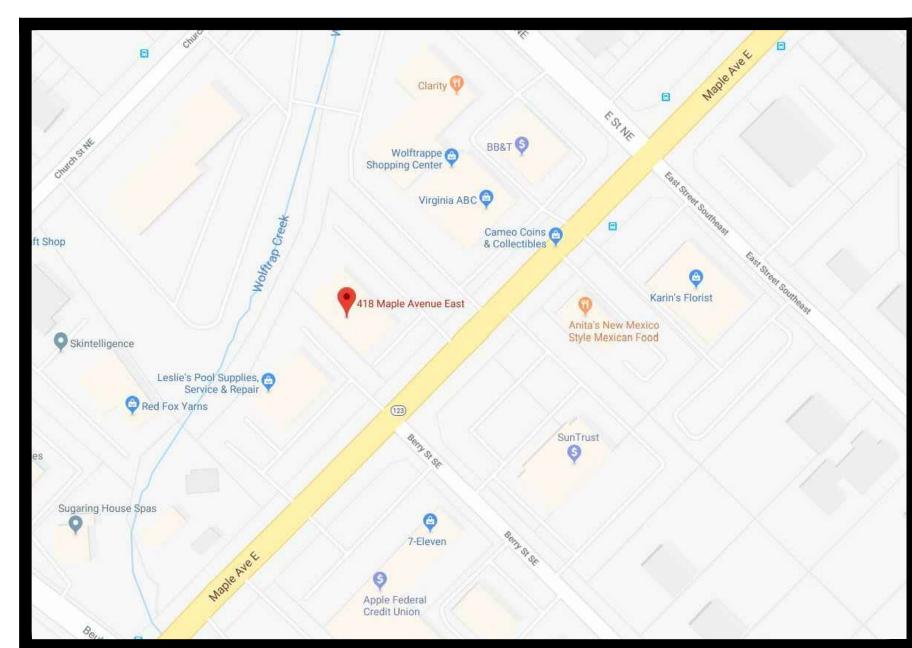


Existing



Rendering



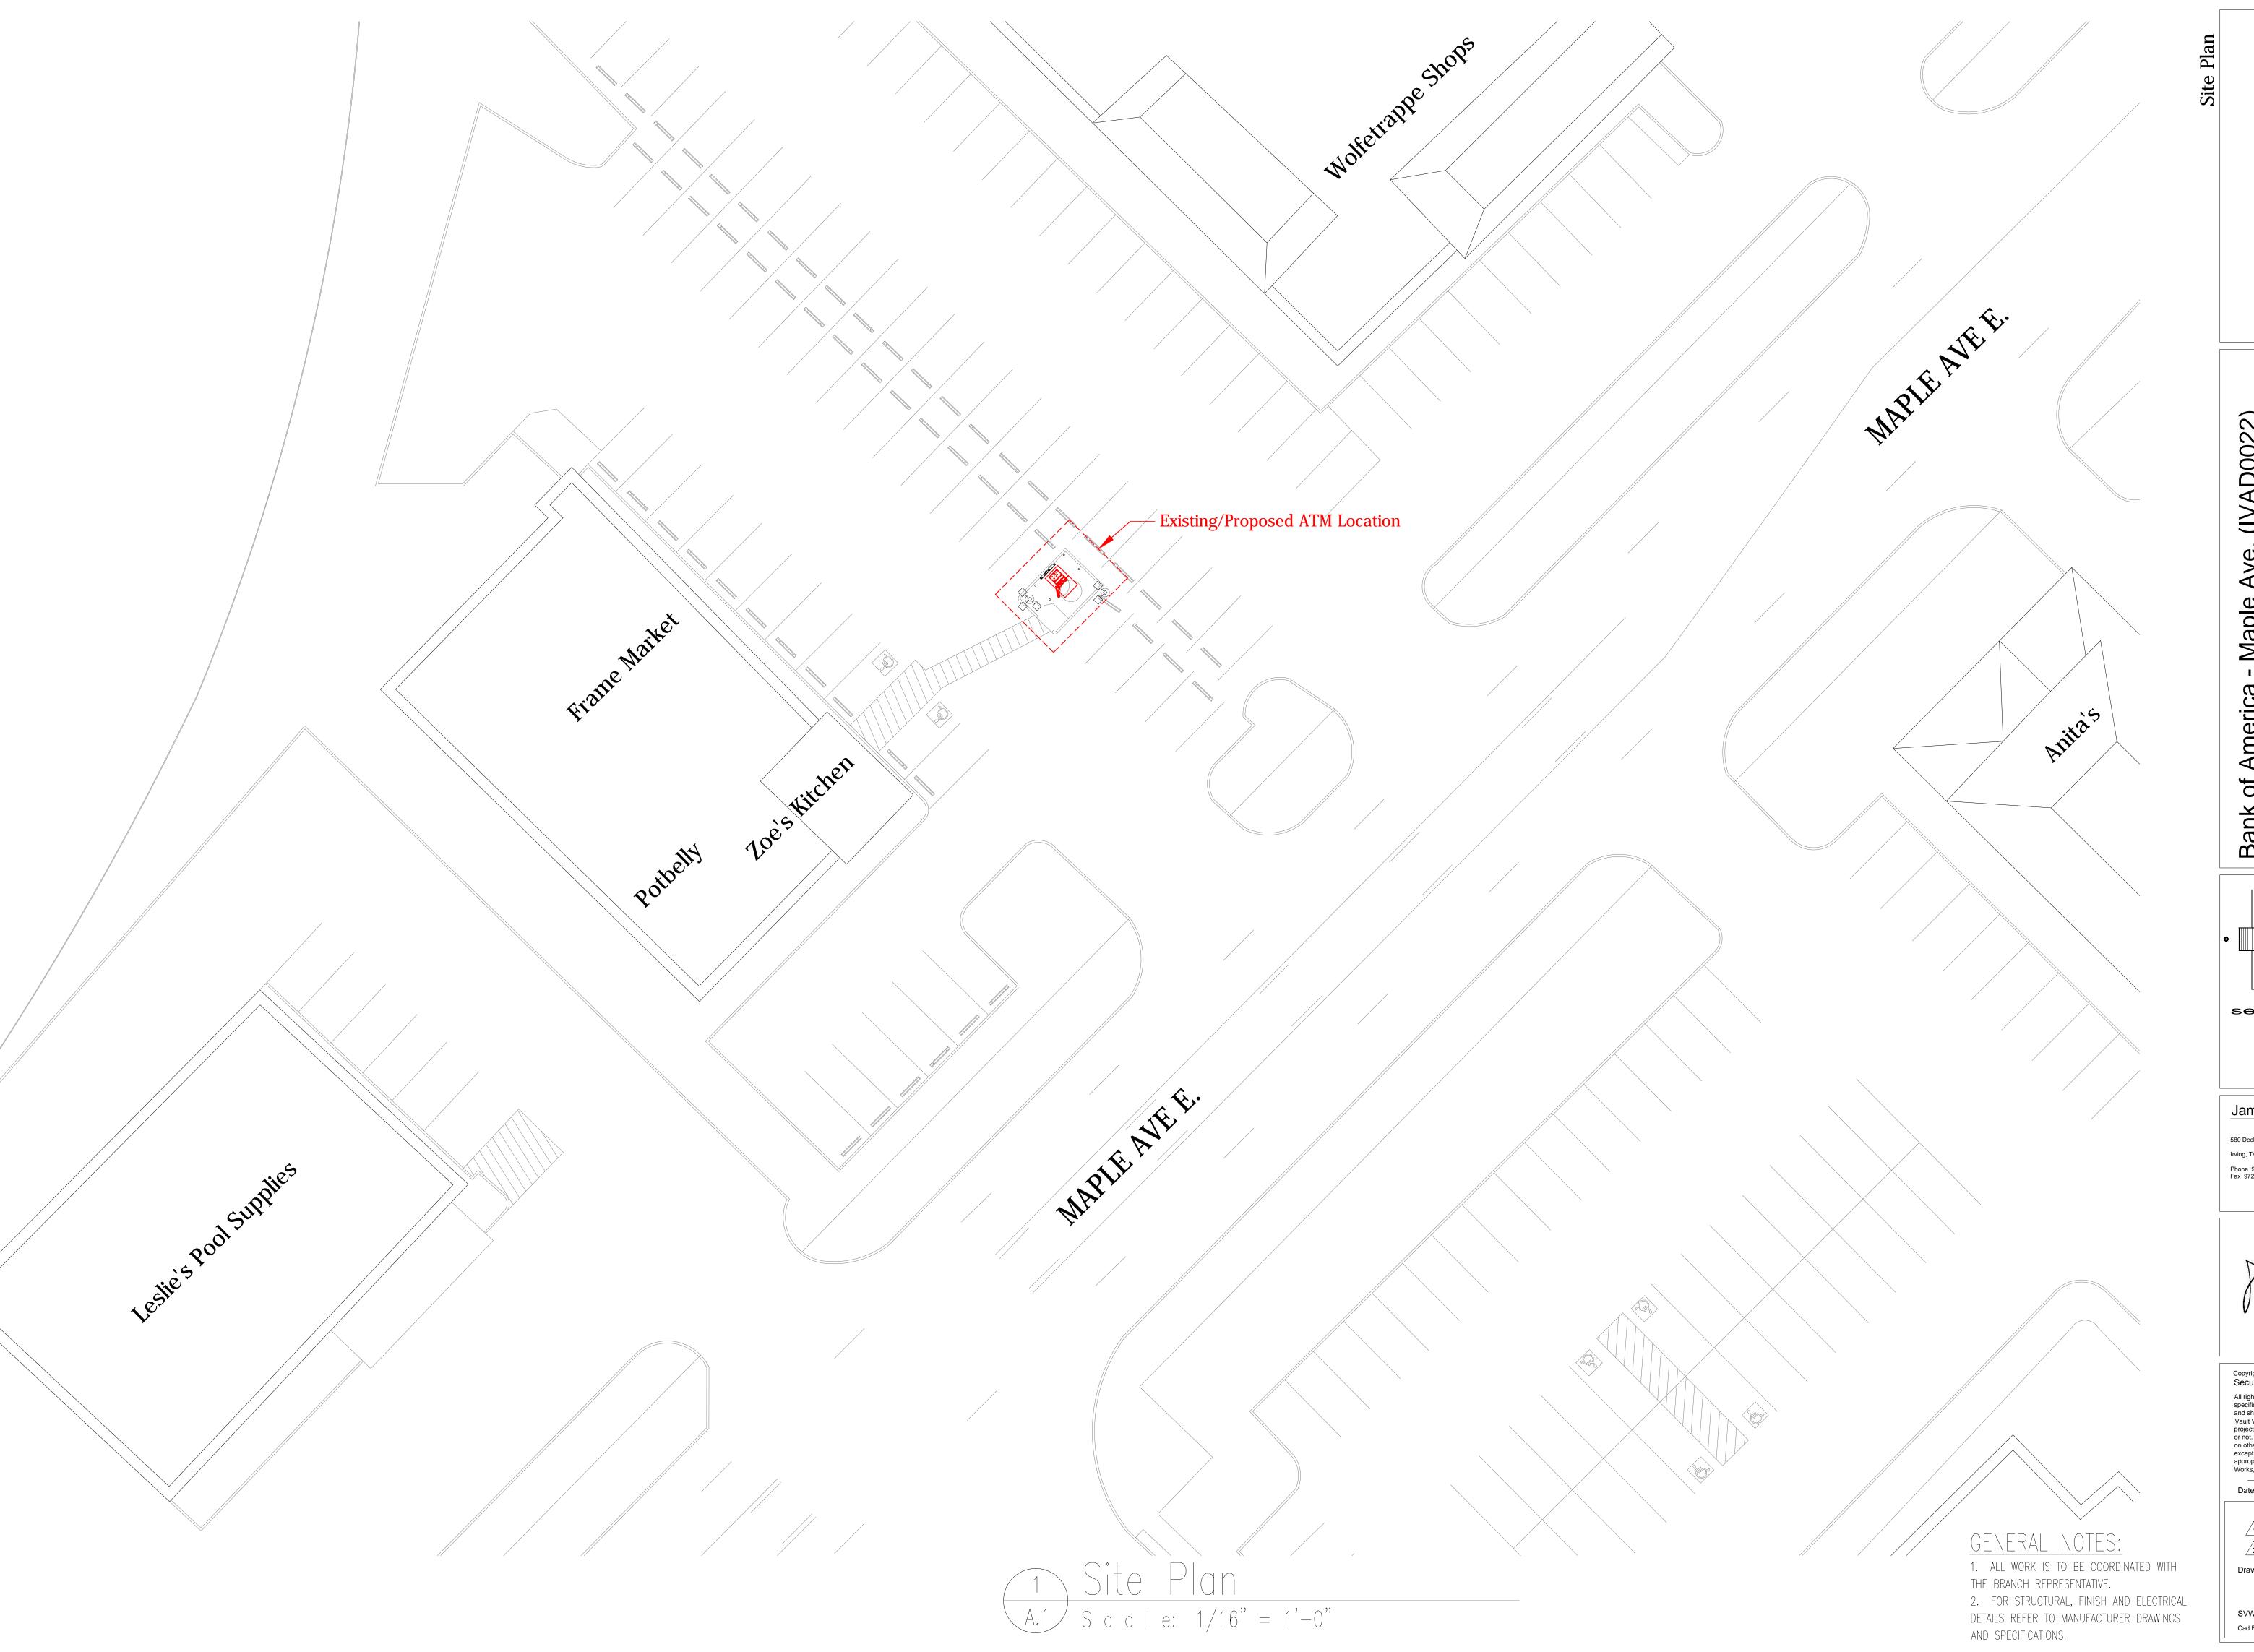


Bank of America - Maple Ave. (IVAD0022) 418 Maple Ave. Vienna, VA 22180

security vault
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Works, Incorporated.

Date: 12-19-18 Drawn By: DEC

Revisions:


\(\frac{1}{1} \)

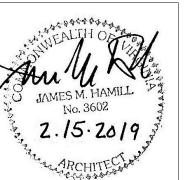\(\frac{3}{4} \)

Drawing Number:

A. 1
SVW Project Number: 10-19-0023
Cad File Name: Maple Ave

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Irving, Texas 75062
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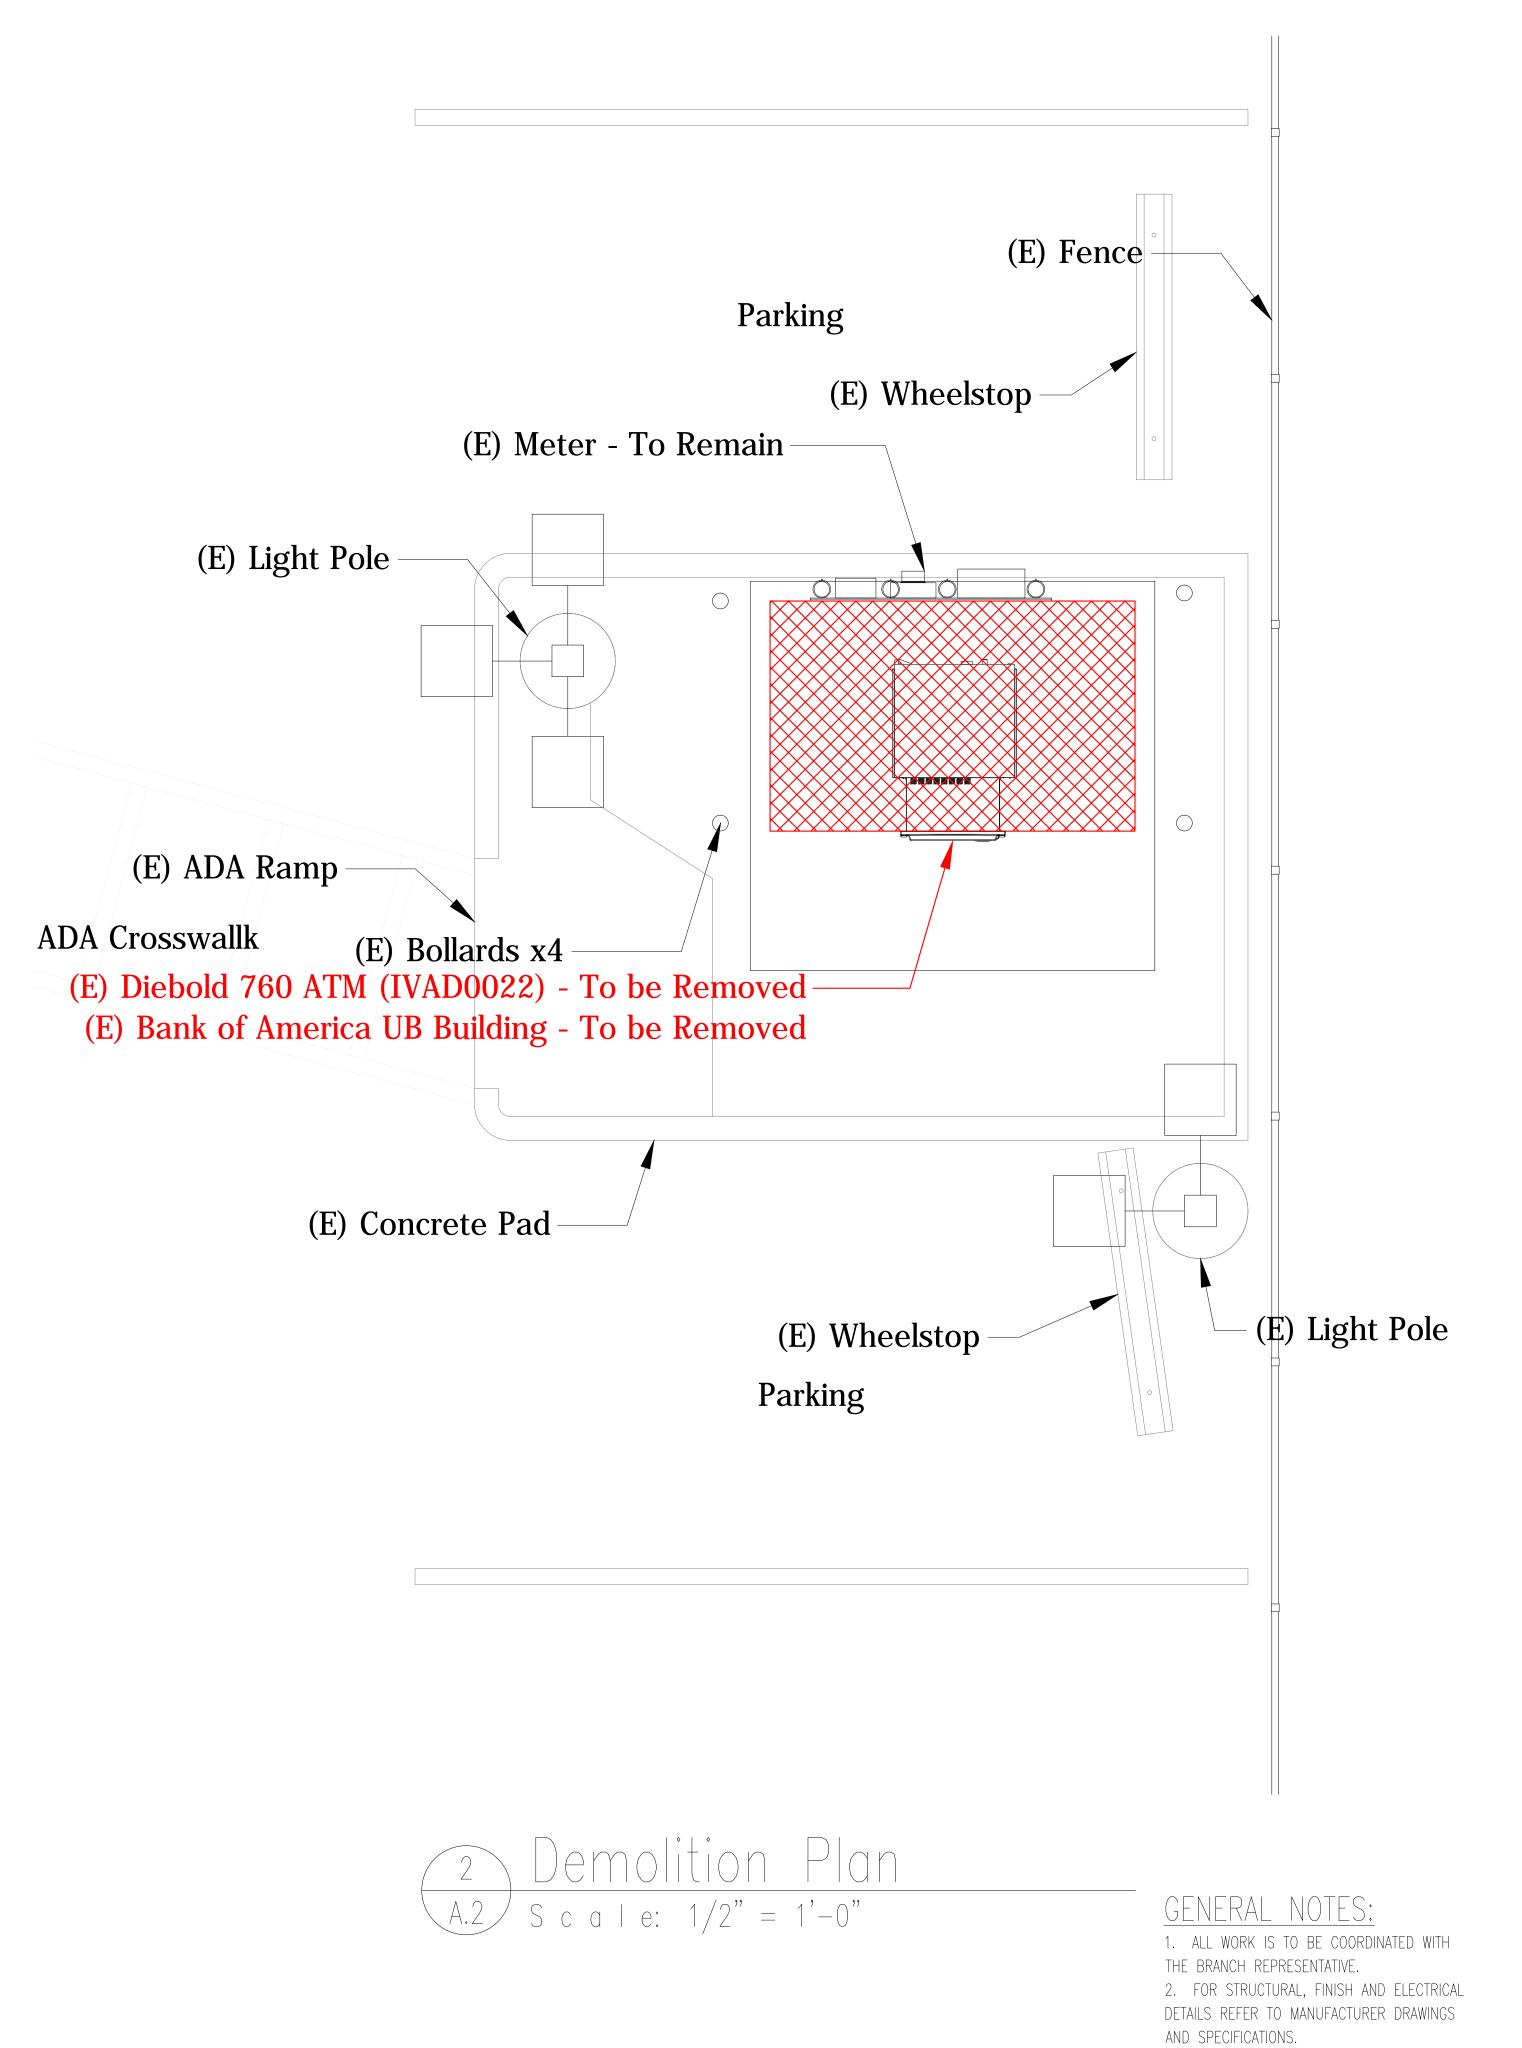
Date: 12-19-18 Drawn By: DE

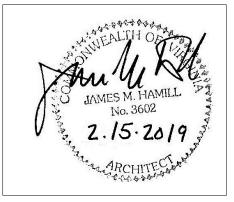
Drawing Number:

A.2

SVW Project Number: 10-19-0023

Cad File Name: Maple Ave



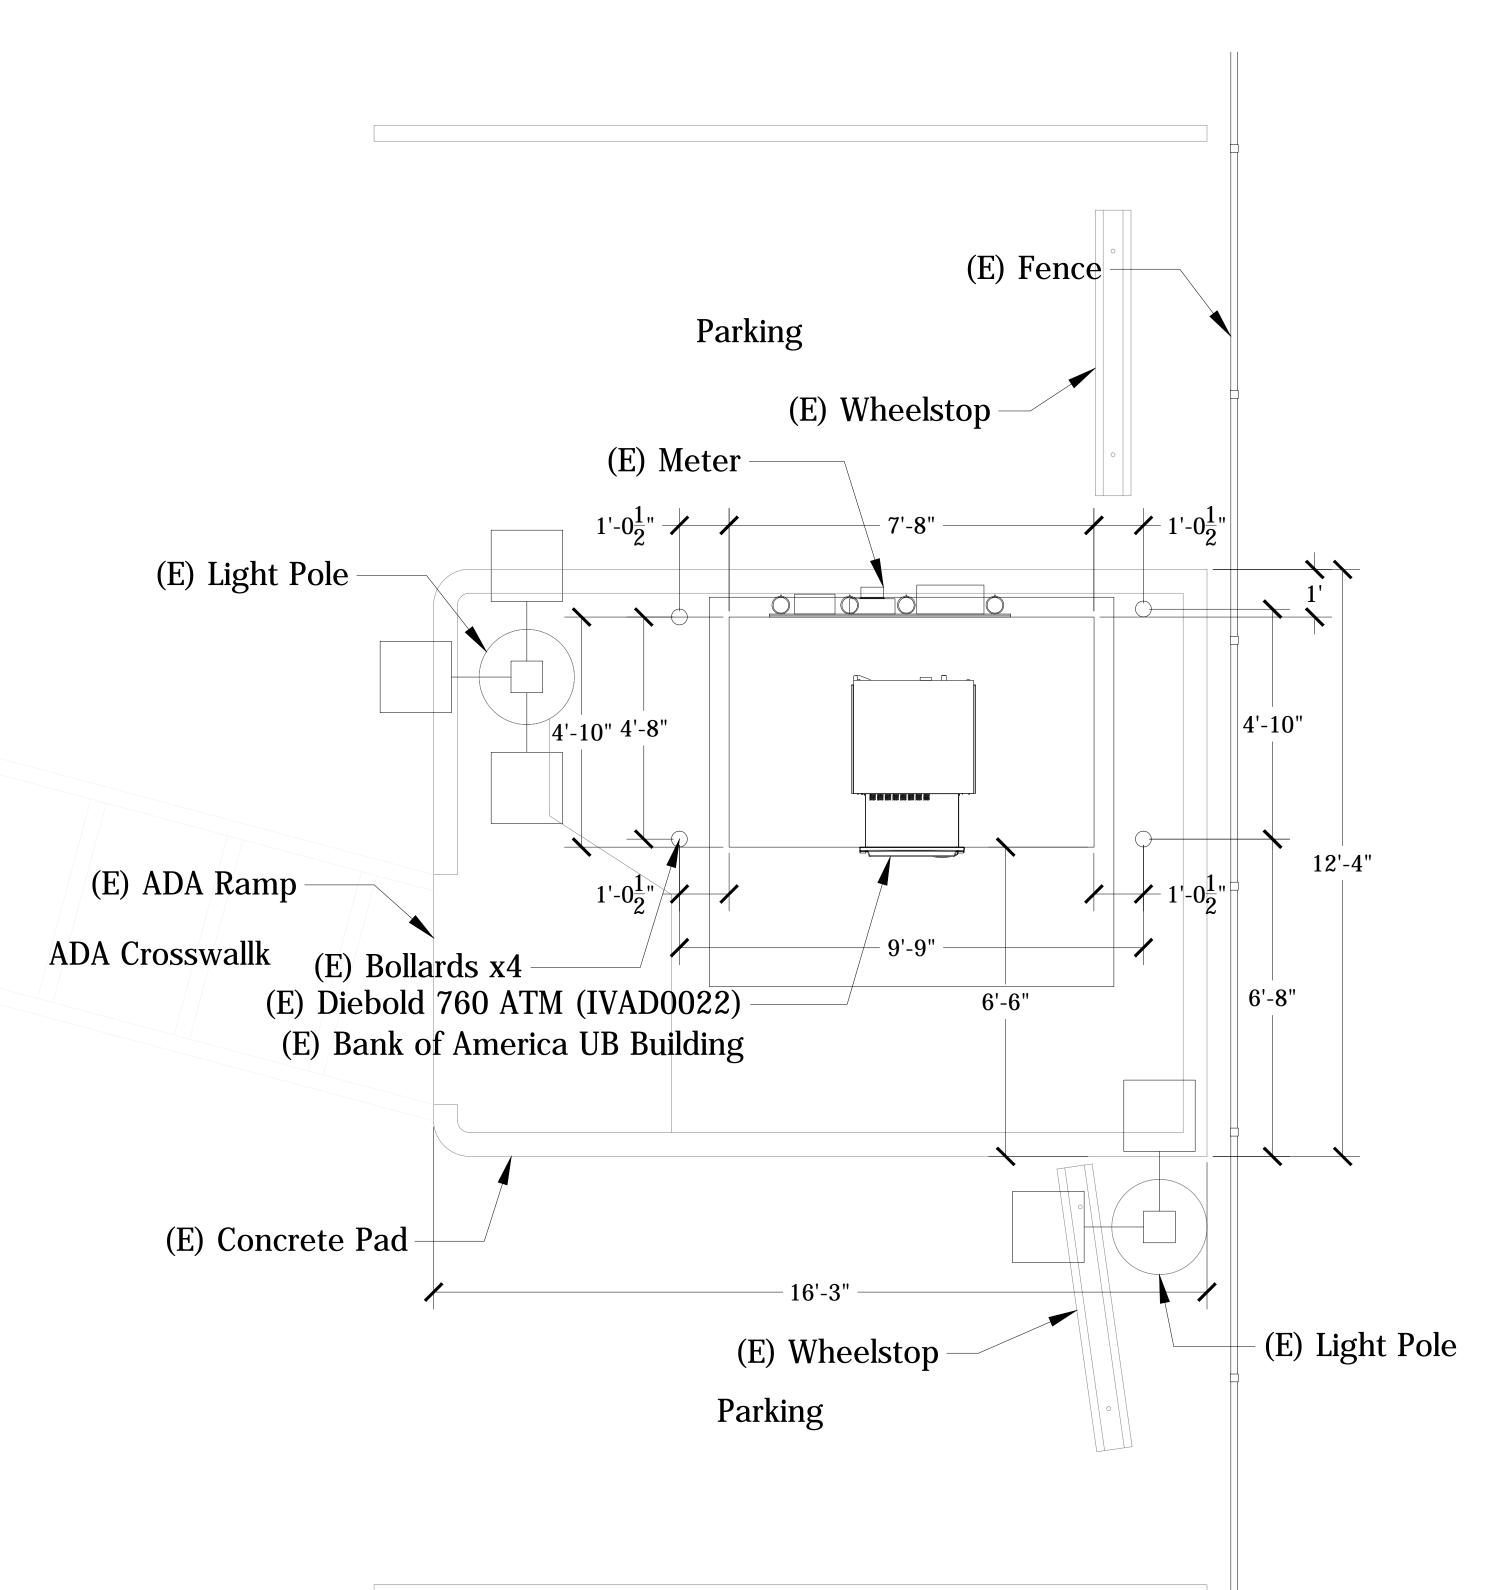

Existing Layout Plan

A.2 Scale: 1/2" = 1'-0"

Proposed Layout Plan

A.3 Scale: 1/2" = 1'-0"

Bank of America - Maple Ave. (I) 418 Maple Ave.


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Works, Incorporated.

Date: 12-19-18 Drawn By: DI

Revisions:

1
2

Drawing Number:

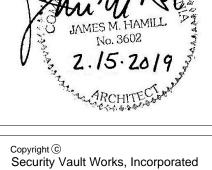A.3

SVW Project Number: 10-19-0023

Cad File Name: Maple Ave


GENERAL NOTES:

THE BRANCH REPRESENTATIVE.

AND SPECIFICATIONS.

1. ALL WORK IS TO BE COORDINATED WITH

2. FOR STRUCTURAL, FINISH AND ELECTRICAL DETAILS REFER TO MANUFACTURER DRAWINGS

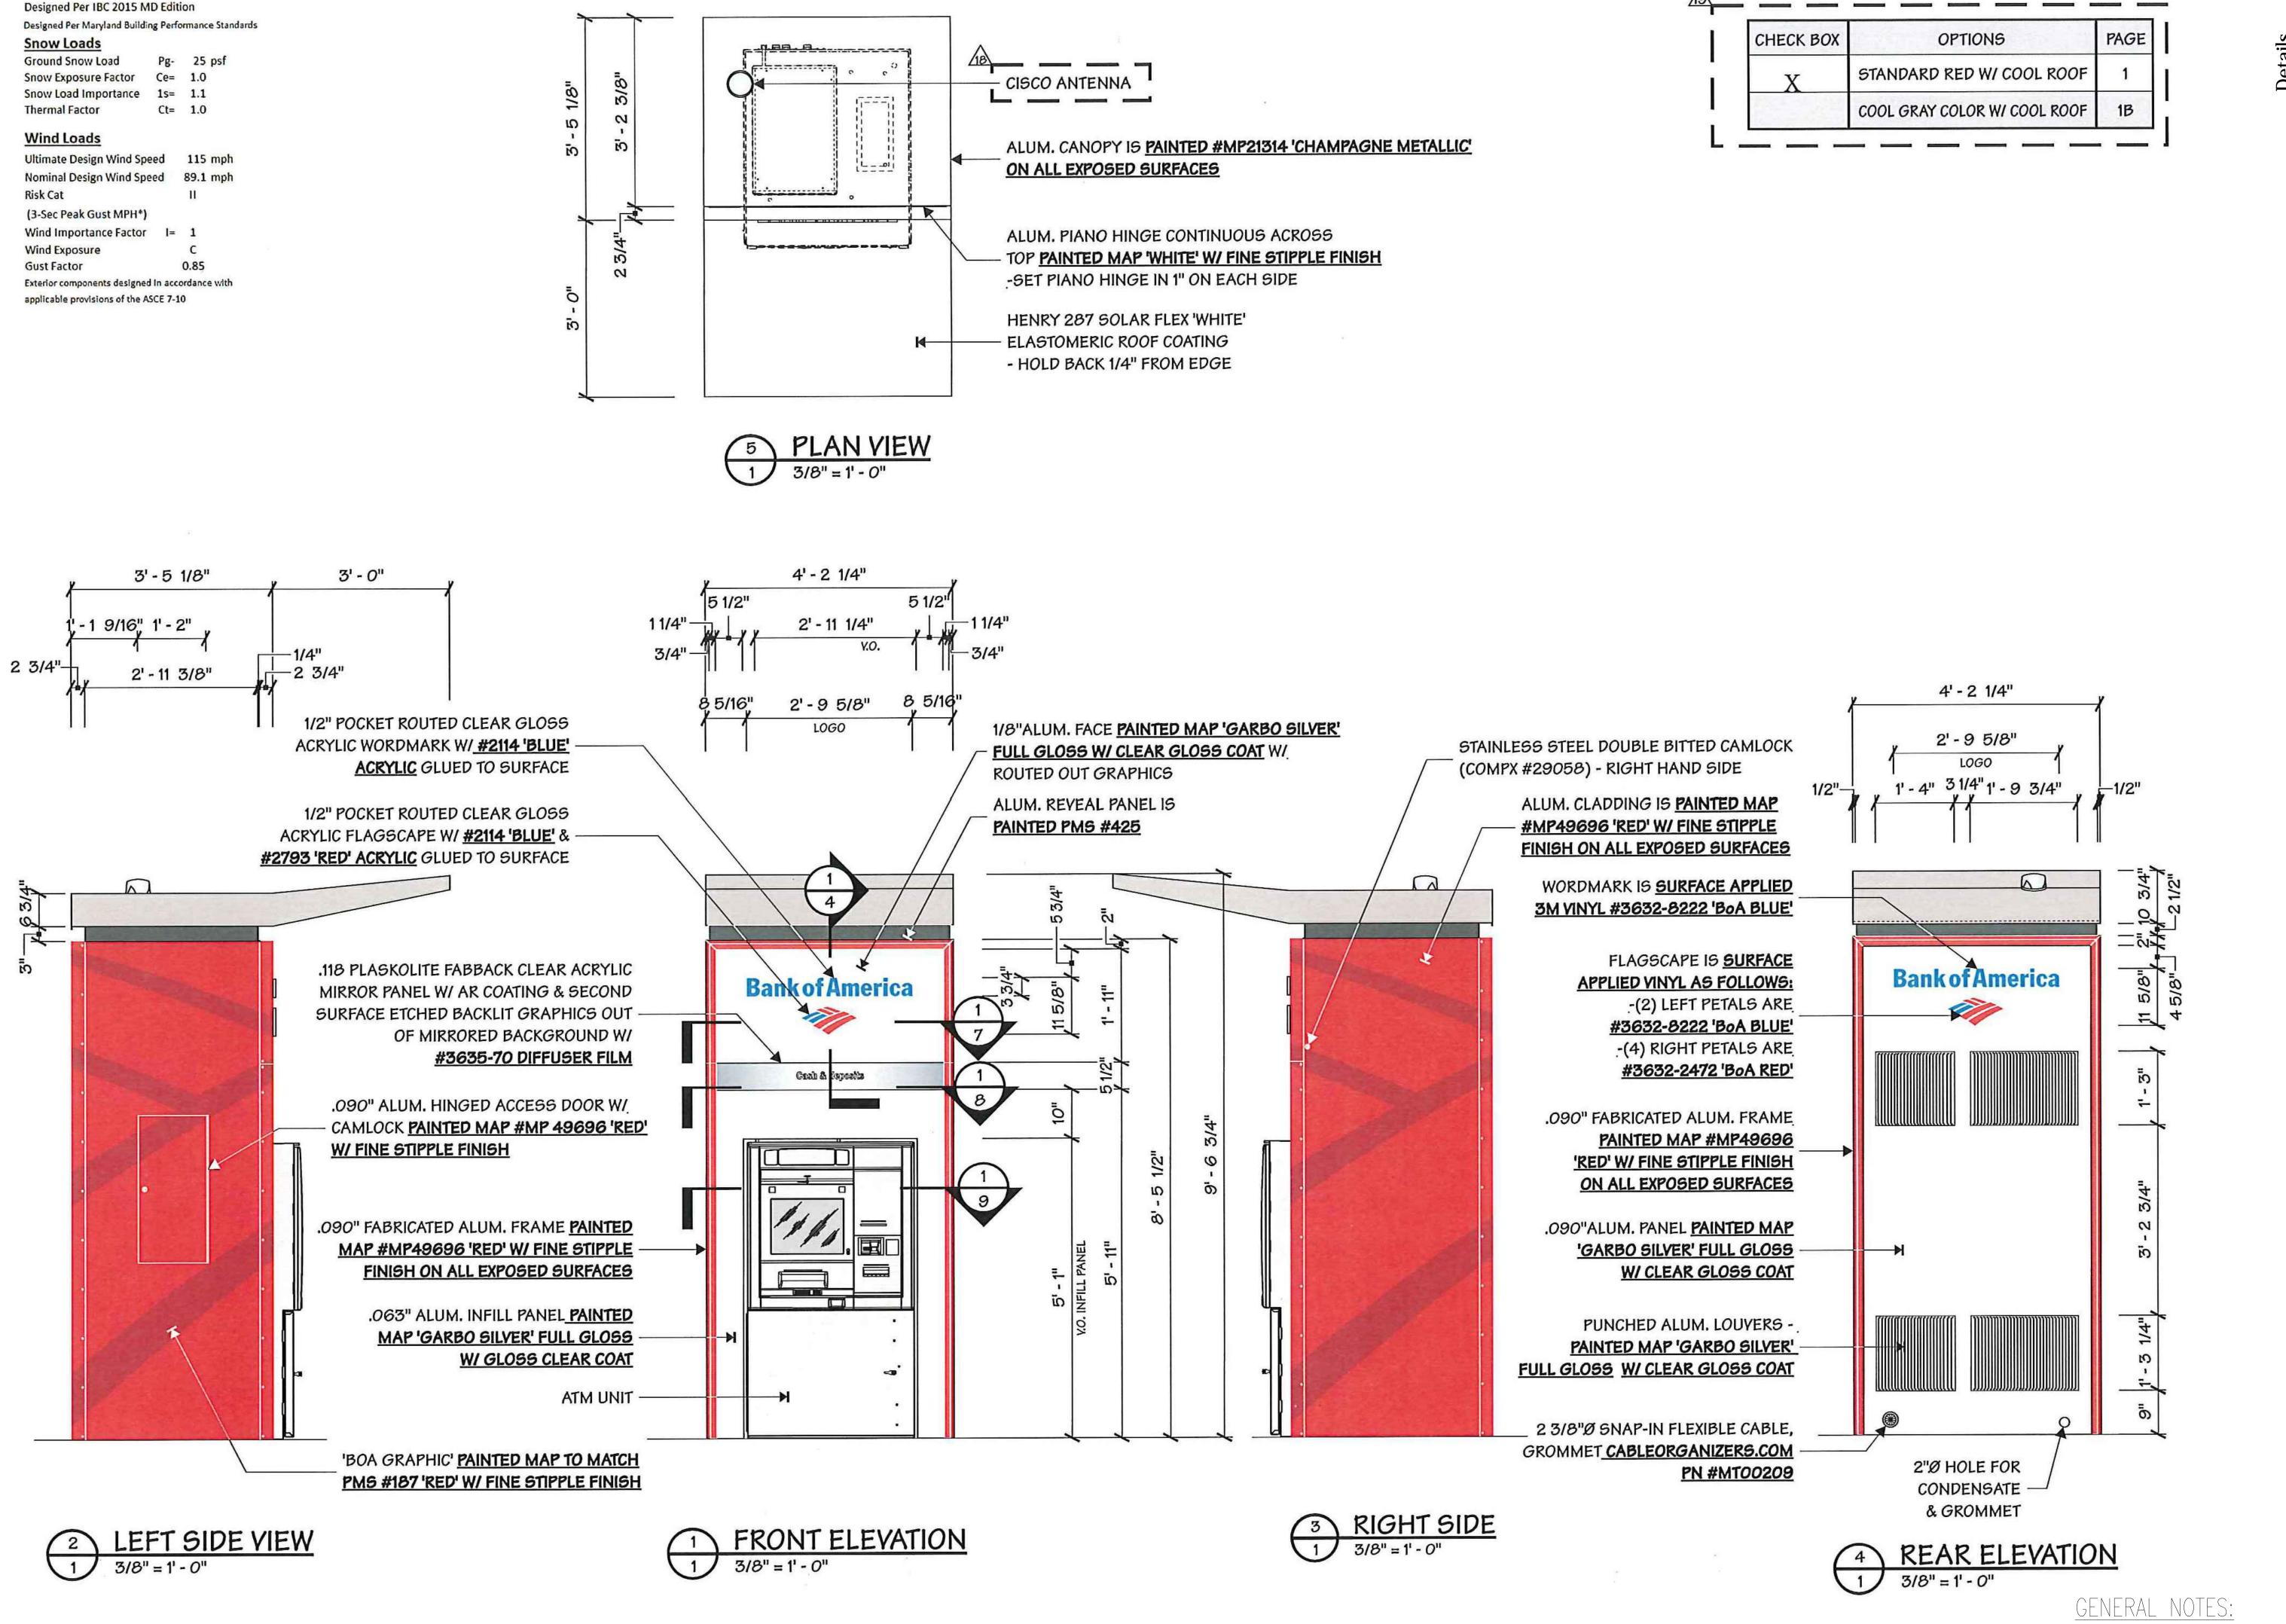

Details

Bank of America - Maple Ave. (IVAD0022)

Security Vault
Works

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Date: 12-19-18 Drawn By: DEC

Revisions:

1
2
1
Drawing Number:

A.4


SVW Project Number: 10-19-0023

Cad File Name: Maple Ave


1. FOR STRUCTURAL AND FINISH DETAILS

REFER TO MANUFACTURER DRAWINGS AND

SPECIFICATIONS.

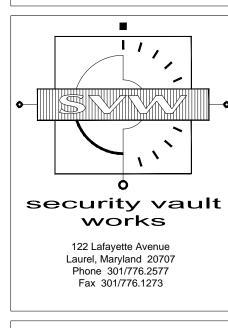

James M. Hamill 580 Decker Drive Irving, Texas 75062

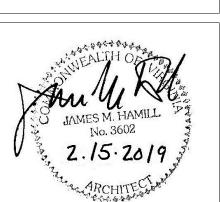

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Date: 12-19-18 Drawn By: DEG

Drawing Number:

Cad File Name: Maple Ave

SVW Project Number: 10-19-0023

AIR CONDITIONER DRAIN TUBE POWER , ALARM AND DATA INPUT 866 (341/8") 24 (¹⁵/₁₆") PROVIDE 76mm (3")
CLEAR SPACE FOR
AIR EXHAUST AIR CONDITIONER PROVIDE 102mm (4")
CLEAR SPACE FOR
AIR INTAKE (341/8") **PLAN VIEW**

HEIGHT - FROM BOTTOM OF SAFE DEPTH - FROM FRONT EDGE OF BEZEL

HEIGHT

1245mm (49")

1180mm (46⁷/₁₆")

1108mm

(43%")

963mm (37¹⁵/₁₆")

838mm (33")

765mm

1112mm (43¾")

995mm

987mm

(387/8")

965mm (38")

867mm

(341/8")

705mm (27¾")

DEPTH

257mm

(101/8")

234mm

(91/4")

204mm (8½6")

155mm

(61/8")

146mm (5¾")

89mm (3½")

74mm (2¹⁵/₁₆")

74mm

(2¹⁵/₁₆")

68mm (2¹/₁₆")

151mm (5¹⁵/₁₆")

74mm (2¹⁵/₁₆")

CONSUMER ACCESS DIMENSIONS

A TOP OF CONSUMER DISPLAY (19" DISPLAY)

TOP FUNCTION KEY (19" DISPLAY)

D BOTTOM OF CONSUMER DISPLAY

(H) CONTACTLESS CARD READER

() CARD READER / ActivEdge

E ActivCash

F EPP KEY


G RECEIPT PRINTER

J HEADPHONE JACK


L BAR CODE SCANNER

K ActivMedia

B of A TOP TOUCH POINT

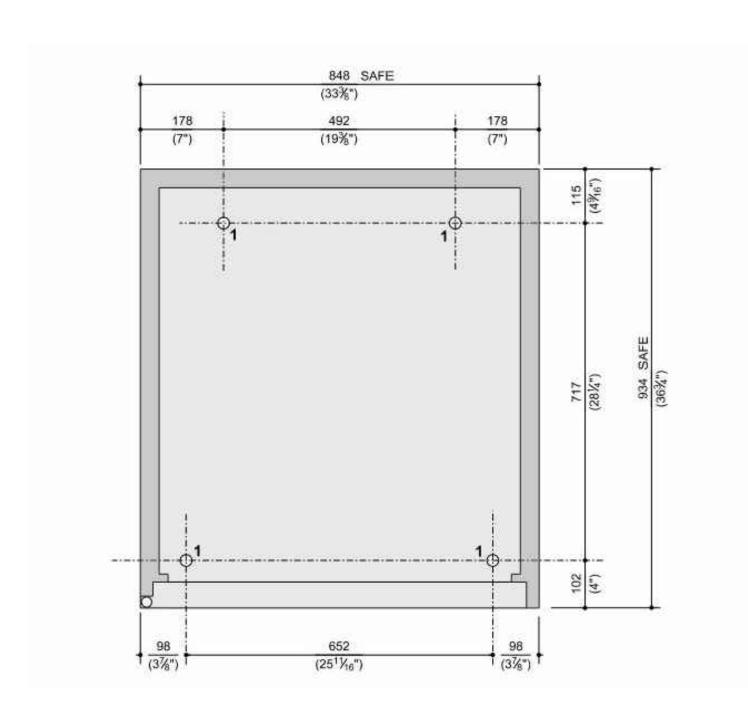

Diebold 7705 Mounting Detail
A.5 s c a l e: N.T.S

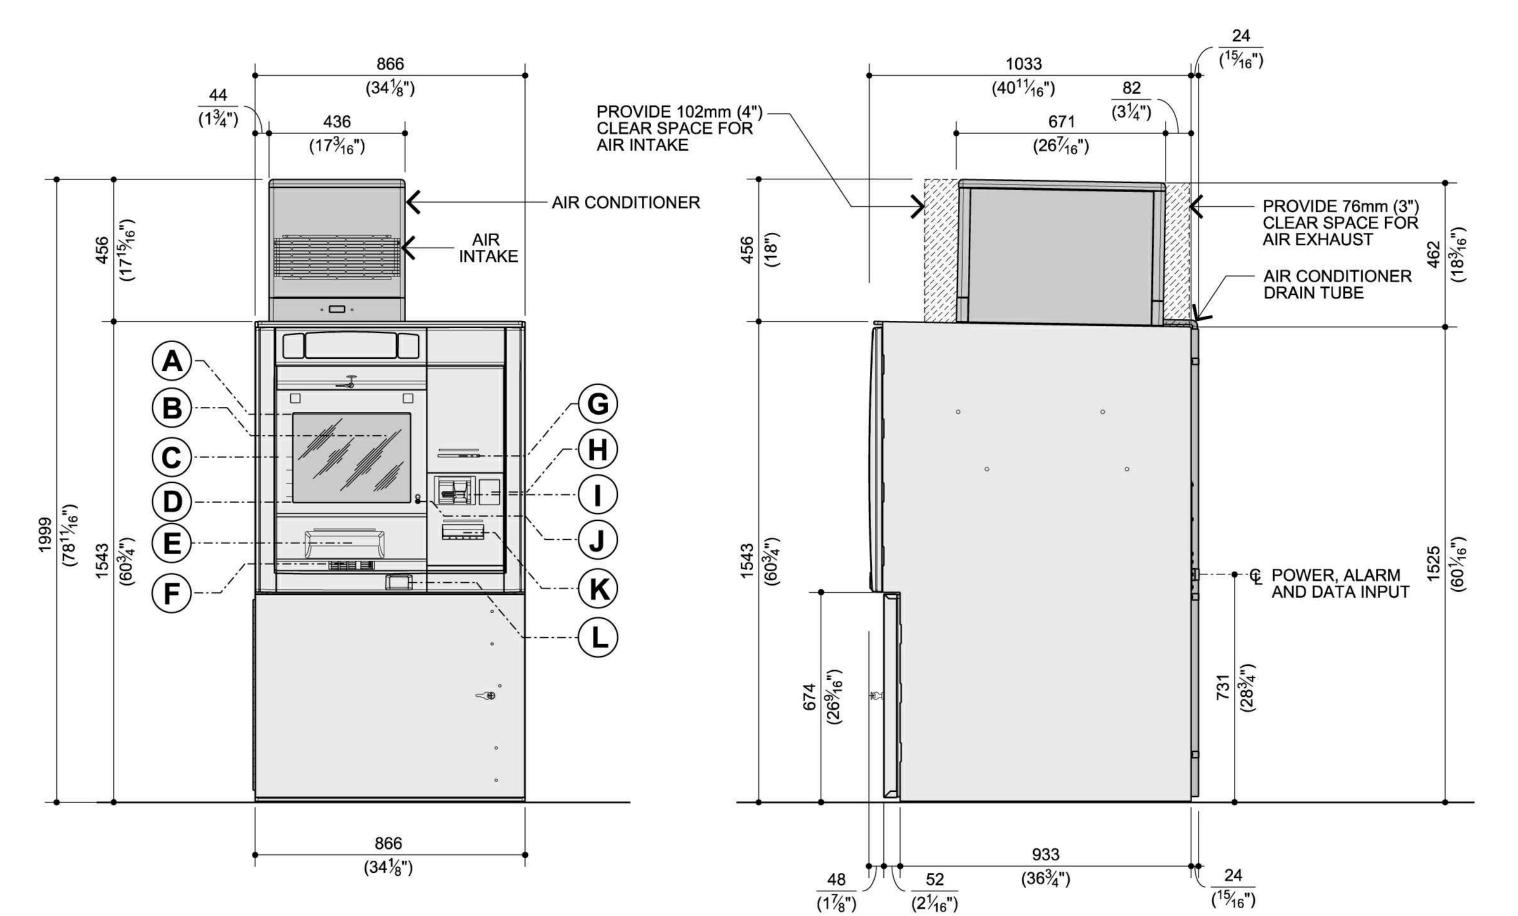


FRONT ELEVATION

SIDE ELEVATION


2 <u>Diebold 7705 Detail</u> A.5 S c a l e: 1" = 1'-0"

GENERAL NOTES: 1. FOR STRUCTURAL AND FINISH DETAILS REFER TO MANUFACTURER DRAWINGS AND SPECIFICATIONS.

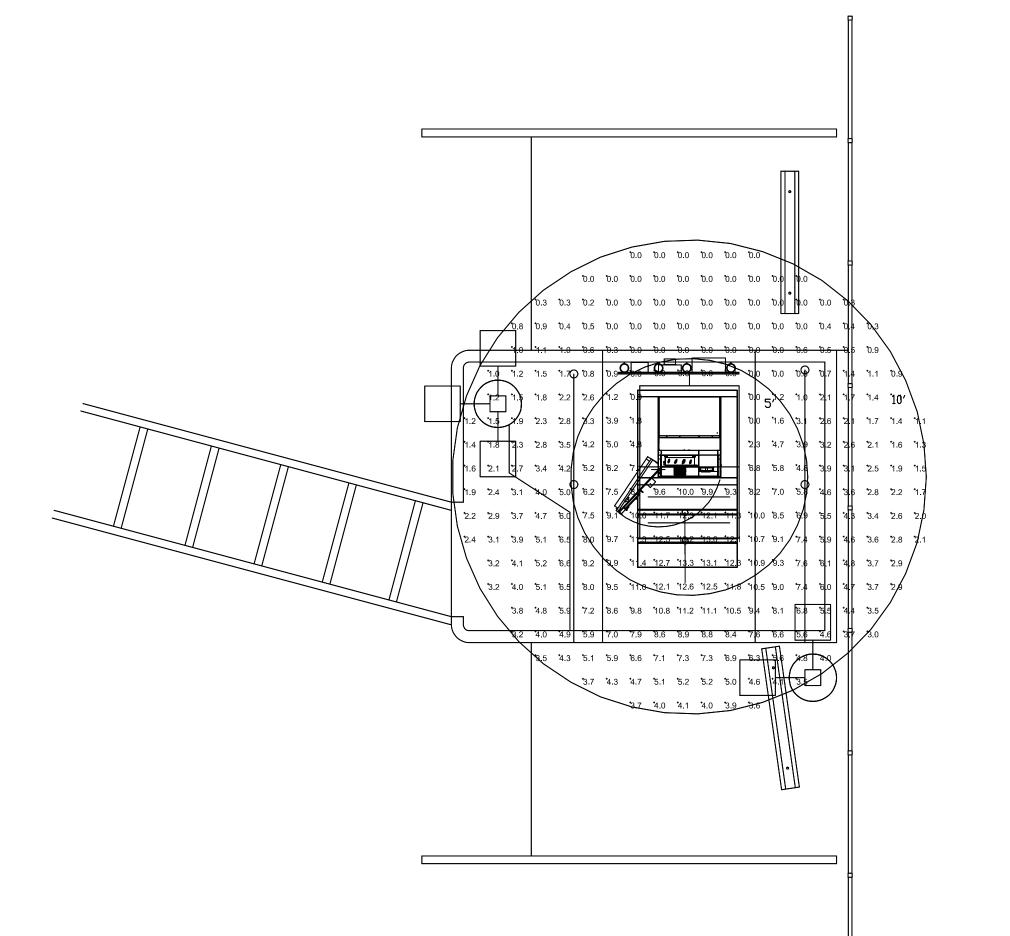


STATISTICS						
Description	Symbol	Avg	Max	Min	Max/Min	Avg/Min
5' radius	+	7.6 fc	13.3 fc	0.0 fc	N/A	N/A
10'adius	+	3.2 fc	11.2 fc	0.0 fc	N / A	N/A

LUMIN	AIRE S	CHEE	DULE						
Symbol	Label	Qty	Catalog Number	Description	Lamp	File	Lumens	LLF	Watts
\bigcirc	A	2				Batten-2FT-HO- -5000K- 1_IESNA2002(GEWH2450BA T)-no2_tcm201-	1000	1.00	14.7

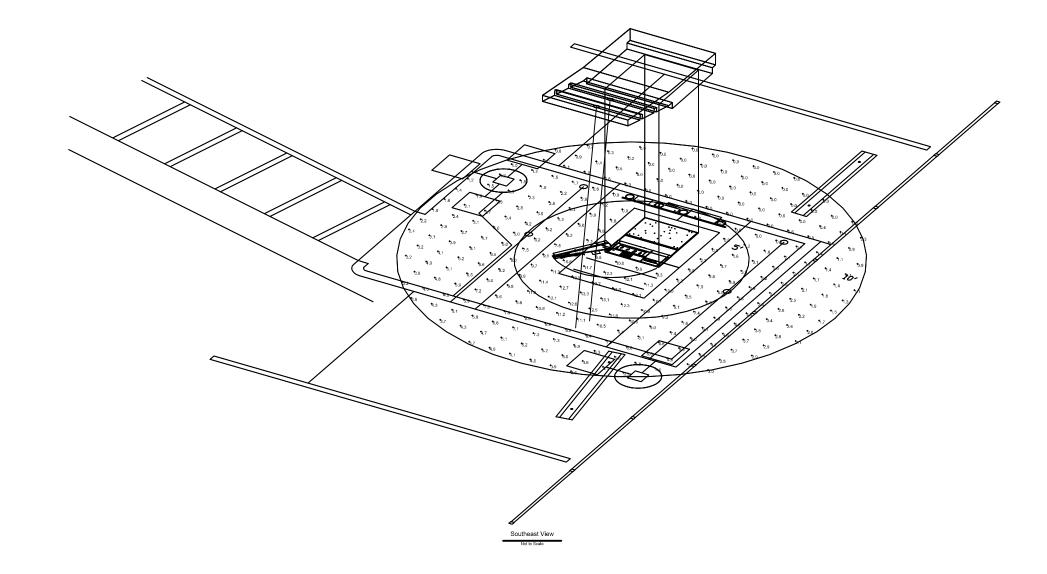

PHOTOMETRIC PLAN AND INFORMATION

SCALE: APPROX 1/4" = 1'-0"

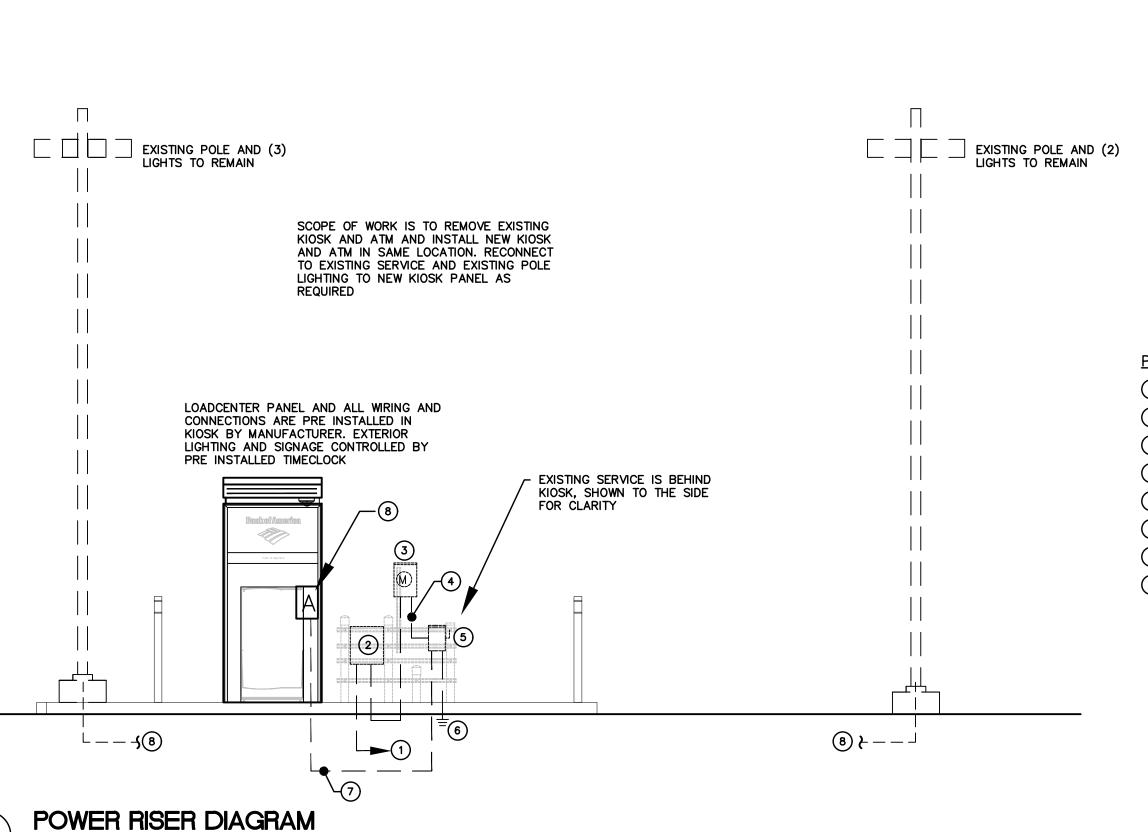

LOAD SU	JMMARY	LOAD PER N ART 220-35 IN KW	
NEW ATM KIOSK (AS	S PER ATM INSTALLATI PANEL 'A'):	ON DRAWING):	6.9 KW
TOTAL LOAD:	6.9 KW = 28.8 A @	240V, 1ø	

POWER RISER KEYED NOTES

- 1) EXISTING 100A, 120/240V, 1ø, 3W INCOMING SERVICE FROM POWER COMPANY TO REMAIN
- 2 EXISTING POWER COMPANY PULL BOX TO REMAIN
- 3 EXISTING 100A POWER COMPANY METER TO REMAIN
- 4 EXISTING 100A FEEDER: 3-#3, 1-1/2"C TO REMAIN
- 5 EXISTING 3P-100A DISCONNECT FUSED AT 100A, SERVICE ENTRANCE RATED, TO REMAIN
- 6 EXISTING #6 GROUND AS PER NEC TO REMAIN
- 7 EXISTING 100A FEEDER: 3-#3, 1-#6G, 1-1/2"C TO REMAIN. CONNECT TO NEW KIOSK PANEL AS REQUIRED
- 8 EXISTING LIGHT POLE CIRCUIT, CONNECT TO NEW KIOSK PANEL AS REQUIRED

PANEL	BUS SIZE 100A	VOLTAGE 120/240 1+,3W		M.L.O. MAIN BRKR. 100 AMP		KR.	FLUSH SURFACE_X		TYPE LOAD CENTER PANEL PRE INSTALLED IN ENCLOSURE BY MANUFACTURER			
C ITEM	C ITEM			Р ((KW)		LOAD (KW)		۱ ۱ ا	P	ITEM	С
I R		M P	O L E	A	В	A	В	M P	O L E			
1 MAIN BREAKER		100	2	-		0.2		20	1	UTIL RECEPT	2	
3 –		_	_		_		1.5	20	1	AC/HTR	4	
5 EXTER & TOPPER SIGN/ LIGHTS		20	1	0.4		0.5		20	1	TELE/ SECUR	6	
7 SPARE		20	1		_		2.5	30	1	АТМ	8	
9 SITE LIGHTING			20	1	1.8		_		20	1	SPARE	10
11 SPARE 20						_		-	20	1	SPARE	12
PHASE A KW: 2.9 PHASE B KW: 4.0 TOTAL KW 6.9 CONNECTED LOAD 28.8 AMPS												

PROFESSIONAL CERTIFICATION I, JAMES B. WYBLE, HEREBY CERTIFY THAT THESE
DOCUMENTS WERE PREPARED OR APPROVED BY ME, AND
THAT I AM A DULY LICENSED PROFESSIONAL ENGINEER UNDER
THE LAWS OF THE STATE OF VIRGINIA.

LICENSE #: 0402011033, EXPIRATION DATE: DECEMBER 31, 2020

1. LOAD CENTER SHALL BE RATED FOR AVAILABLE SHORT CIRCUIT CURRENT.

J. B. WYBLE & ASSOCIATES, P.A. CONSULTING ENGINEERS

Jwyble@jbwpa.com

7950 NORFOLK AVENUE BETHESDA, MARYLAND 20814 (301) 654-1410

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Project Number: JBW1905

Cad File Name:

(VAD0022)

AMERICA

9

BANK

security vault works


122 Lafayette Avenue Laurel, Maryland 20707 Phone 301/776.2577 Fax 301/776.1273

GENERAL NOTES

- 1. ALL ELECTRICAL WORK SHALL BE IN ACCORDANCE WITH THE NATIONAL ELECTRICAL CODE AND ALL LOCAL CODES HAVING JURISDICTION.
- 2. THE ELECTRICAL CONTRACTOR SHALL OBTAIN ALL PERMITS AND PAY SUCH FEES AS MAY BE NECESSARY FOR INSPECTIONS, TESTS, AND OTHER SERVICES NECESSARY FOR THE COMPLETION OF HIS WORK.
- 3. CONTRACTOR SHALL VISIT THE SITE AND EXAMINE CONDITIONS OF THE PREMISES AND THE CHARACTER AND EXTENT OF WORK REQUIRED PRIOR TO SUBMISSION OF BIDS. ANY DIFFICULTIES IN COMPLYING WITH THE DRAWINGS AND SPECIFICATIONS SHALL BE BROUGHT TO THE ATTENTION OF THE ARCHITECT/ENGINEER BEFORE BIDDING.
- 4. IT IS THE INTENT OF THESE DRAWINGS AND OTHER RELATED DOCUMENTS TO PRODUCE A COMPLETE AND FUNCTIONING ELECTRICAL SYSTEM. THE ELECTRICAL CONTRACTOR SHALL PROVIDE ALL LABOR, MATERIAL AND OTHER SERVICES AS MAY BE NECESSARY TO ACHIEVE THIS PRODUCT. IT SHALL BE THE RESPONSIBILITY OF THE CONTRACTOR TO BRING TO THE ATTENTION OF THE ARCHITECT ANY DISCREPANCIES IN THE PLANS AND SPECIFICATIONS THAT WILL AFFECT THE WORK. PRIOR TO SUBMISSION OF HIS BID PRICE.
- 5. IF, DURING THE COURSE OF THE WORK, THE CONTRACTOR EXPER-IENCES A PROBLEM WITH THE PERFORMANCE OF THE INSTALLATION RELATIVE TO THE PLANS AND SPECIFICATIONS, THE NATIONAL ELEC-TRICAL CODE. OTHER APPLICABLE CODES AND GOVERNING DOCUMENTS. THE CONTRACTOR SHALL BRING THE PROBLEM TO THE ATTENTION OF THE ARCHITECT AND/OR THE ENGINEER FOR RESOLUTION PRIOR TO EXECUTION OF THE WORK.
- 6. ALL MATERIAL SHALL BE NEW AND BEAR THE U.L. LABEL LISTED APPROVAL FOR ITS INSTALLED APPLICATION.
- 7. ALL MAJOR COMPONENTS OF THE ELECTRICAL SYSTEMS SUCH AS SAFETY DISCONNECT SWITCHES, AND PANELBOARDS SHALL BE BY THE SAME MANUFACTURER AND SHALL BE ONE OF THE FOLLOWING: SQUARE "D" COMPANY, GENERAL ELECTRIC, OR WESTINGHOUSE.
- 8. FOR ALL EQUIPMENT RATED 100AMPS OR LESS, E.C. SHALL PROVIDE TERMINATIONS WHICH ARE LISTED FOR USE AT 75°C OR PROVIDE WIRING SIZED USING THE 60°C AMPACITY.
- 9. PROVIDE "LOCKING" TYPE DEVICE ON CIRCUIT BREAKER CONNECTED TO AFTER HOUR DEPOSIT AND AUTOMATIC TELLER MACHINES.

- 10. ALL SWITCHES, DUPLEX RECEPTACLES, AND TELEPHONE OUTLETS TO BE FLUSH MOUNTED, THROUGHOUT.
- 11. ALL EQUIPMENT SHALL BE GROUNDED AND BONDED AS REQUIRED IN ACCORDANCE WITH N.E.C. ARTICLE 250.
- 12. ELECTRICAL CONTRACTOR SHALL COORDINATE WITH ATM SUPPLIER/INSTALLER FOR EXACT LOCATION OF EQUIPMENT.
- 13. THE CONTRACTOR SHALL GUARANTEE ALL HIS WORK AND MATERIALS FOR A PERIOD OF ONE YEAR AFTER ACCEPTANCE BY OWNER.
- 14. ELECTRICAL PLANS ARE DIAGRAMMATIC. DO NOT SCALE DRAWINGS.
- 15. CONSULT PLANS OF ALL OTHER TRADES FOR COORDINATION AND FOR RELATED AND ADJOINING WORK.
- 16. ALL DEVICES AND COVERPLATES SHALL BE CONSTRUCTED OF MOLDED NYLON MATERIALS. COLOR OF DEVICES AND MATCHING COVERPLATES SHALL BE AS SELECTED BY THE ARCHITECT.
- 17. ALL WORK SHALL BE DONE AT SUCH TIMES AND IN SUCH A MANNER AS WILL LEAST INTERFERE WITH THE MAINTENANCE AND OPERATION OF ALL RELATED OR AFFECTED SYSTEMS. ALL POWER OUTAGES SHALL BE COORDINATED WITH OWNER.
- 18. THE CORRECT NUMBER OF WIRES MAY NOT BE INDICATED FOR ALL CIRCUITS, ONLY THOSE WHERE CLARIFICATION IS NECESSARY. THE ELECTRICAL CONTRACTOR SHALL PROVIDE ALL WIRES NECESSARY FOR THE PROPER FUNCTION OF THE SYSTEM.
- 19. ALL EMPTY CONDUIT RUNS IN EXCESS OF 10 FT. SHALL BE PROVIDED WITH A PULL WIRE OR FISH TAPE/CORD.
- 20. ALL BRANCH CIRCUIT CONDUCTORS FROM THE PANEL TO THE FIRST OUTLET SHALL BE INCREASED TO THE NEXT LARGER SIZE WHERE THE LENGTH OF THE HOME RUN EXCEEDS 100 FT. ON 120/208V CIRCUITS.
- 21. CONTRACTOR SHALL BE RESPONSIBLE FOR PROPER SIZING OF ALL FEEDERS AND OVERLOAD DEVICES BASED ON ACTUAL NAMEPLATE RATINGS ON THE EQUIPMENT BEING INSTALLED.
- 22. ALL NEW EQUIPMENT SHALL BE RATED FOR AVAILABLE SHORT CIRCUIT CURRENT. PLEASE COORDINATE WORK BEFORE ORDERING EQUIPMENT.

GENERAL NOTES: 1. ALL WORK IS TO BE COORDINATED WITH THE EQUIPMENT MANUFACTURER

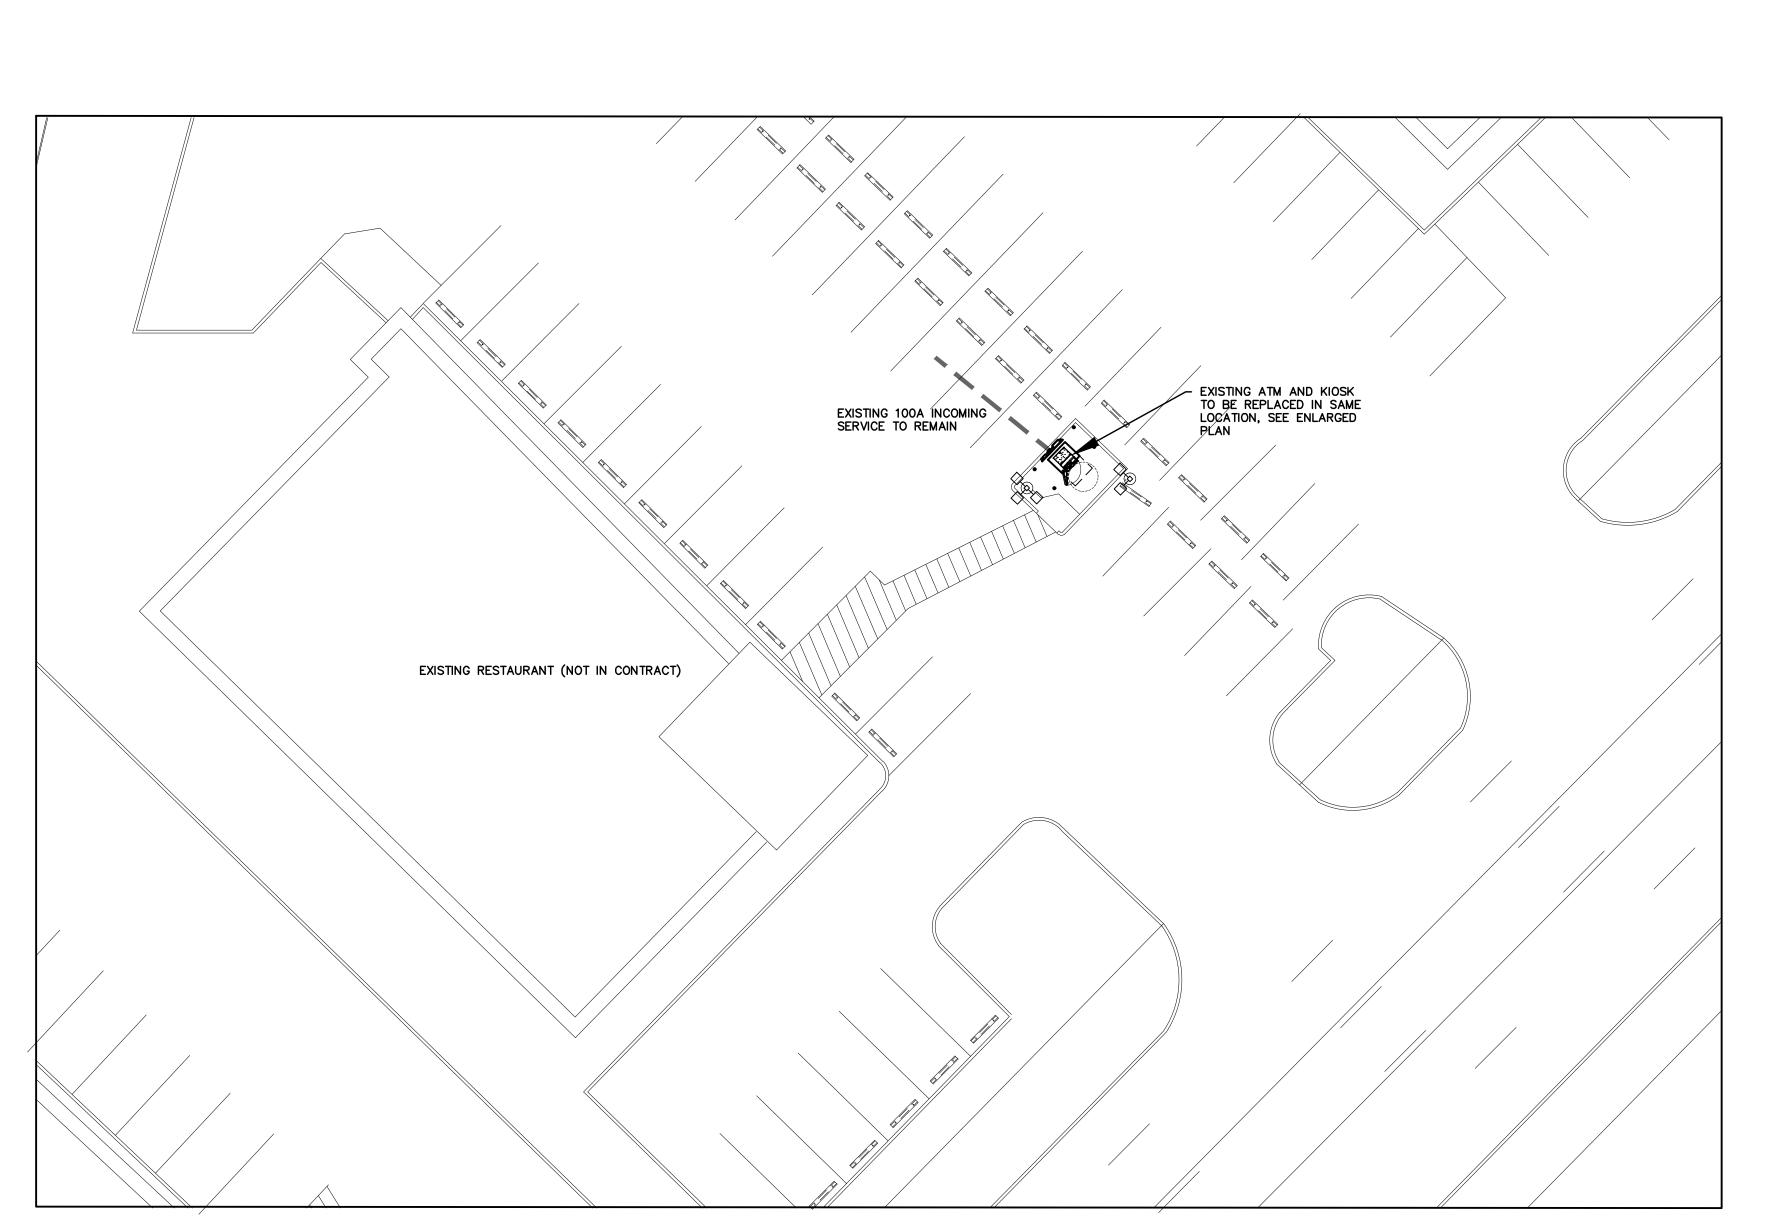

VICINITY PLAN

SCALE: APPROX 1/64"=1'-0"

PLENUM.

1. DATA LINES TO BE INSTALLED BY ELECTRICAL

2. ALARM AND VIDEO LINES TO BE INSTALLED BY

ELECTRICAL SYMBOL LIST

---- EXISTING EQUIPMENT TO REMAIN

CONNECT NEW TO EXISTING

NEW EQUIPMENT

LOW VOLTAGE NOTES:

CONTRACTOR.

ELECTRICAL CONTRACTOR. 3. 2 DATA LINES - CAT5e OR BETTER. 4. 2 ALARM LINES - 22ga 6 CONDUCTOR STNADARD 5. 2 VIDEO LINES - COAX 20 AWG SOLID BARE COPPER 16/30 STANDARD STRANDED BARE COPPER. - EXISTING INCOMING SERVICE TO REMAIN. SEE RISER EXISTING ATM MACHINE AND KIOSK TO BE REPLACED. CONNECT TO EXISTING SERVICE AS REQUIRED. SEE EXISTING POLE TO REMAIN

ELECTRICAL PLAN SCALE: APPROX 1/4" = 1'-0"

JOB RESPONSIBILITY:

- A. PROVIDE ADEQUATE STORAGE FACILITIES FOR MATERIALS AND
- EQUIPMENT DURING THE PROGRESS OF THE WORK. B. BE RESPONSIBLE FOR THE CONDITION OF ALL MATERIAL AND EQUIPMENT EMPLOYED IN THE ELECTRICAL INSTALLATION UNTIL FINAL ACCEPTANCE BY THE OWNER. PROTECT SAME FROM ANY CAUSE WHATSOEVER.
- C. BE RESPONSIBLE FOR THE REPLACEMENT OF ALL DAMAGED OR DEFECTIVE WORK, MATERIALS OR EQUIPMENT. DO NOT INSTALL SENSITIVE OR DELICATE EQUIPMENT UNTIL MAJOR CONSTRUCTION WORK IS COMPLETED.
- D. OBSERVE AND CONFORM TO APPLICABLE SAFETY REGULATIONS, INCLUDING THOSE REQUIRED BY THE OWNER'S REPRESENTATIVE.
- ERECT AND MAINTAIN SUITABLE BARRIERS, PROTECTIVE DEVICES, LIGHTS AND WARNING SIGNS FOR THE PROTECTION OF OCCUPANTS, TRANSIENTS AND WORKMEN FROM DANGER DUE TO WORK PERFORMED BY THE ELECTRICAL CONTRACTOR.
- F. MAKE GOOD ANY DAMAGE TO THE WORK CAUSED BY FLOODS, STORMS, ACCIDENTS, ACTS OF GOD, ACTS OF NEGLIGENCE, STRIKES, VIOLENCE OR THEFT UP TO THE TIME OF FINAL ACCEPTANCE BY THE OWNER.
- BE RESPONSIBLE FOR ANY LOSS OR INJURY TO PERSONS OR PROPERTY RESULTING FROM NEGLECT OR ANY OTHER CAUSES ON THE PART OF THE
- H. DO NOT LEAVE ANY ELECTRICAL WORK IN A HAZARDOUS CONDITION, EVEN TEMPORARILY.
- ERECT, MAINTAIN AND FINALLY REMOVE ALL SCAFFOLDS, STAGING, FORMS, PLATFORMS AND LADDERS REQUIRED FOR THE ELECTRICAL
- J. DO NOT INSTALL WORK FOR WHICH AN EXTRA CHARGE IS TO BE MADE WITHOUT WRITTEN APPROVAL FROM THE OWNER'S REPRESENTATIVE AND THE OWNER. A WRITTEN REQUEST FOR EXTRA WORK SHALL STATE THE NATURE OF THE WORK, BY WHOM REQUESTED, AND THE PRICE TO BE CHARGED.

PROFESSIONAL CERTIFICATION . JAMES B. WYBLE. HEREBY CERTIFY THAT THESE DOCUMENTS WERE PREPARED OR APPROVED BY ME, AND THAT I AM A DULY LICENSED PROFESSIONAL ENGINEER UNDER THE LAWS OF THE STATE OF VIRGINIA.

LICENSE #: 0402011033, EXPIRATION DATE: DECEMBER 31, 2020

J. B. WYBLE & ASSOCIATES, P.A. CONSULTING ENGINEERS 7950 NORFOLK AVENUE BETHESDA, MARYLAND 20814 (301) 654-1410 Jwyble@jbwpa.com

security vault works 122 Lafayette Avenue Laurel, Maryland 20707 Phone 301/776.2577 Fax 301/776.1273

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Date: 2/05/2019 Drawn By: -

Revisions: **Drawing Number:** Project Number: JBW1905

Cad File Name: