

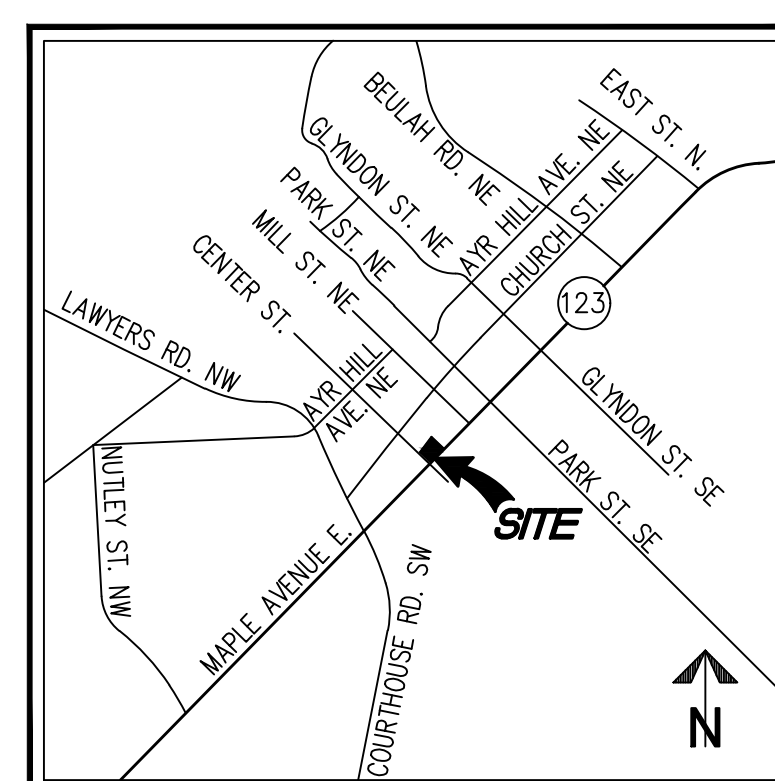
# SUNRISE OF VIENNA

100, 102, & 112 MAPLE AVENUE EAST, VIENNA, VA 22180

# MAPLE AVENUE COMMERCIAL (MAC) - REZONING AND CONDITIONAL USE PERMIT

INITIAL SUBMISSION - SEPTEMBER 5, 2018

RE-SUBMISSION - JANUARY 15, 2019



VICINITY MAP SCALE: 1"=2000'

## DEVELOPMENT TEAM

**OWNER**

KIRSCHNER ENTERPRISES INC.  
5225 SYMPHONY FOREST LN N  
BETHESDA, MD 20852

**APPLICANT**

**SUNRISE DEVELOPMENT, INC.**  
7902 WESTPARK DR  
MCLEAN, VA 22102  
703-774-1873  
CONTACT: JERRY LIANG

ATTORNEY

**WOMBLE BOND DICKINSON (US) LLP**  
8065 LEESBURG PIKE, 4TH FLOOR  
TYSONS CORNER, VA 22182-2738  
703-394-2261  
**CONTACT: SARA MARISKA**

## ARCHITECT

**RUST | ORLING ARCHITECTURE**  
1215 CAMERON STREET  
ALEXANDRIA, VA 22314  
703-836-3205  
**CONTACT: SCOTT FLEMING**

## CIVIL ENGINEER/LANDSCAPE ARCHITECT



WALTER L. PHILLIPS, INC.  
207 PARK AVENUE  
FALLS CHURCH, VA 22046  
703.532.6163  
CONTACT: AARON VINSON, P.E.

## SHEET INDEX

- P-0101 COVER SHEET
- P-0102 NOTES AND TABULATIONS
- P-0201 CONTEXT PLAN
- P-0202 EXISTING CONDITIONS PLAN
- P-0203 REZONING PLAT
- P-0301 CONCEPT PLAN
- P-0302 TRUCK TURN EXHIBIT
- P-0303 OPEN SPACE AND IMPERVIOUS SURFACE EXHIBIT
- P-0501 STORMWATER MANAGEMENT NARRATIVE AND DETAILS
- P-0502 OUTFALL MAP AND VRRM SPREADSHEET
- L-0301 LANDSCAPE PLAN
- L-0401 LANDSCAPE NOTES AND DETAILS
- A1.1 ARCHITECTURAL SITE PLAN / GROUND FLOOR PLAN
- A1.2 FLOOR PLANS
- A1.3 FLOOR PLANS
- A2.1 EXTERIOR ELEVATIONS
- A2.2 EXTERIOR ELEVATIONS
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- A3.2 SECTION
- A4.1 RENDERINGS
- A4.2 RENDERINGS
- E-001 SIGHT LIGHTING - ELECTRICAL

# COVER SHEET

**SUNRISE OF VIENNA**  
**MAC REZONING PLAN**  
**100, 102 & 112 MAPLE AVENUE EAST**  
**TOWN OF VIENNA, VIRGINIA 22180**

<b>WALTER L. PHILLIPS</b> N C O R P O R A T E D    ESTABLISHED 1945		DATE: 09/05/2018, 01:15/2019		SCALE: N.T.S.	
 		Engineers • Surveyors • Planners Landscape Architects • Arborists 207 PARK AVENUE FALLS CHURCH, VIRGINIA 22046 (703) 532-6163 Fax (703) 533-1301 <a href="http://www.WLPINC.com">www.WLPINC.com</a>		DRAWN: TPB CHECKED: AV	

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Tree Inventory

Tree Inventory - Sunrise Vienna							
Tree #	Botanical Name	Common Name	Size DBH (in)	Critical Root Zone (CRZ) Radius (ft)	Species Rating (%)	Condition%	Removal
Tree Survey Information Completed by Walter Phillips, Inc - Arborist Ben Schiffer- ISA # MA-5385A #8/17/2018							
101	Acer buergeranum	Trident maple	8"	12'	0%	66%	X
102	Acer buergeranum	Trident maple	6"	9'	0%	66%	X
103	Acer buergeranum	Trident maple	9"	14'	0%	66%	
104	Acer buergeranum	Trident maple	6"	9'	0%	66%	X
105	Acer buergeranum	Trident maple	8"	12'	0%	66%	
106	Acer buergeranum	Trident maple	6"	9'	0%	66%	X
107	Lagerstroemia indica	Crape Myrtle	7"	11'	78%	69%	X
108	Acer buergeranum	Trident maple	6"	9'	0%	66%	X
109	Lagerstroemia indica	Crape Myrtle	12"	18'	78%	69%	X
110	Lagerstroemia indica	Crape Myrtle	12"	18'	78%	69%	X
111	Lagerstroemia indica	Crape Myrtle	12"	18'	78%	69%	X
112	Lagerstroemia indica	Crape Myrtle	11"	17'	78%	75%	X
113	Ilex x Nellie Stevens	Nellie Stevens holly	8"	12'	0%	75%	X
DBH = Diameter at Breast Height (measured 4.5 feet above ground)							

NOTE: SEE SHEET P-0202 FOR EXISTING TREE LOCATIONS.

NOTES

1. THE PROPERTY DELINEATED ON THIS PLAT IS DESIGNATED BY FAIRFAX COUNTY AS TAX MAP REFERENCE NUMBER 0384-02-0125A AND IS ZONED C-2.
2. THE PROPERTY IS NOW IN THE NAME OF KIRSCHNER ENTERPRISES, INC, AS RECORDED IN DEED BOOK 23935 AT PAGE 1680, AMONG THE LAND RECORDS OF FAIRFAX COUNTY, VIRGINIA.
3. TOTAL AREA OF THE PROPERTY IS 32,130 OR 0.7376 (SURVEYED) 32,264 SQUARE FEET (RECORD)
4. THERE ARE NO ENVIRONMENTALLY SENSITIVE OR HISTORICAL FEATURES KNOWN TO EXIST ON THIS SITE.

REQUESTED MODIFICATIONS SUMMARY

1. REQUEST TO REDUCE LOADING WIDTH REQUIREMENT FROM 15 FT/50 FT BUILDING WIDTH TO 15 FT.
2. REQUEST TO REDUCE BIKE PARKING REQUIREMENT FROM 27 SPACES TO 7 SPACES BASED ON LOW DEMAND ANTICIPATED FOR ASSISTED LIVING USE.
3. REQUEST TO ALLOW FOUR (4) TANDEM PARKING SPACES TO FULFILL THE DEVELOPMENT PARKING REQUIREMENT.
4. REQUEST TO INCREASE MAXIMUM IMPERVIOUS AREA FOR THE SITE FROM 80% TO 90% VIA INCENTIVE BONUSES (SEE INCENTIVE MODIFICATION INFORMATION ON THIS SHEET).
5. REQUEST FOR INCLUSION OF MEZZANINE LEVEL FOR COMMERCIAL USE (NOT COUNTED AS ADDITIONAL STORY) VIA INCENTIVE BONUSES (SEE INCENTIVE MODIFICATION INFORMATION ON THIS SHEET).

ZONING TABULATION

PROPOSED ZONE: MAPLE AVENUE COMMERCIAL (MAC)

AREA TABULATIONS	SQ. FT.	ACRES
TOTAL SITE AREA	32130	0.7376
PROPOSED ROW DEDICATION	916	0.0210
TOTAL POST-DEDICATION SITE AREA	31214	0.7166

ZONING TABULATIONS	MAC ZONING REQUIREMENTS	PROVIDED
LOT WIDTH	NONE	198.92 FT
BUILDING WIDTH	NONE	175.5 FT (MAPLE AVE)
BUILDING HEIGHT	4 STORIES, 54 FT	4 STORIES, 54 FT
AVERAGE FRONT GRADE*	NONE	354.53'
YARD REQUIREMENTS		
FRONT - MAPLE AVENUE	20 FT	20.0 FT
FRONT - CENTER STREET	15 FT	16.1 FT
SIDE (EAST PROPERTY LINE)	8 FT	10.5 FT
REAR (NORTH PROPERTY LINE)	10 FT	10.7 FT
LOADING SPACE DEPTH	25 FT	25 FT
LOADING SPACE WIDTH	15 FT/50 FT BLDG WIDTH**	15 FT
LOADING SPACE HEIGHT	15 FT	15 FT
IMPERVIOUS AREA (MAXIMUM)	80% + 10% INCENTIVE BONUS = 90%	87.7%***
OPEN SPACE	15% OF LOT AREA (4,820 SF)	7,050 SF (21.9%)

\*\*MODIFICATION REQUESTED FOR LOADING WIDTH REDUCTION TO 15 FT

\*\*\*A PORTION OF PERVIOUS ARE A ACHIEVED THROUGH USE OF PERMEABLE PAVEMENT

*INCENTIVES BONUS MODIFICATIONS REQUESTED		
10% INCREASE TO MAXIMUM IMPERVIOUS AREA	AA, BBB	
INCLUSION OF MEZZANINE LEVEL FOR COMMERCIAL USE (NOT COUNTED AS ADDITIONAL STORY)	A, B	

INCENTIVE BONUSES PROPOSED	BONUS
Underground parking to accommodate 51% or more of spaces	AA
50% of building roof is green roof system	AA
Inclusion of shower and dressing facilities for employees	B
Construction of Principle Structure to earn the Design for Energy Star certification	BB
Recycling station design to accommodate full building	B

PARKING TABULATIONS

PARKING TABULATION		
PARKING REQUIRED		
ASSISTED LIVING *	0.4 SP/UNIT X 85 UNITS =	34
RETAIL	1.0 SP/200 SF X 7700 SF =	39
TOTAL		73
GARAGE PARKING PROVIDED		56
SURFACE PARKING PROVIDED		4
TOTAL PARKING PROVIDED		60
PARKING PROVIDED W/ 1.25 MULTIPLIER		74
(BONUS FOR PARKING IN STRUCTURE ONLY)		

PARKING PROVIDED INCLUDES FOUR (4) TANDEM SPACES. A MODIFICATION IS REQUESTED TO ALLOW THE PROPOSED TANDEM SPACES TO FULFILL THE PARKING REQUIREMENT FOR THE DEVELOPMENT.

DEVELOPMENT TABULATIONS

PROPOSED ZONE: MAPLE AVENUE COMMERCIAL (MAC)

DEVELOPMENT TABULATIONS	
UNITS	85
GROSS FLOOR AREA (ABOVE GRADE) (SF)	99553
GROSS FLOOR AREA (BELOW GRADE) (SF)	22835
RETAIL FLOOR AREA (SF)	7700
GREEN ROOF PROVIDED (SF)	6000

Parking Quantity				
	Full Size	Compact	Tandem	Total
Garage	38	3	4	45
Ground Floor	14	1		15
Total				60

BIKE PARKING TABULATIONS

BIKE PARKING REQUIRED (18-95.10.F):

RETAIL =	1 SP/5,000 SF X 7,700 SF =	2 SPACES
	1 SP/25,000 SF (EMPLOYEES) X 7,700 SF =	1 SPACE
ASSISTED LIVING =	1 SP/5,000 SF X 99,553 =	20 SPACES*
	1 SP/25,000 SF (EMPLOYEES) X 99,553 SF =	4 SPACES

TOTAL PARKING REQUIRED =	27 SPACES
TOTAL PARKING REQUIRED WITH MODIFICATION* =	7 SPACES

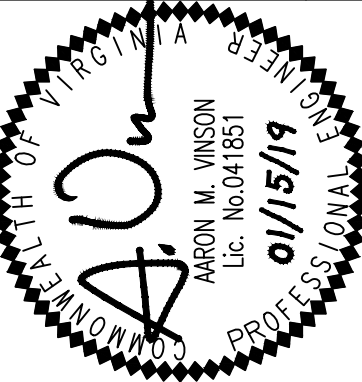
BIKE PARKING PROVIDED:

SURFACE/STREETSCAPE (RETAIL) =	4 SPACES
GARAGE (ASSISTED LIVING) =	4 SPACES
TOTAL BIKE PARKING PROVIDED =	8 SPACES

\*A MODIFICATION IS REQUESTED TO REDUCE THE ASSISTED LIVING BIKE PARKING REQUIREMENT TO 4 SPACES FOR EMPLOYEE USE ONLY. IT IS NOT ANTICIPATED THAT THE ASSISTED LIVING USE WILL ATTRACT BIKE USERS BEYOND THOSE FOR EMPLOYEE BIKE PARKING.

NOTES AND TABULATIONS

SUNRISE OF VIENNA  
MAC REZONING PLAN  
100, 102 & 112 MAPLE AVENUE EAST  
TOWN OF VIENNA, VIRGINIA 22180



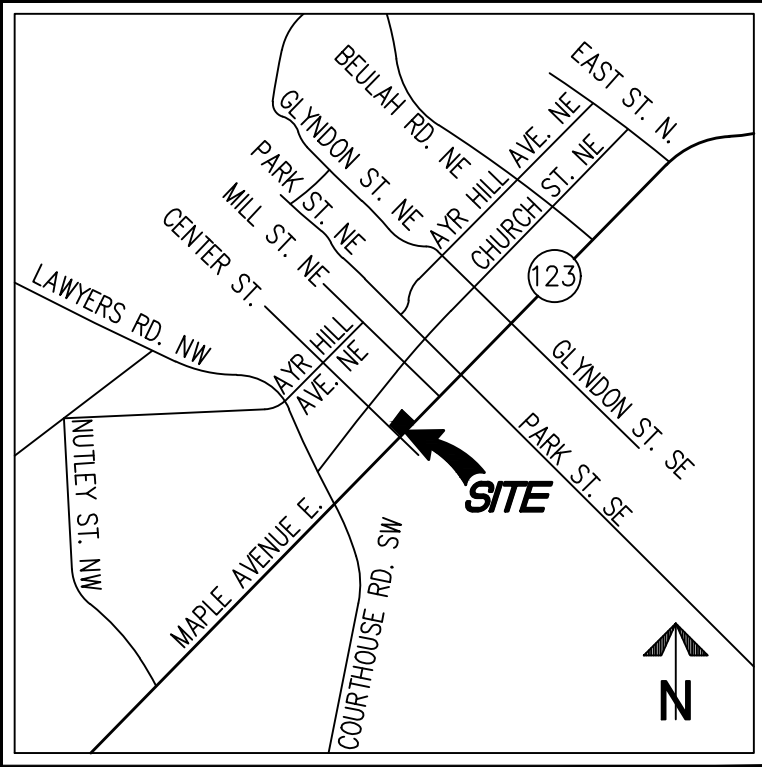
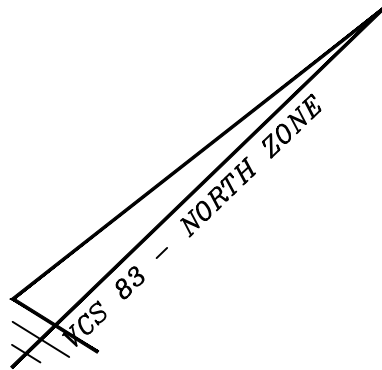
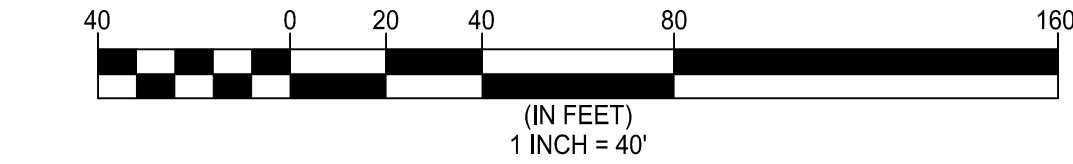
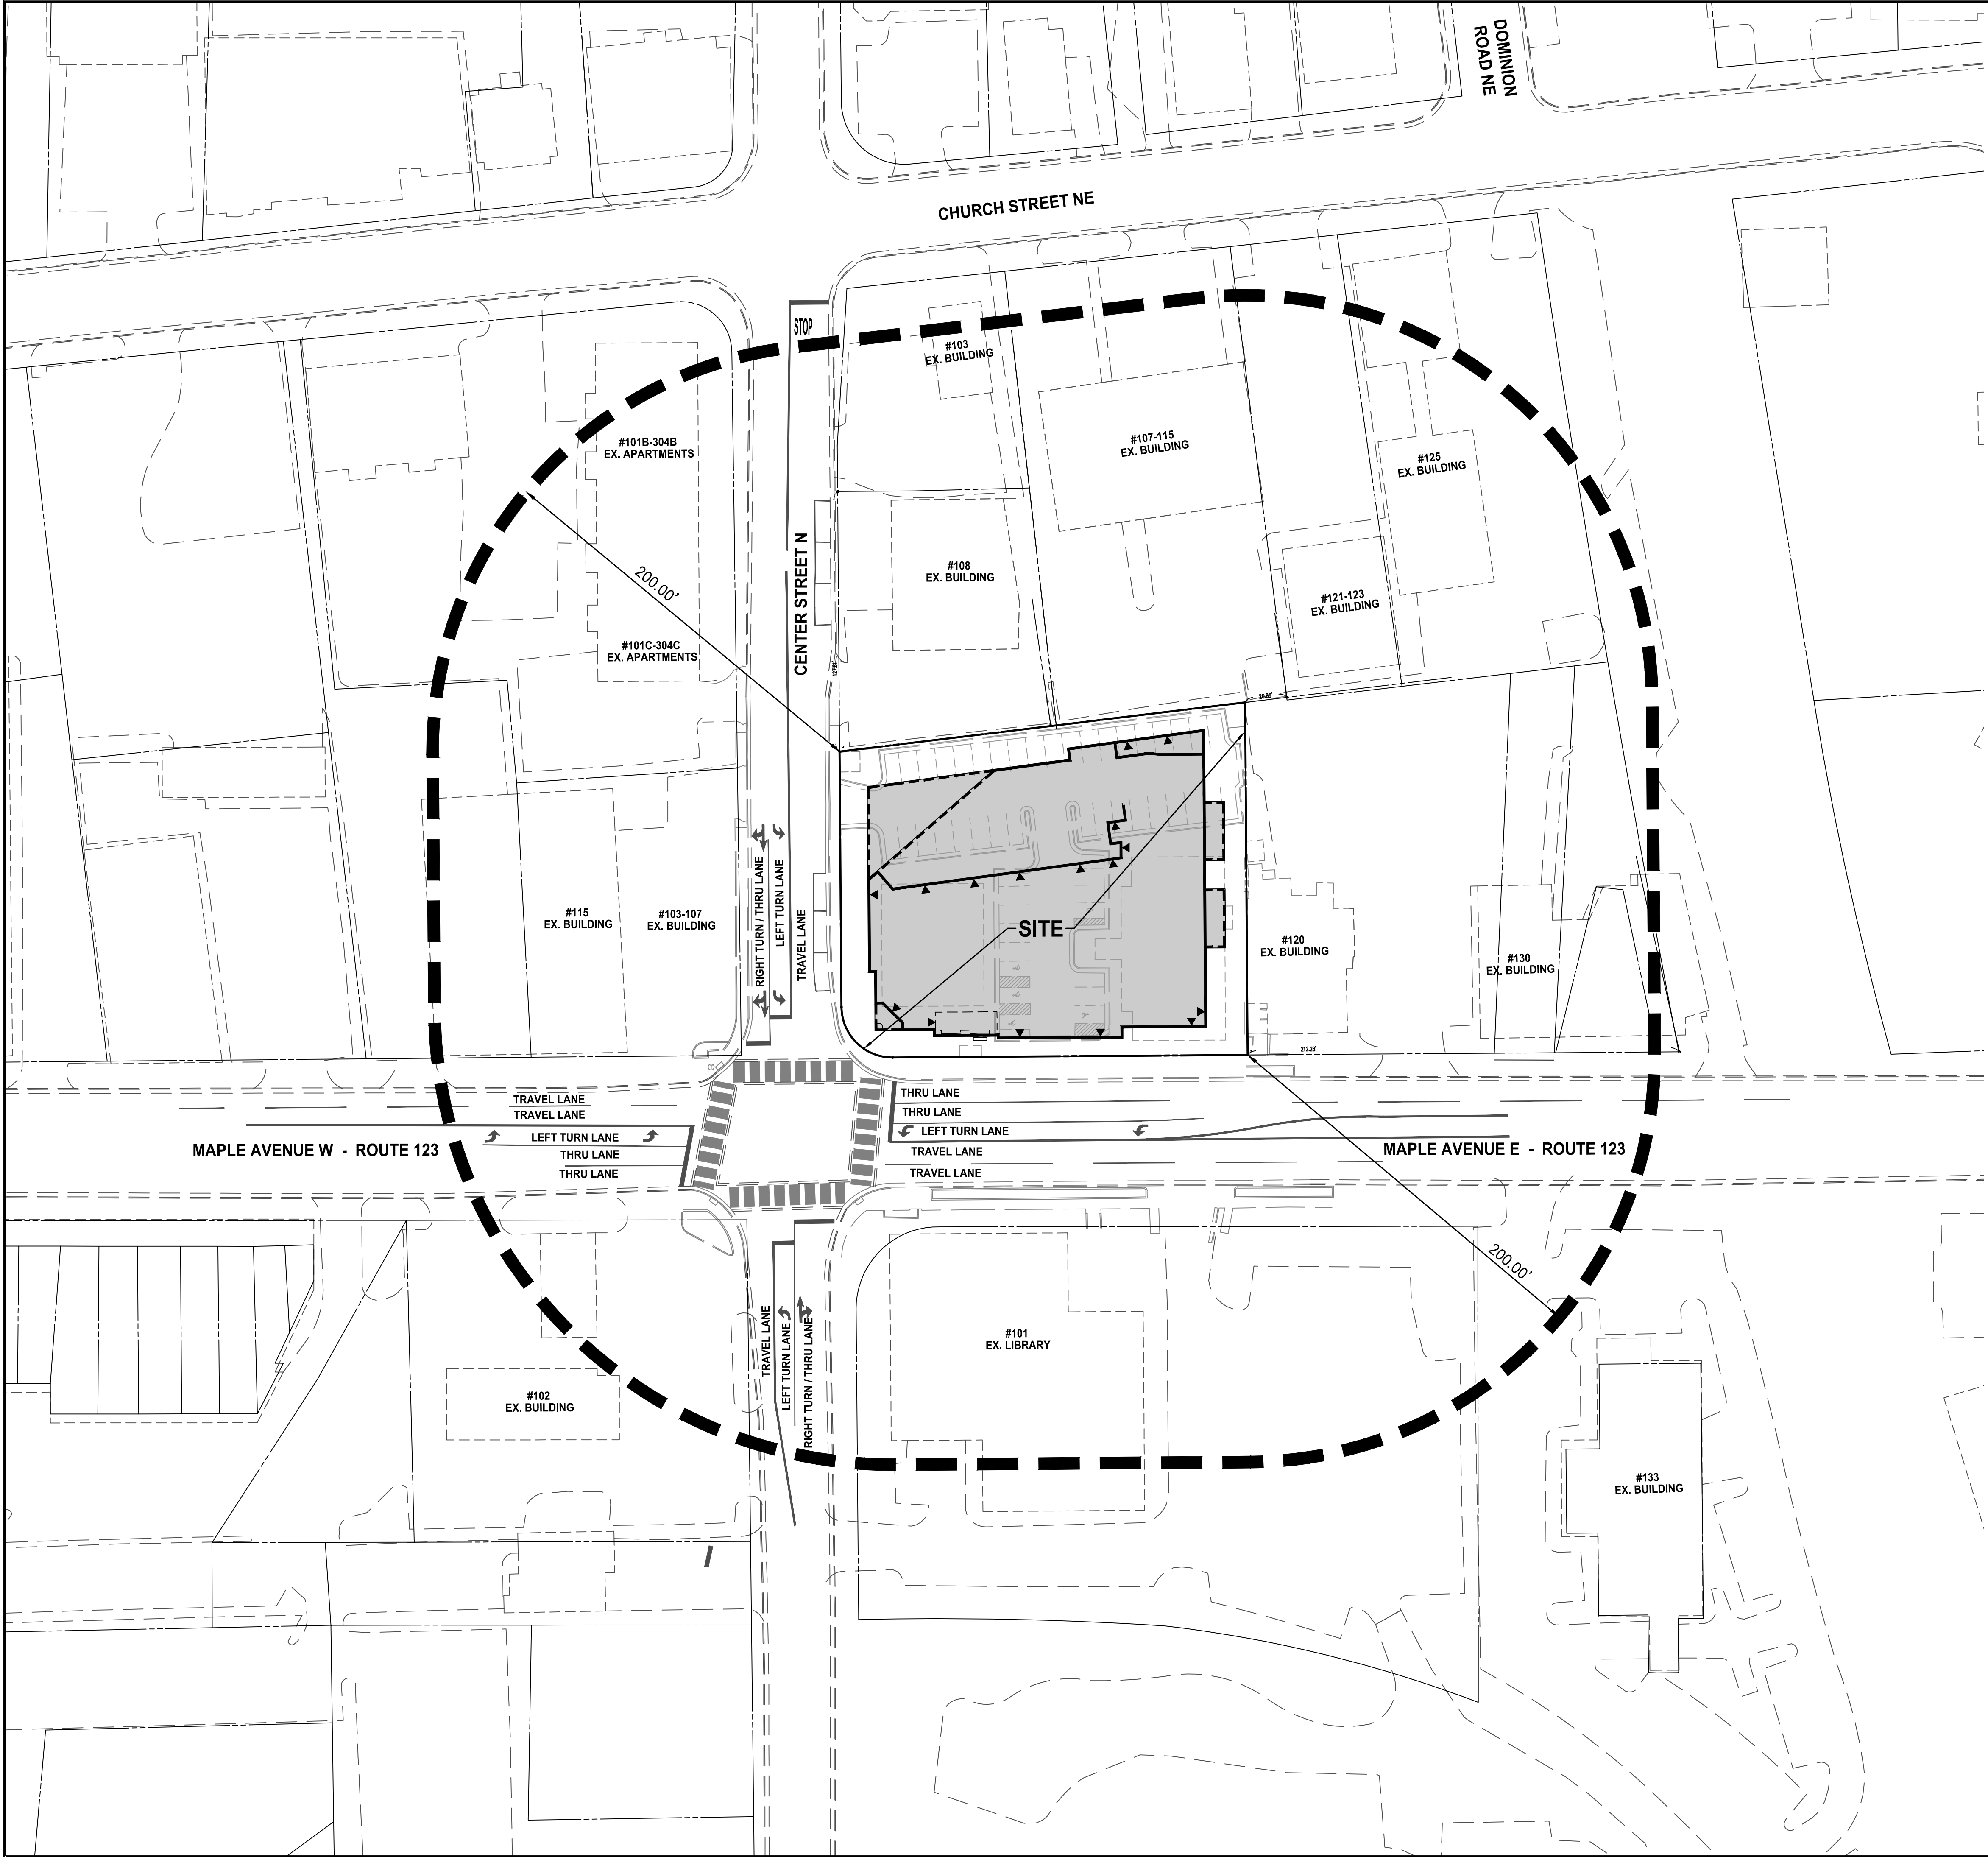
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INCORPORATED  
ESTABLISHED 1945

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DRAWN: TPB  
DATE: 09/05/2018, 01/15/2019  
SCALE: N.T.S.



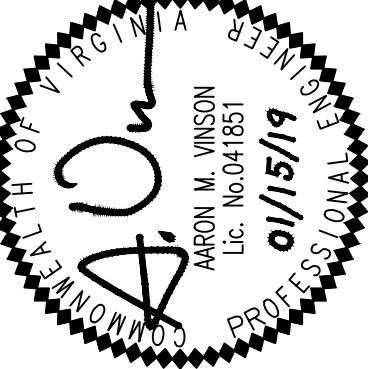


VICINITY MAP SCALE: 1"=2000'

NOTE: SEE EXISTING CONDITIONS PLAN FOR ADJACENT OWNERSHIP INFORMATION.

CONTEXT PLAN

**SUNRISE OF VIENNA**  
MAC REZONING PLAN  
100, 102 & 112 MAPLE AVENUE EAST  
TOWN OF VIENNA, VIRGINIA 22180

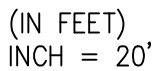


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AC.....	AIR CONDITIONER
BSS.....	BUS STOP SHELTER
CHX.....	CHISELED X SET (PROPERTY CORNER)
CO.....	CLEANOUT
CWS.....	CROSS WALK SIGNAL
DB.....	DEED BOOK
ESMT.....	EASEMENT
FF.....	FLOOR ELEVATION
GTR.....	GREASE TRAP
IPF.....	IRON PIN FOUND (PROPERTY CORNER)
IPS.....	IRON PIN SET (PROPERTY CORNER)
LSW.....	LANDSCAPING WALL
N/F.....	NOW OR FORMERLY
PG.....	PAGE
PL.....	PLANTER
POB.....	POINT OF BEGINNING
SD.....	STORM SEWER STRUCTURE
SMW.....	SANITARY SEWER STRUCTURE
SQ.FT.....	SQUARE FEET
TP.....	TELECOMMUNICATIONS PEDESTAL
TRL.P.....	TRAFFIC LIGHT/SIGNAL POLE
TSC.....	TRAFFIC SIGNAL CONTROL
TSP.....	TEST PIT
TVLT.....	TRAFFIC CONTROL VAULT
WDF.....	WOODEN FENCE
WM.....	WATER METER
WV.....	WATER VALVE
▷.....	DOORWAY
◀.....	GROUND LIGHT
◇.....	FIRE HYDRANT
∅.....	UTILITY POLE
☆.....	LIGHT POLE
— X —→.....	FENCE
— ⚡ —.....	GUY WIRE
— G —.....	OVERHEAD WIRES
— W —.....	UNDERGROUND GAS LINE
— E —.....	UNDERGROUND WATER LINE
— W —.....	UNDERGROUND ELECTRIC LINE
=====	CURB AND GUTTER
(E).....	ELECTRICAL MANHOLE
(W).....	WATER MANHOLE
(T).....	TELECOMMUNICATIONS MANHOLE
(E).....	ELECTRIC TRANSFORMER
—   —.....	SIGN
●.....	BOLLARD
00.....	SPOT ELEVATION
○.....	RESERVED FOR DISABLED
⌚.....	TREE
~~~~~	LIMITS OF TREE CANOPY



SD 1250	
CURB INLET TOP	351.86
15" RCP IN (N WEST)	349.41
42" RCP IN (SOUTH)	346.72
42" RCP OUT (SD 1177)	346.48
SD 1177	
CURB INLET/JUNCTION BOX	351.64
42" RCP IN (SD 1250)	346.29
TRIPLE 3'X5' BOX CULVERTS	346.98
WEST 66" CMP OUT (SD 915)	345.29
EAST 66" CMP OUT (SD 915)	345.62
SD 915	
JUNCTION BOX INLET	352.67
15" RCP IN EAST 66" RCP (SD 937)	347.42
WEST 66" CMP IN (SD 1177)	345.03
EAST 66" CMP IN (SD 1177)	345.03
WEST 66" CMP OUT (NORTH)	345.03
EAST 66" CMP OUT (NORTH)	345.03
SD 933	
GRATE INLET TOP	351.80
15" RCP OUT (SD 937)	348.85
SD 937	
MANHOLE TOP	352.29
15" RCP IN (SD 933)	348.46
15" RCP OUT (EAST 66" RCP)	347.94

STORM LINE BETWEEN SD 790 AND SD 937  
IS PER RECORD INFORMATION ONLY

SMH 324	
TOP	353.14
10° INV IN (S.EAST)	346.30
10° INV IN (S.WEST)	346.30
10° INV OUT (SMH 323)	346.25
SMH 323	
TOP	353.38
INV IN (S.EAST)	345.96
10° INV IN (SMH 324)	345.88
10° INV OUT (SMH 322)	345.69
SMH 322	
TOP	352.10
INV IN (N.WEST)	345.25
10° INV IN (SMH 323)	344.60
10° INV OUT (SMH 321)	344.51
SMH 321	
TOP	354.86
10° INV IN (SMH 322)	343.74
10° INV OUT (N.WEST)	343.71

PIPE SIZES ARE FROM RECORD INFORMATION

- ## **EXISTING CONDITIONS PLAN**

# MAC REZONING PLAN

**1100, 102 & 112 MAPLE AVENUE EAST  
TOWN OF VIENNA, VIRGINIA 22180**

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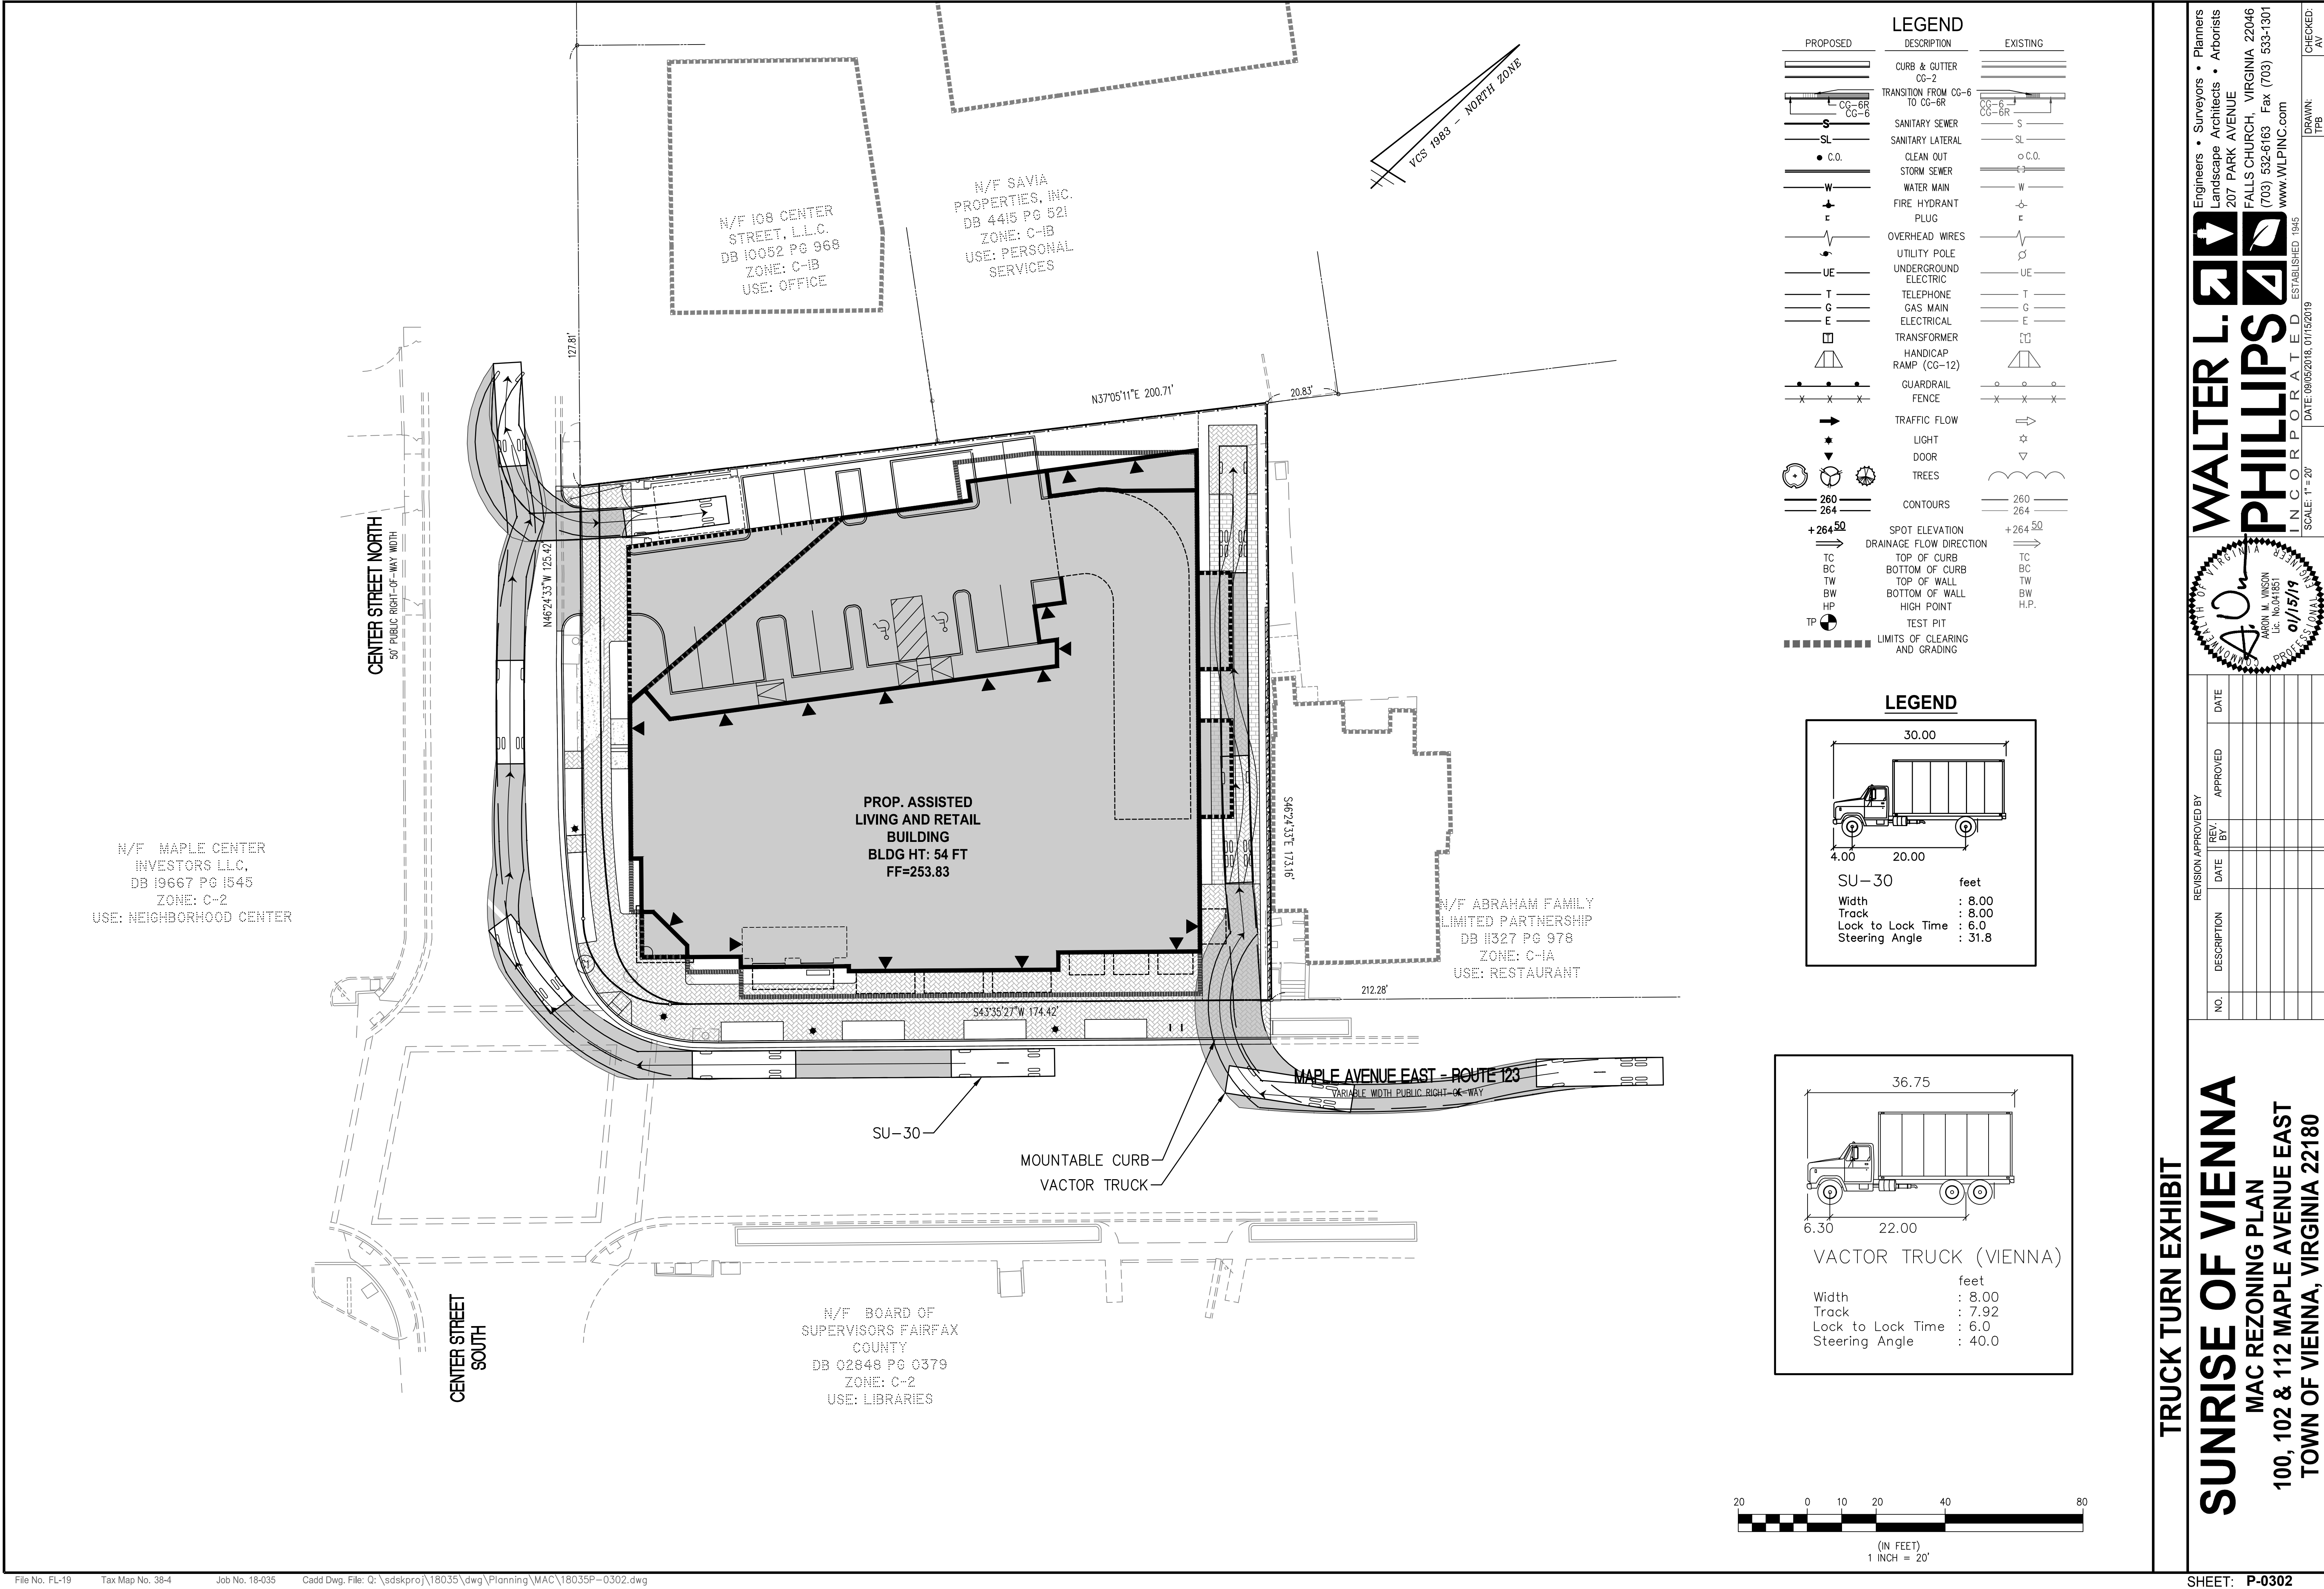




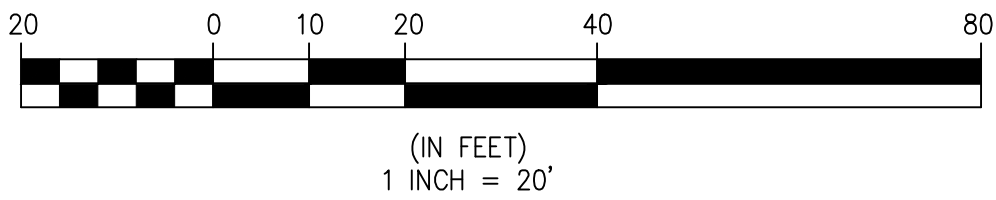
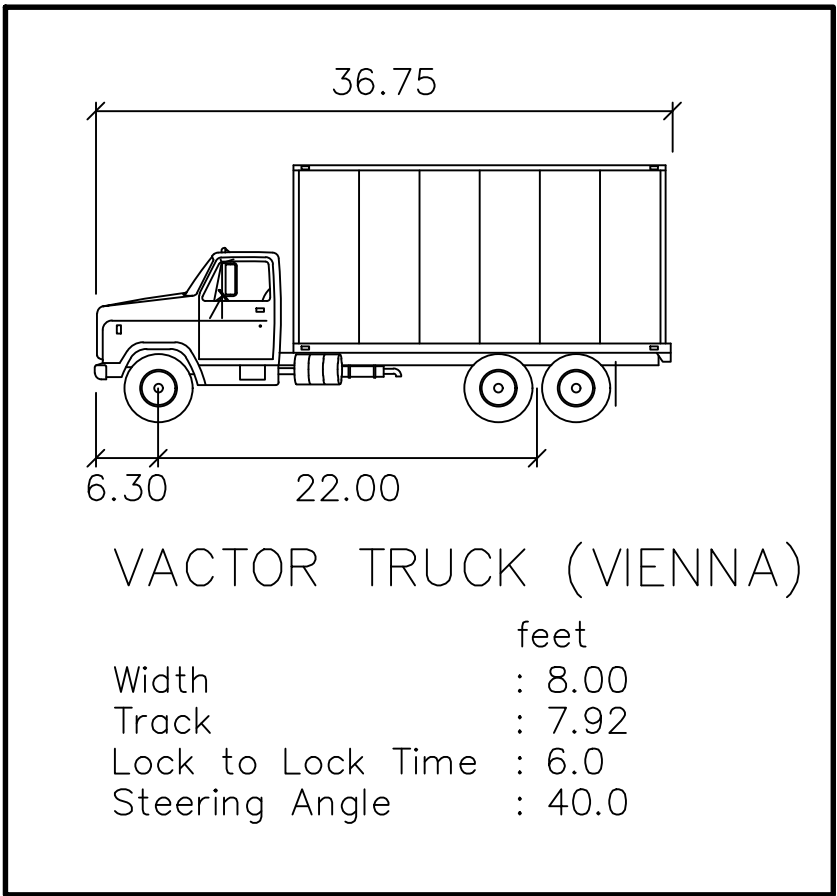
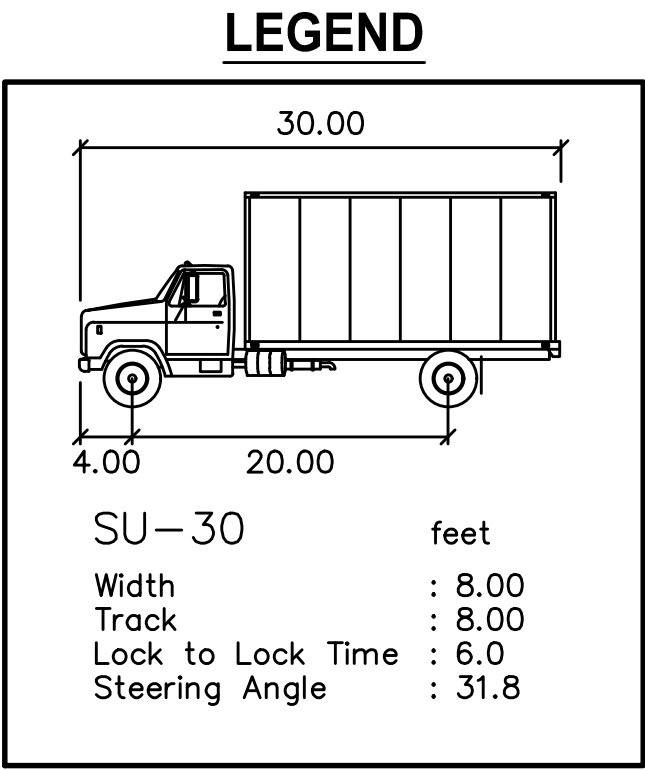








PROPOSED	DESCRIPTION	EXISTING
	CURB & GUTTER CG-2	
	TRANSITION FROM CG-6 TO CG-6R	
	SANITARY SEWER	
	SANITARY LATERAL	
	CLEAN OUT	
	STORM SEWER	
	WATER MAIN	
	FIRE HYDRANT	
	PLUG	
	OVERHEAD WIRES	
	UTILITY POLE	
	UNDERGROUND ELECTRIC	
	TELEPHONE	
	GAS MAIN	
	ELECTRICAL	
	TRANSFORMER	
	HANDICAP RAMP (CG-12)	
	GUARDRAIL	
	FENCE	
	TRAFFIC FLOW	
	LIGHT	
	DOOR	
	TREES	
	CONTOURS	
	SPOT ELEVATION	
	DRAINAGE FLOW DIRECTION	
	TOP OF CURB	
	BOTTOM OF CURB	
	TOP OF WALL	
	BOTTOM OF WALL	
	HIGH POINT	
	TEST PIT	
	LIMITS OF CLEARING AND GRADING	



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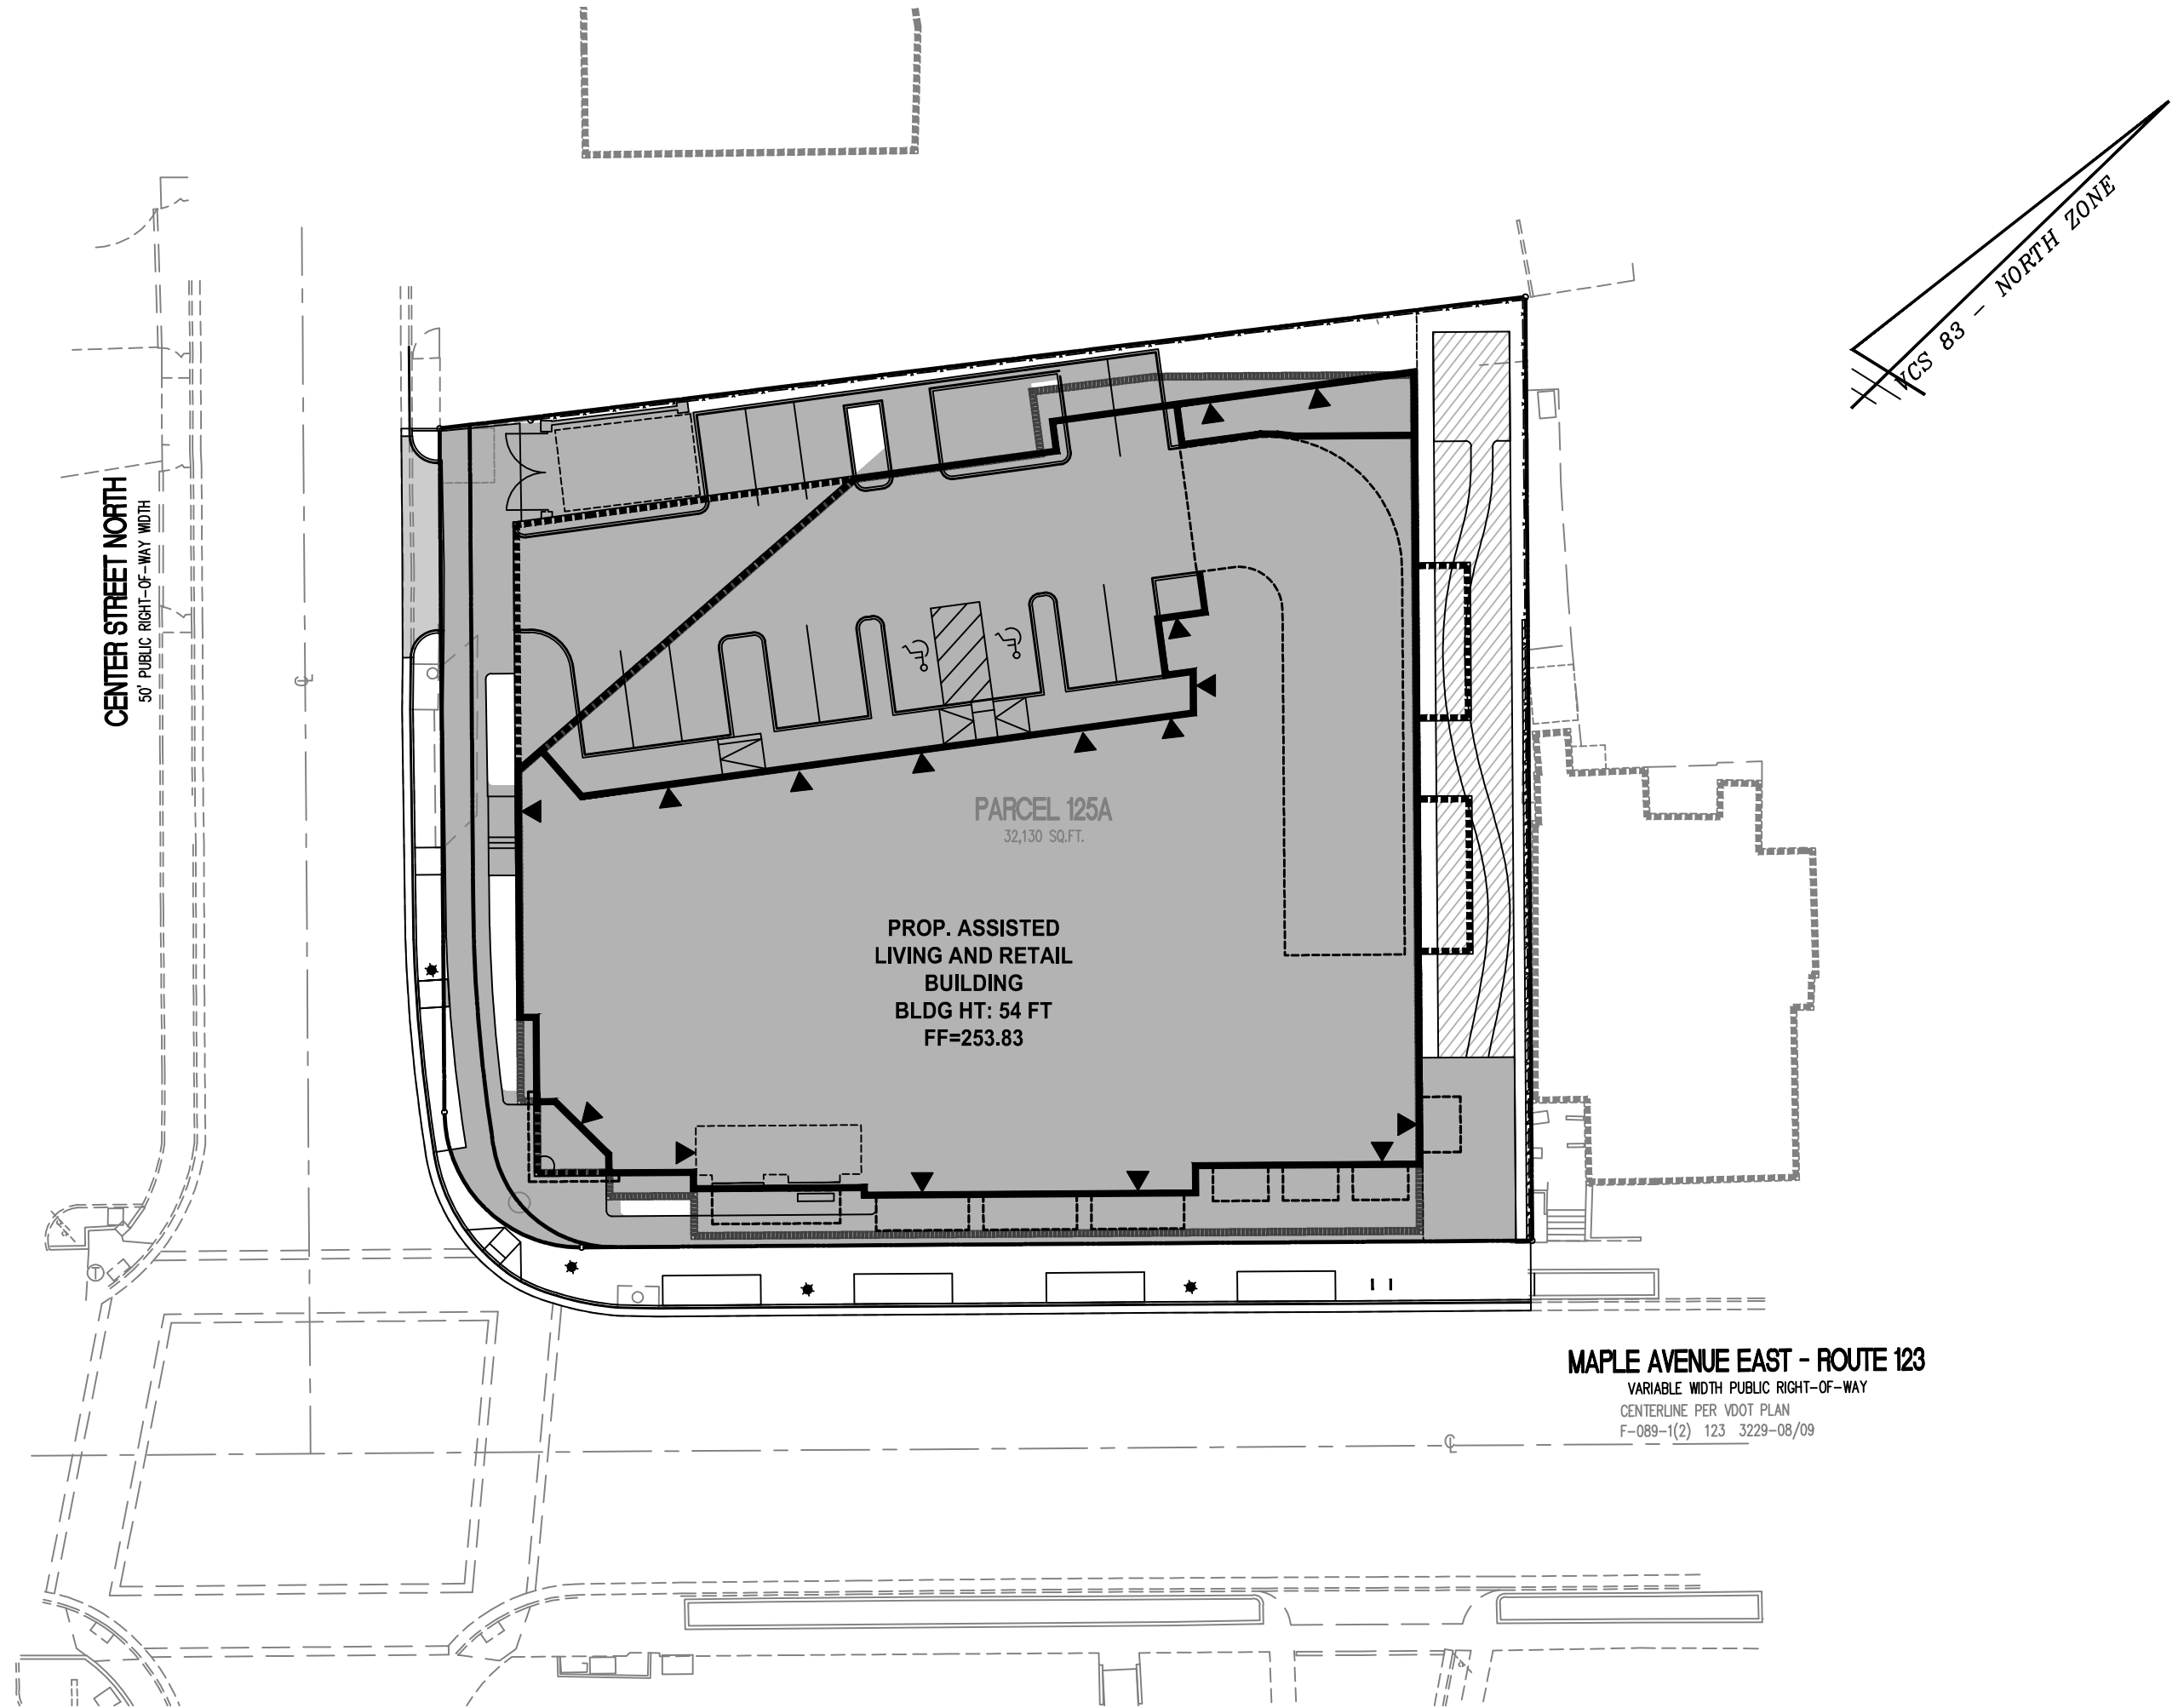
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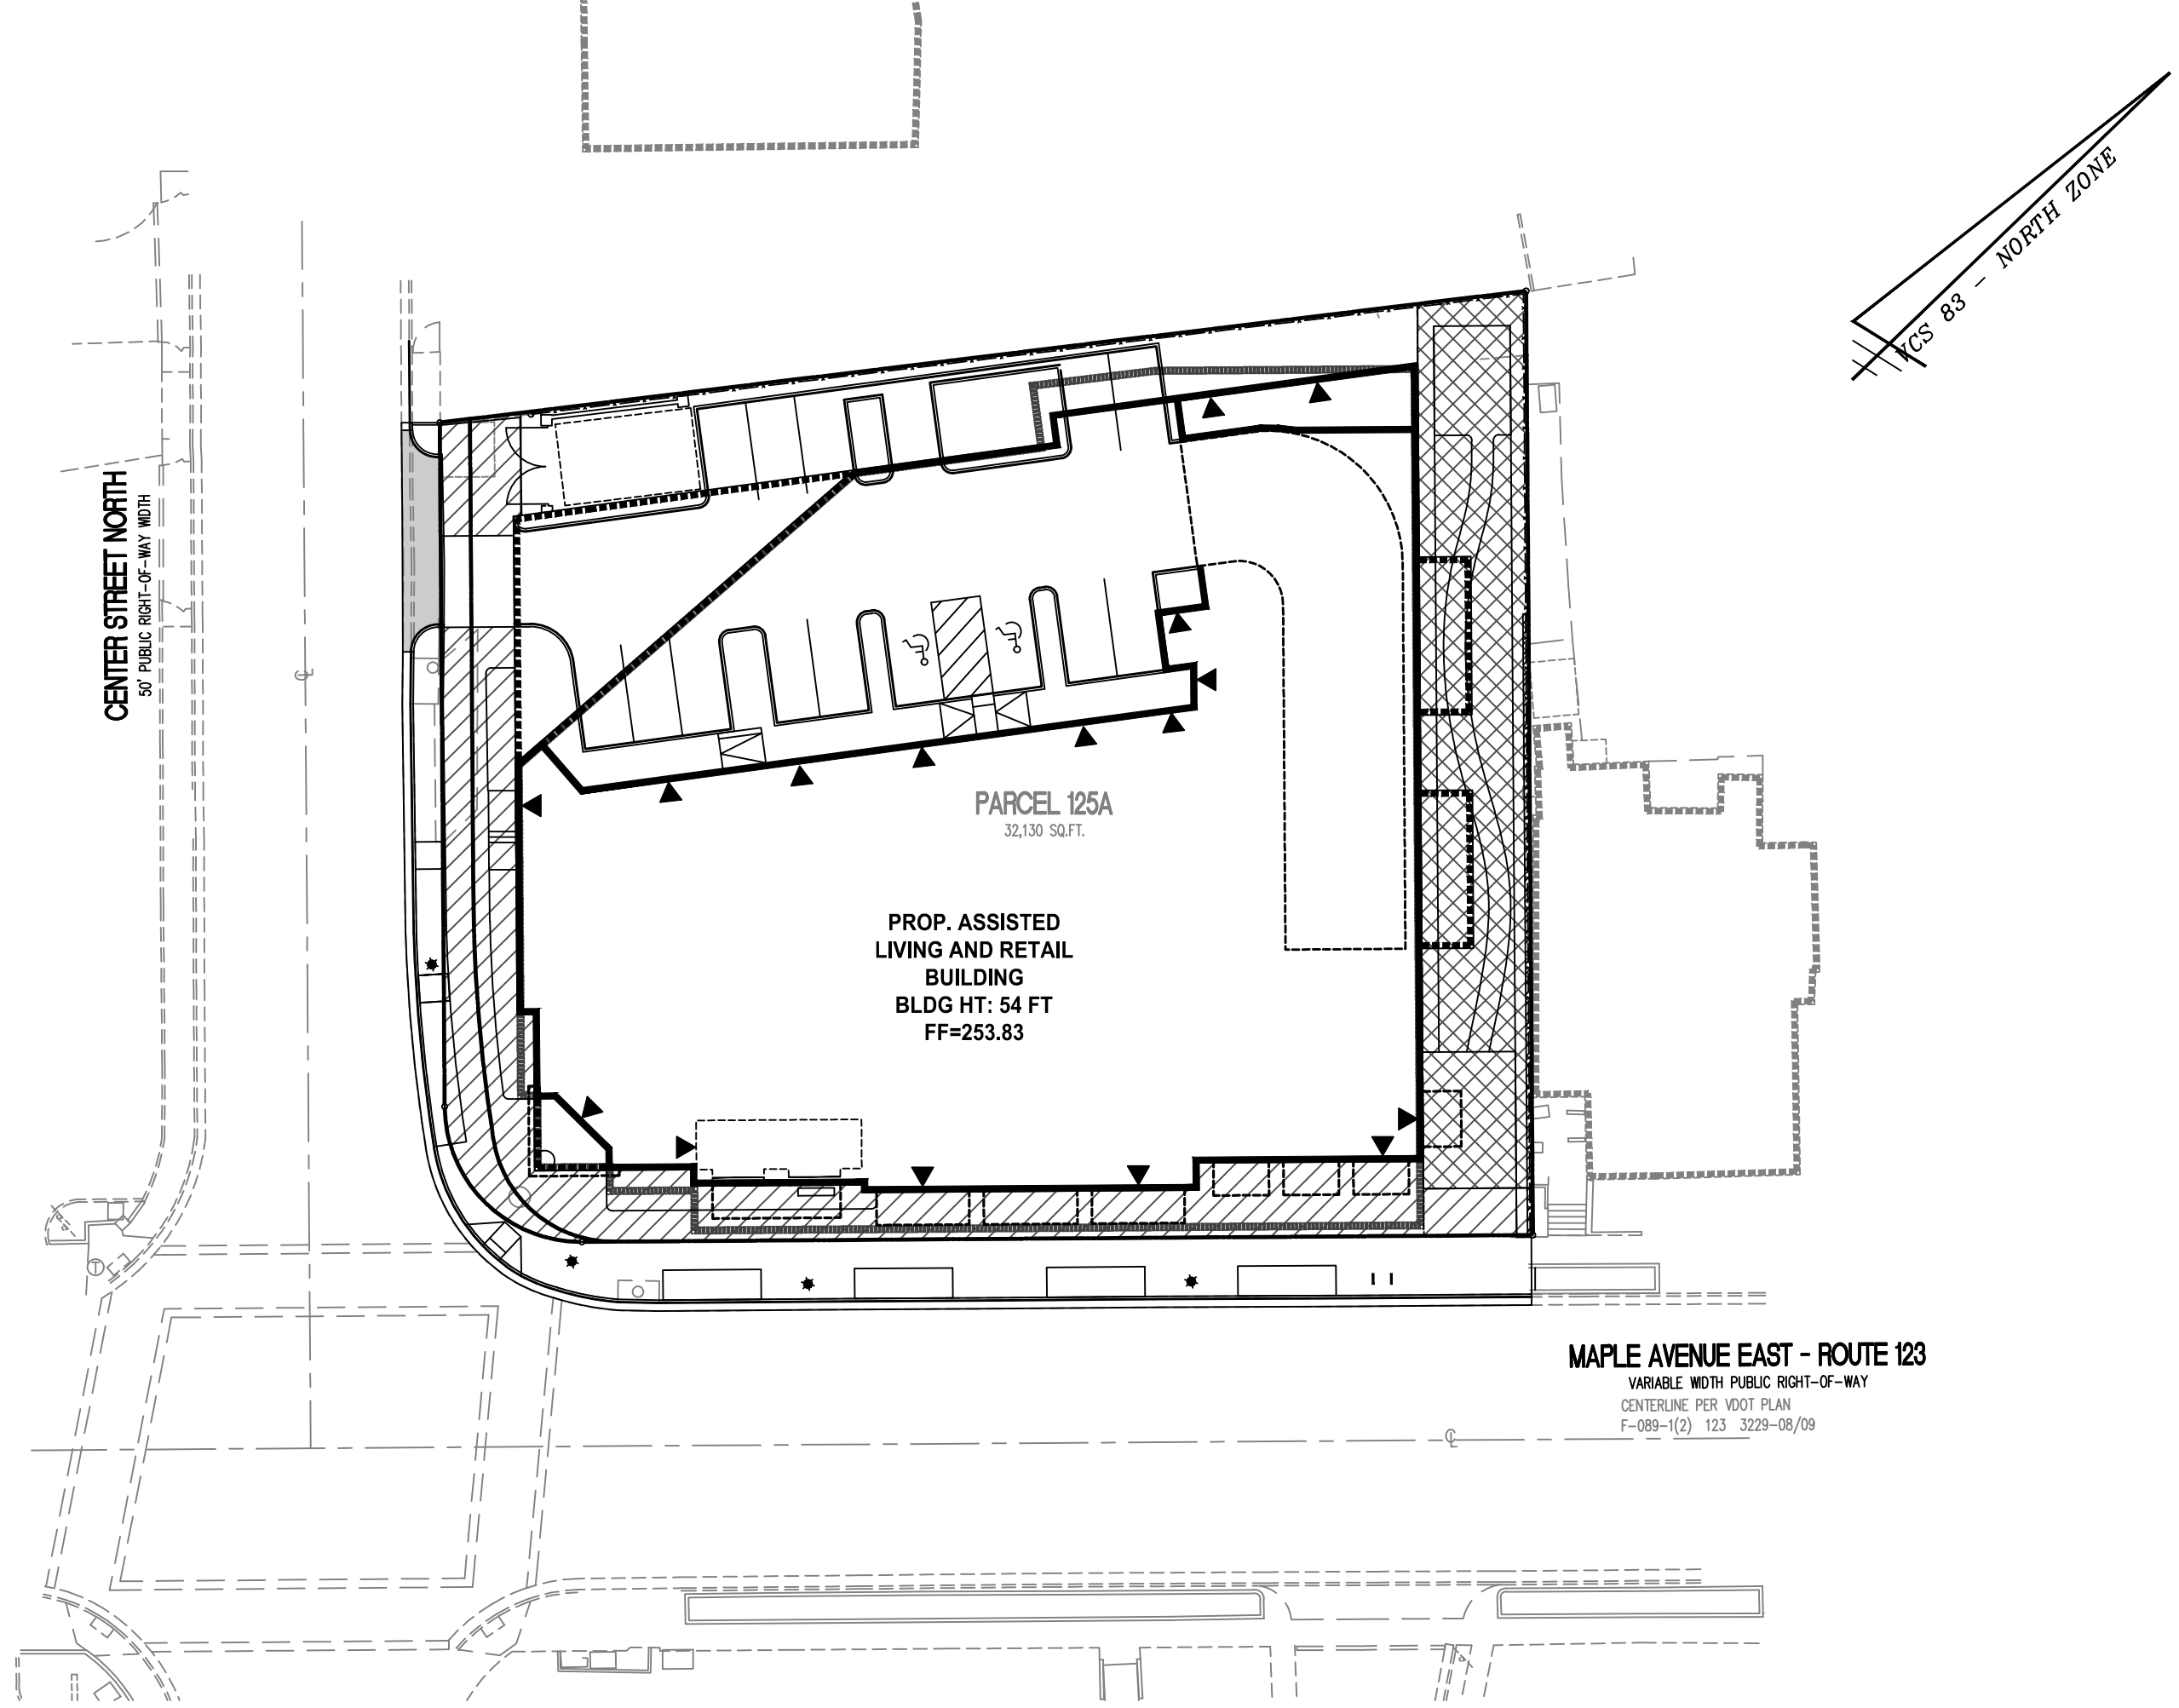
TRUCK TURN EXHIBIT

**SUNRISE OF VIENNA**  
MAC REZONING PLAN  
100, 102 & 112 MAPLE AVENUE EAST  
TOWN OF VIENNA, VIRGINIA 22180





IMPERVIOUS AREA DIAGRAM  
1" = 30'



OPEN SPACE DIAGRAM  
1" = 30'

IMPERVIOUS AREA COVERAGE

LOT AREA:		32,130 SF (0.7376 AC)
MAX IMPERVIOUS SURFACE	90% OF LOT AREA*	28,917 SF MAX.
LOT AREA - MAX IMPERVIOUS SURFACE = MIN PERVIOUS SURFACE		
MIN PERVIOUS SURFACE	10% OF LOT AREA*	3,213 SF MIN.

TOTAL IMPERVIOUS SURFACE	87.7% OF LOT AREA	±28,178 SF
TOTAL PERVIOUS SURFACE	12.3% OF LOT AREA	±3,952 SF

\*INCENTIVES USED TO INCREASE MAX IMPERVIOUS COVER FROM 80% TO 90%

A PORTION OF THE IMPERVIOUS AREA IS REDUCED THROUGH USE OF PERMEABLE PAVEMENT (THIS PERMEABLE PAVEMENT AREA IS NOT COUNTED TOWARD STORMWATER MANAGEMENT REQUIREMENTS SINCE IT IS LOCATED WITHIN A PUBLIC UTILITY EASEMENT)

FINAL CALCULATIONS WILL BE PROVIDED AT SITE PLAN.

EXISTING IMPERVIOUS AREA = 26,465 SF (82.4%)

LEGEND

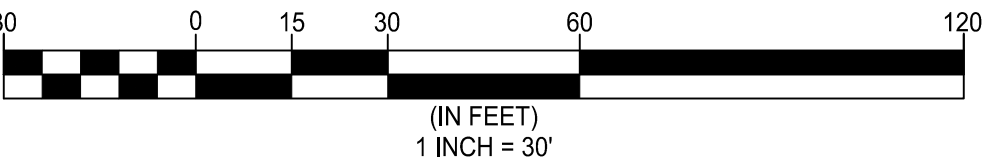
- IMPERVIOUS AREA
- PERMEABLE PAVEMENT (1,860 SQ. FT.)

OPEN SPACE CALCULATION

LOT AREA:		32,130 SF (0.7376 AC)
MIN OPEN SPACE REQUIRED	15% OF LOT AREA	4,820 SF MIN.
OPEN SPACE PROVIDED	±21.9% OF LOT AREA	±7,050 SF

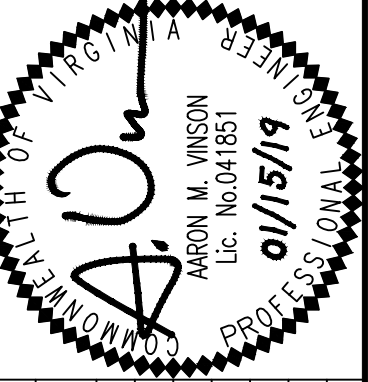
NOTE: THIS PLAN IS FOR THE APPROVAL OF 15% OPEN SPACE. FINAL CALCULATIONS WILL BE PROVIDED AT SITE PLAN.

- OPEN SPACE - STREETSCAPE (±3,785 SF)
- OPEN SPACE - SIDE AND REAR (±3,265 SF)



OPEN SPACE AND IMPERVIOUS SURFACE EXHIBIT

**SUNRISE OF VIENNA**  
MAC REZONING PLAN  
100, 102 & 112 MAPLE AVENUE EAST  
TOWN OF VIENNA, VIRGINIA 22180



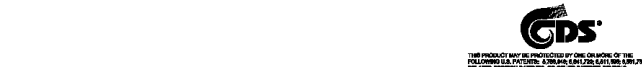
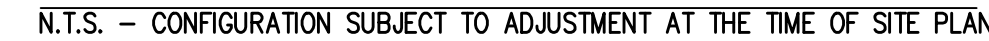
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ESTABLISHED 1945  
SCALE: 1" = 30'  
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N.T.S. - CONFIGURATION SUBJECT TO ADJUSTMENT AT THE TIME OF SITE PLAN



---

CURRENTLY, THE SITE CONSISTS OF TWO (2) COMMERCIAL BUILDINGS AND ACCESSORY EQUIPMENT. ADDITIONALLY, SURFACE PARKING, LANDSCAPE AREAS, AND UTILITY INFRASTRUCTURE EXIST ONSITE. THERE ARE NO EXISTING STORMWATER MANAGEMENT QUALITY OR QUANTITY CONTROL MEASURES ON SITE. THE SITE DRAINS FROM EAST TO WEST ACROSS THE SITE AS SHEET FLOW OR VIA STORM SEWERS. ALL STORMWATER ENTERS THE MUNICIPAL STORM SEWER SYSTEM VIA CURB INLETS ALONG THE ADJACENT PUBLIC STREETS. TWO (2) 66" STORM SEWERS CURRENTLY BYPASS THE SITE AND WILL REMAIN AS PART OF THIS PROJECT.

STORMWATER QUALITY:  
IN ORDER TO COMPLY WITH CHAPTER 23 OF THE TOWN OF VIENNA CODE OF ORDINANCES (STORMWATER ORDINANCE) FOR STORMWATER QUALITY, A LEVEL 1 GREEN ROOF FACILITY (±6,000 SQ. FT. OF GREEN ROOF) AND A HYDRODYNAMIC SEPARATOR TO BE LOCATED IN THE GARAGE ARE PROPOSED. TOGETHER, THESE STORMWATER BMPs WILL REDUCE PHOSPHORUS LEVELS IN ORDER TO COMPLY WITH APPLICABLE TOWN OF VIENNA AND STATE OF VIRGINIA REQUIREMENTS.

CHANNEL PROTECTION: THE SITE STORM OUTFALL AND ALL PIPES PROPOSED WITH THIS DEVELOPMENT WILL BE COMPRISED OF CONCRETE OR OTHER NON-ERODIBLE MATERIALS UP TO THE LIMITS OF ANALYSIS. THEREFORE, THE SITE CAN DISCHARGE THE 2-YEAR, 24-HOUR STORM WITHOUT CAUSING EROSION IN THE SYSTEM AND DETENTION IS NOT REQUIRED FOR THE PURPOSES OF CHANNEL PROTECTION.

FLOOD PROTECTION: THE SITE STORM OUTFALL AND ALL PIPES PROPOSED WITH THIS DEVELOPMENT WILL BE ADEQUATE TO RECEIVE THE 10-YEAR, 24-HOUR STORMWATER DISCHARGE FROM THE SITE AND UPSTREAM DRAINAGE AREA, UP TO THE LIMITS OF ANALYSIS. THEREFORE, DETENTION IS NOT REQUIRED FOR THE PURPOSES OF FLOOD CONTROL.

NOTE THAT IMPLEMENTATION OF RUNOFF REDUCTION PRACTICES (GREEN ROOF) ON THIS SITE WILL BRING THE POST-DEVELOPMENT FLOW RATE DOWN TO THE PRE-DEVELOPMENT PRE-DEVELOPMENT FLOW RATE.

FLOODPLAIN BOUNDARY:  
THIS SITE IS LOCATED OUTSIDE OF THE 100-YEAR FLOODPLAIN BOUNDARY.

THE SITE IS LOCATED IN THE DIFFICULT RUN WATERSHED.

THE STORMWATER MANAGEMENT PLAN PROVIDED ON THIS PLAN IS SUBJECT TO ADJUSTMENT AT THE TIME OF FINAL ENGINEERING.

N.T.S. - CONFIGURATION SUBJECT TO ADJUSTMENT AT THE TIME OF SITE PLAN



SURFACE AREA:	6,000 SF		
SOIL MEDIA DEPTH:	0.33 FT	SOIL MEDIA POROSITY:	0.25
GRAVEL MEDIA DEPTH:	0.17 FT	GRAVEL MEDIA POROSITY:	0.40
TOTAL STORAGE VOLUME:	$6,000 \times [(0.33 \times 0.25) + (0.17 \times 0.40)] = 903 \text{ CUBIC FEET}$		

**SUNRISE OF VIENNA**  
MAC REZONING PLAN  
100, 102 & 112 MAPLE AVENUE EAST  
TOWN OF VIENNA, VIRGINIA 22180

A circular professional engineer seal for the Commonwealth of Virginia. The outer ring contains the text "COMMONWEALTH OF VIRGINIA" at the top and "PROFESSIONAL ENGINEER" at the bottom. In the center, the name "AARON M. VINSON" is printed above "Lic. No. 041851". To the right, the expiration date "01/15/19" is stamped. A large, stylized "AE" is superimposed over the center of the seal.

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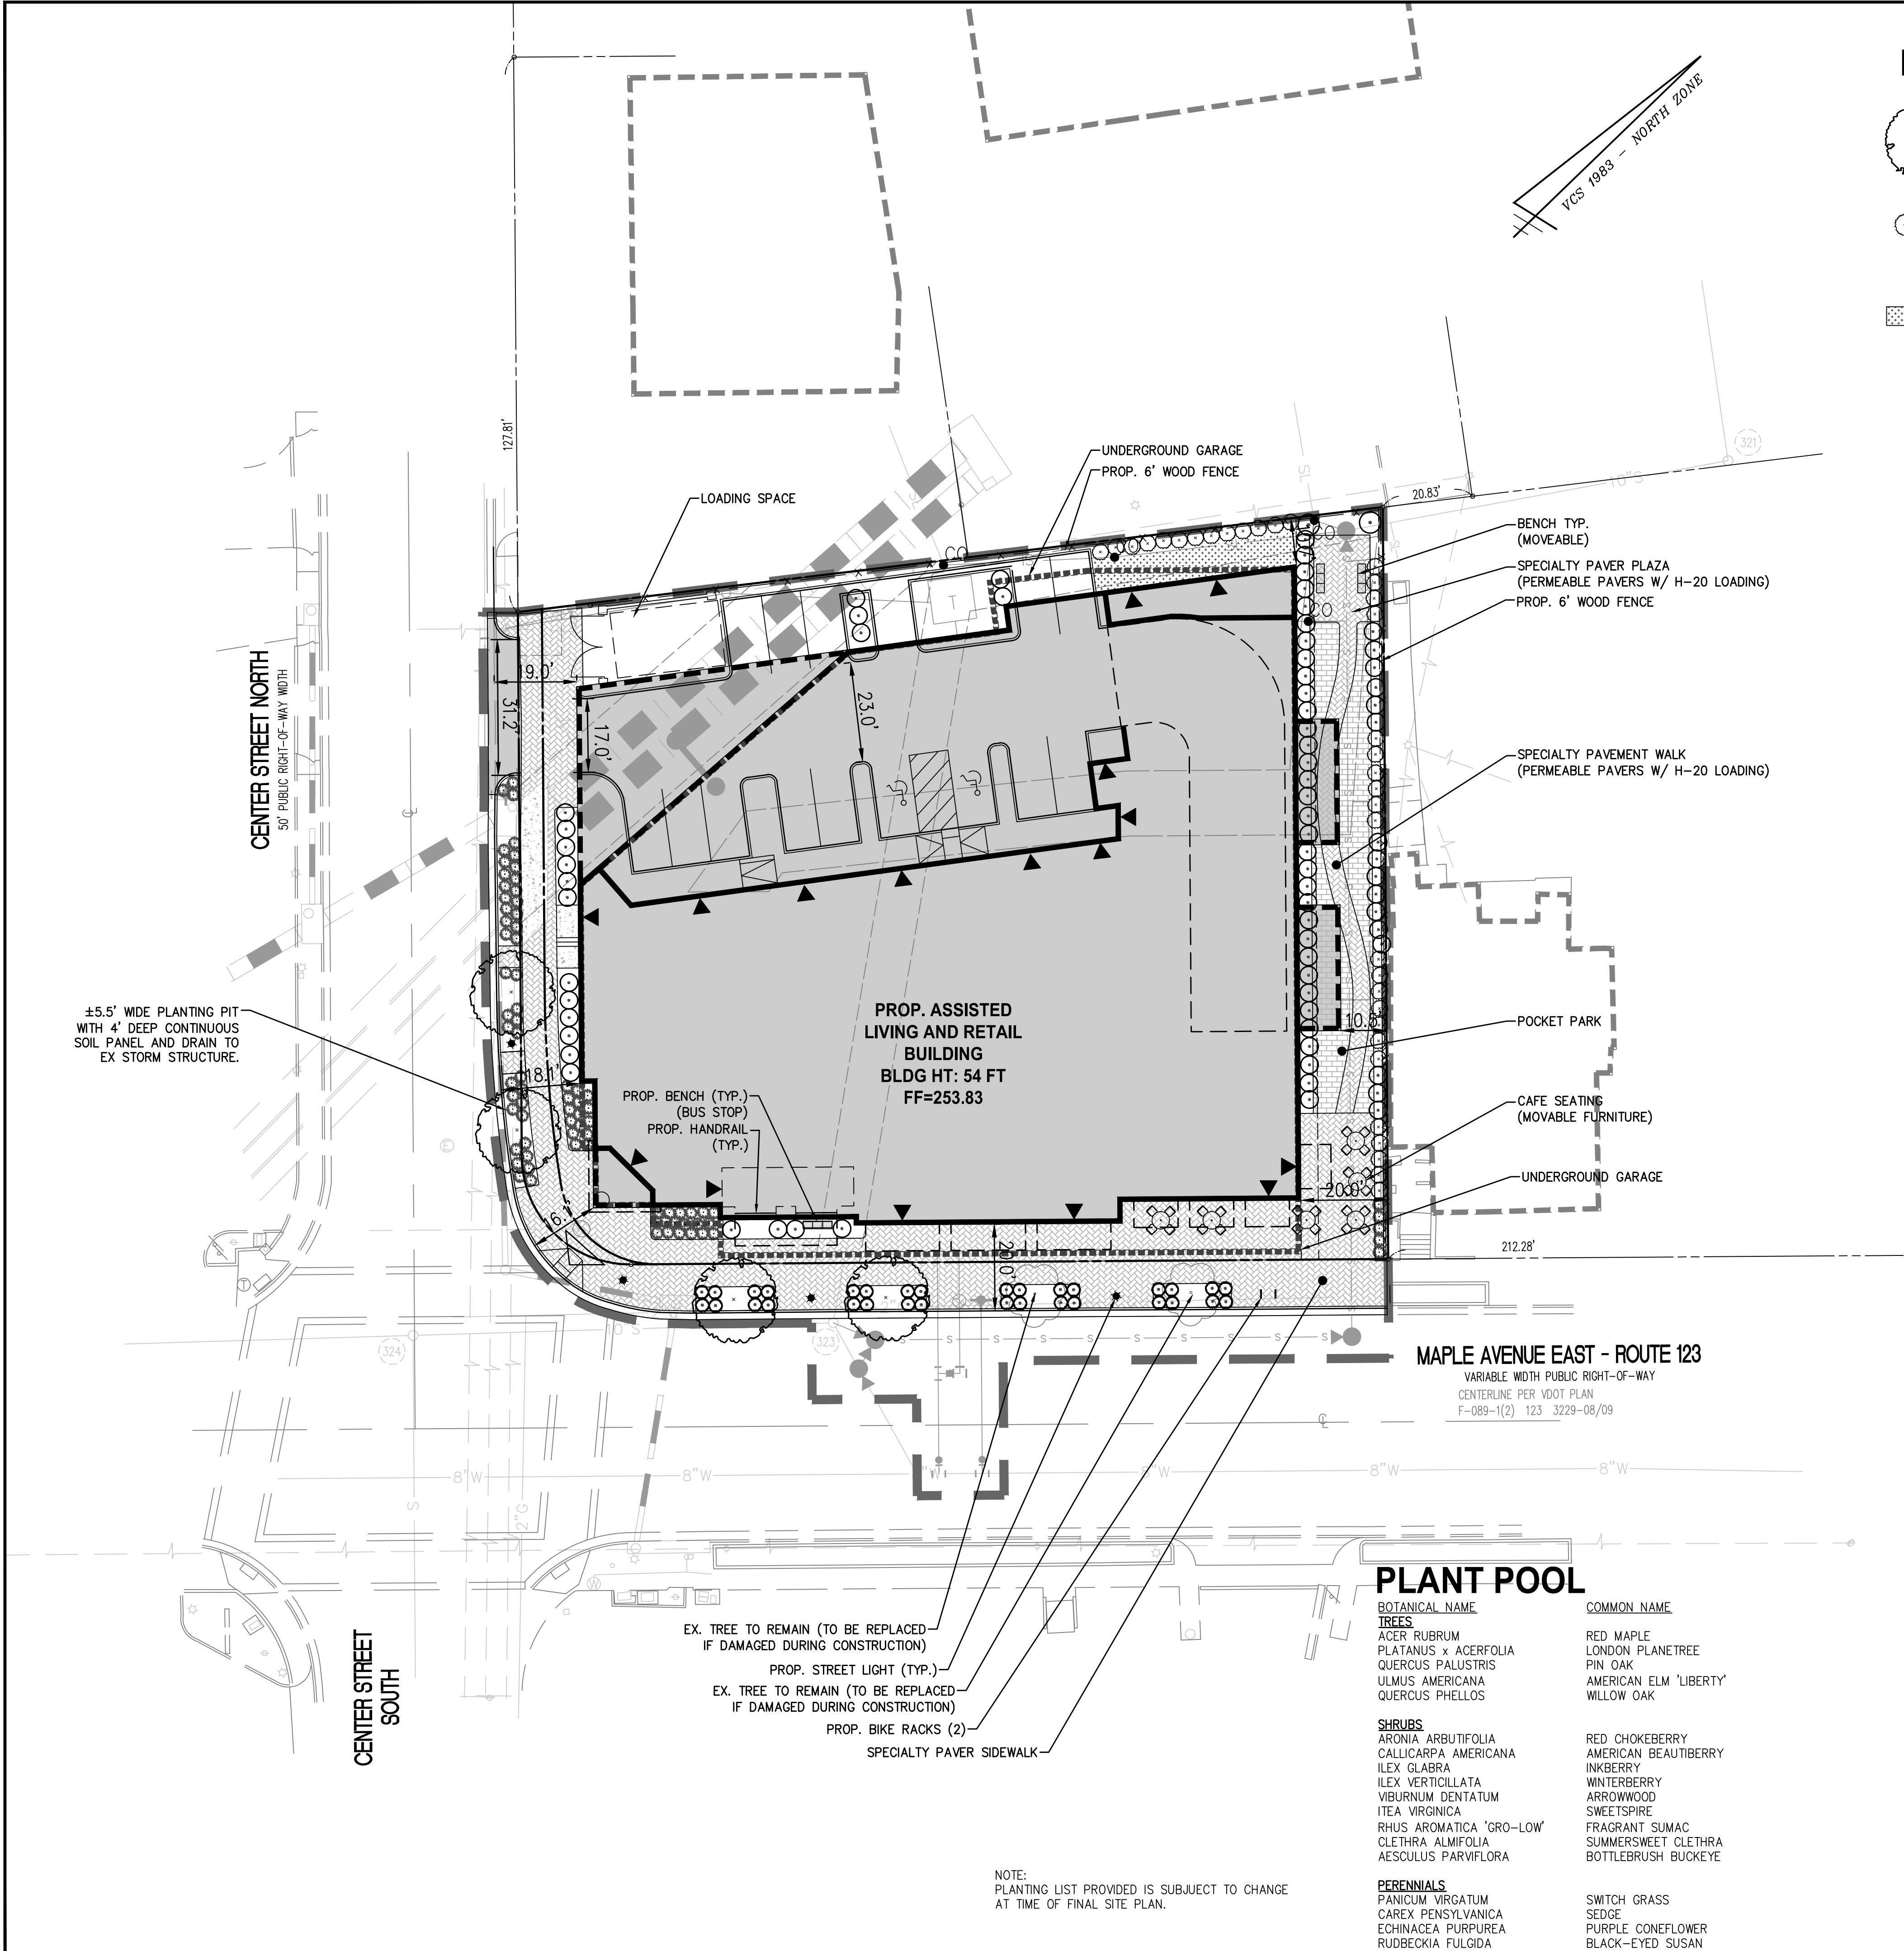
SCALE:	DATE: 09/05/2018, 01/15/2019	DRAWN: TPB AV	CHECKED:
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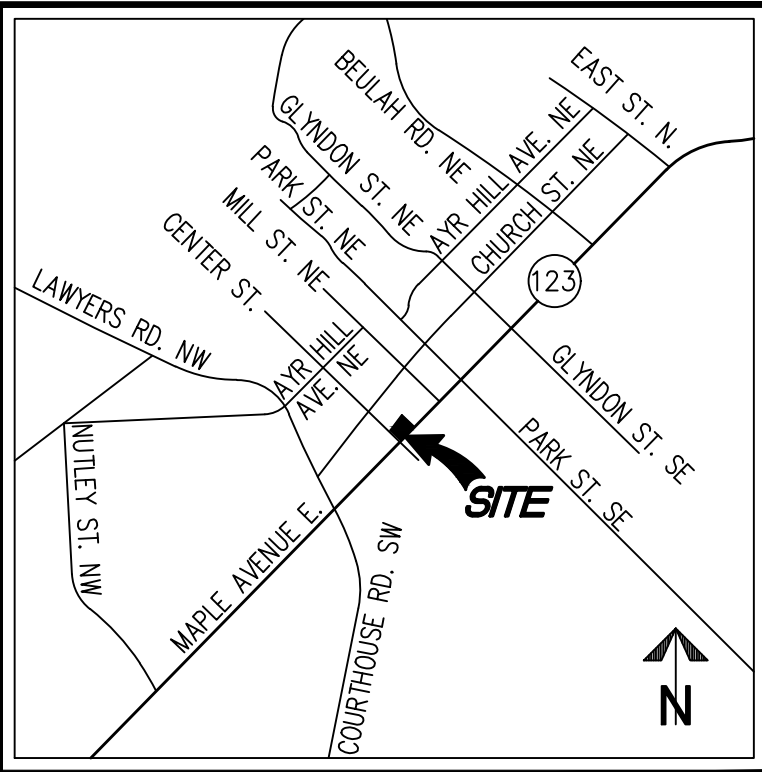






LEGEND

- PROPOSED DECIDUOUS TREES
- PROPOSED SHRUBS
- PROPOSED ORNAMENTAL GRASSES
- PROPOSED GROUNDCOVER, PERRENIALS



MATERIALS

SPECIALTY PAVEMENT



BENCHES



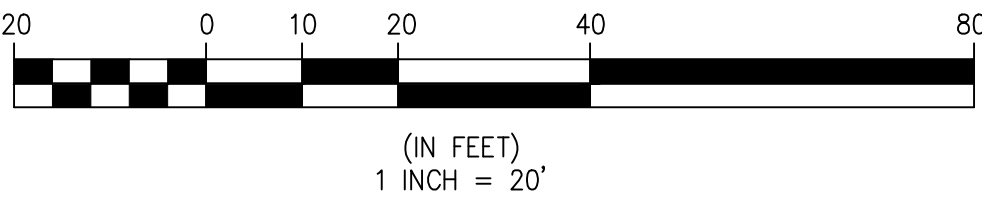
CAFE SEATING



6' FENCE

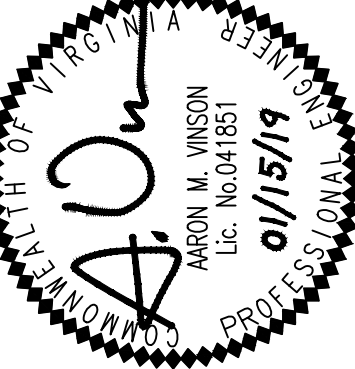


NOTE:  
SPECIFICATIONS PROVIDED ARE SUBJECT TO CHANGE AT TIME OF FINAL SITE PLAN. PRODUCTS ARE FOR REFERENCE ONLY.



LANDSCAPE PLAN

SUNRISE OF VIENNA  
MAC REZONING PLAN  
100, 102 & 112 MAPLE AVENUE EAST  
TOWN OF VIENNA, VIRGINIA 22180



NO.	DESCRIPTION	DATE	REV.	APPROVED	DATE

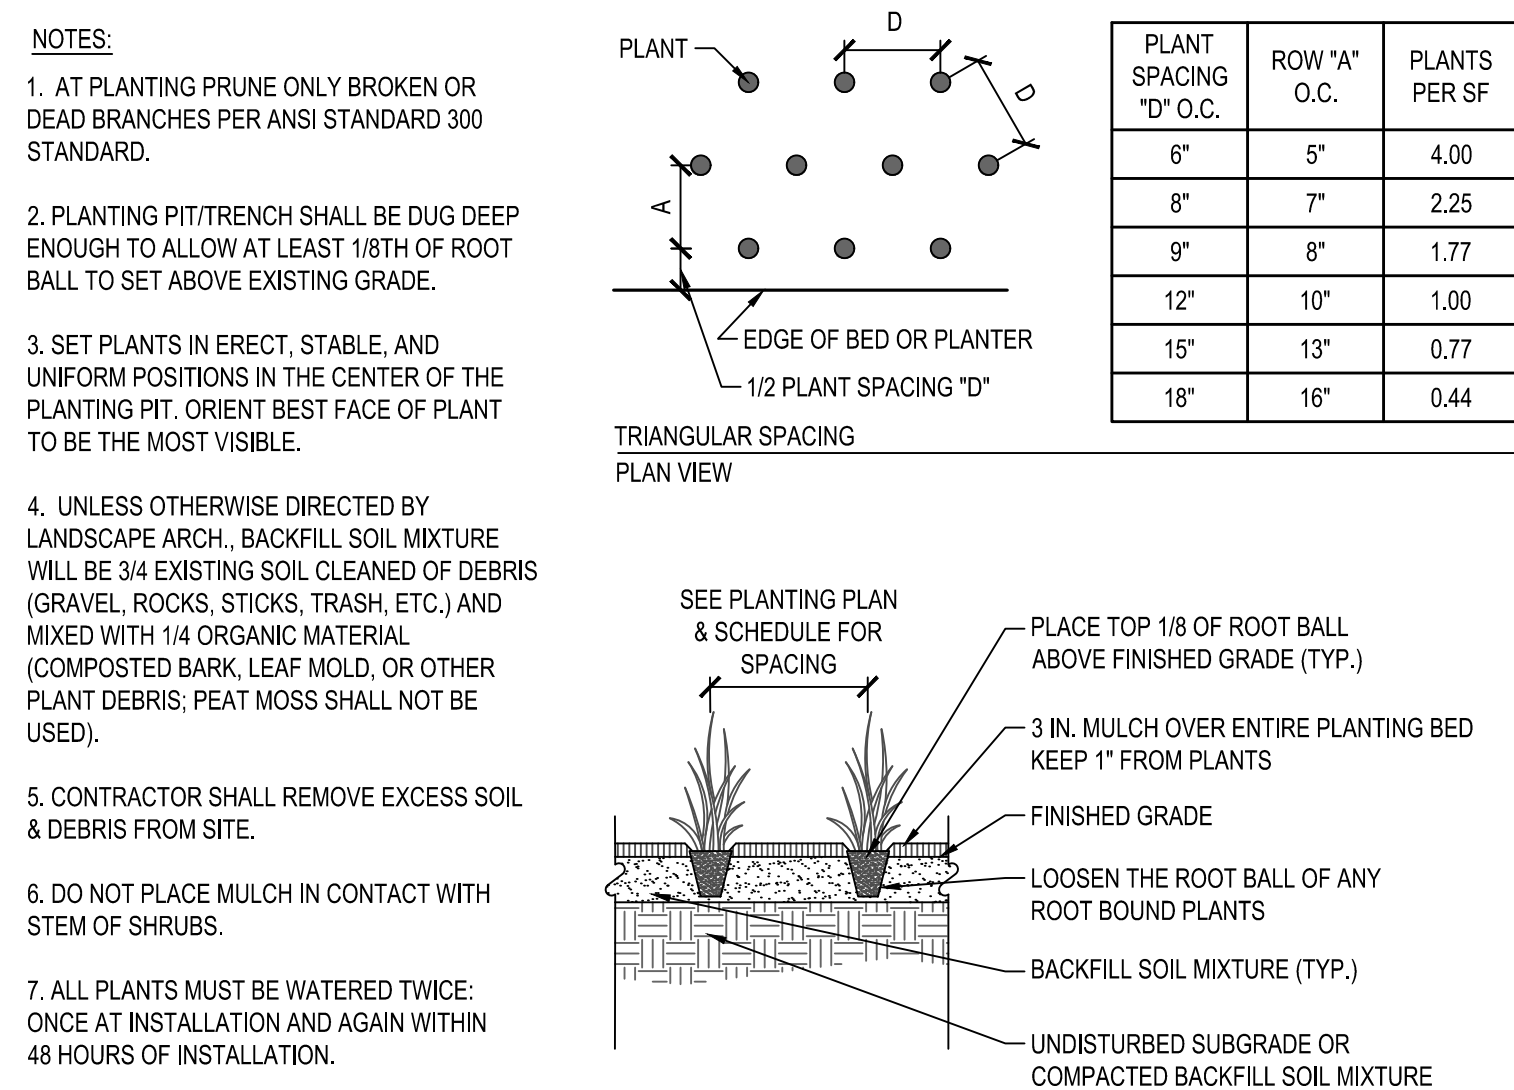
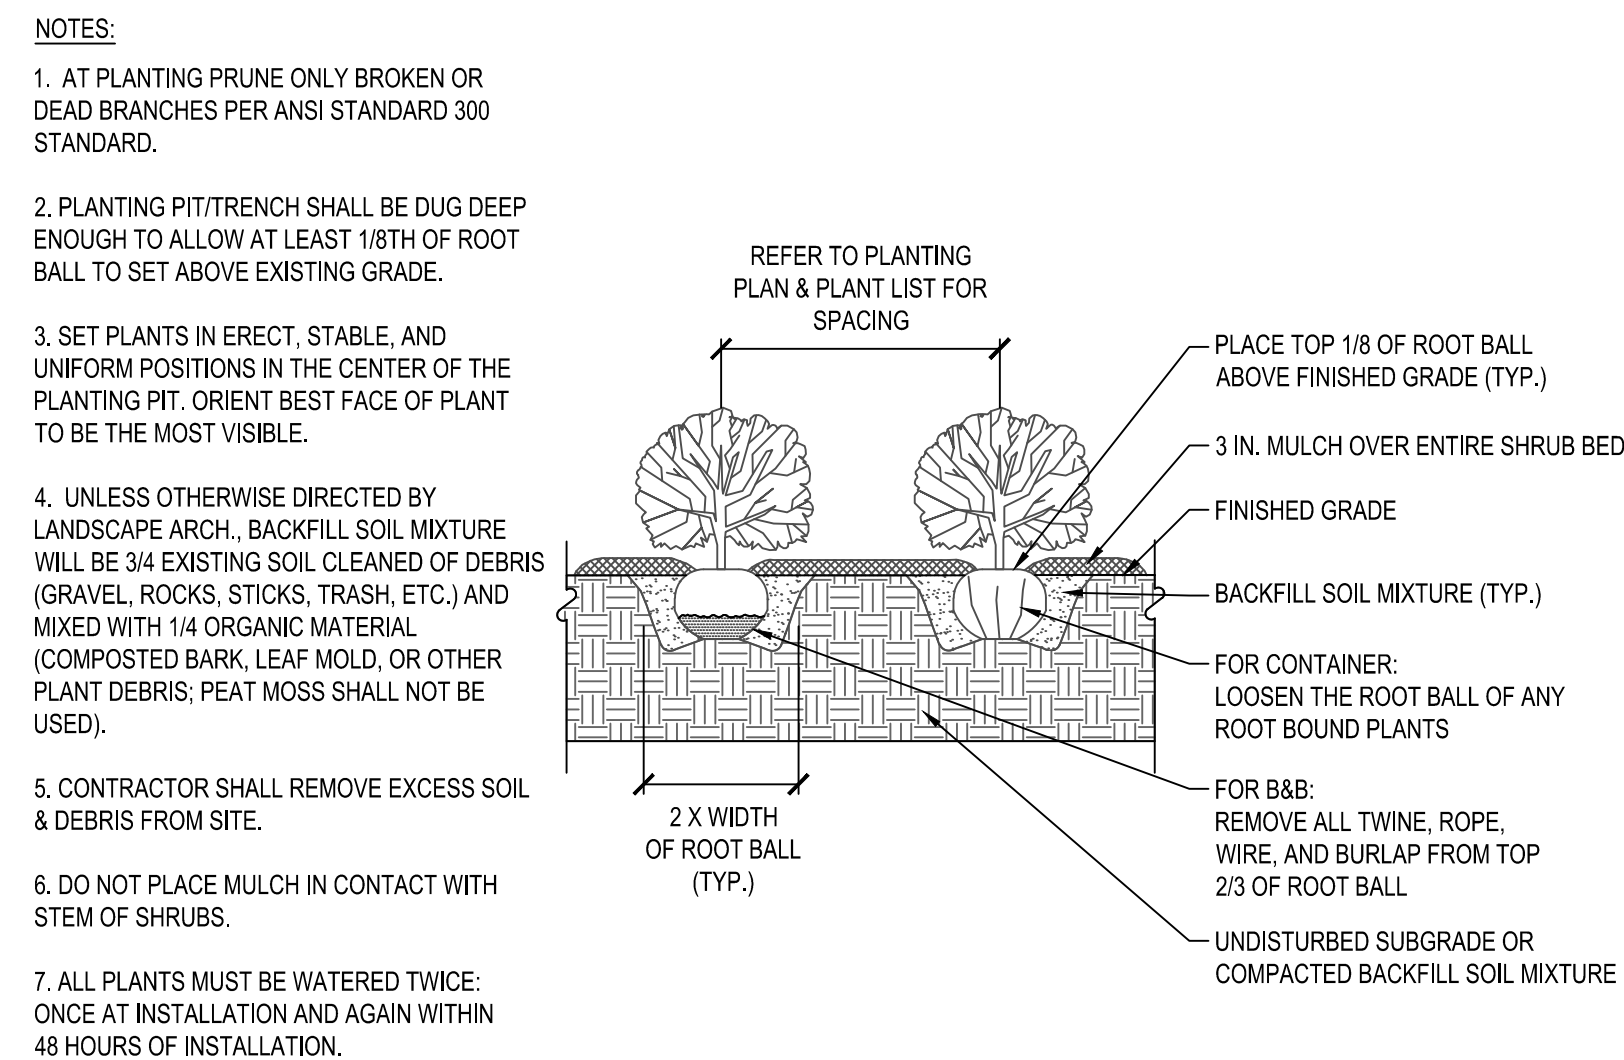
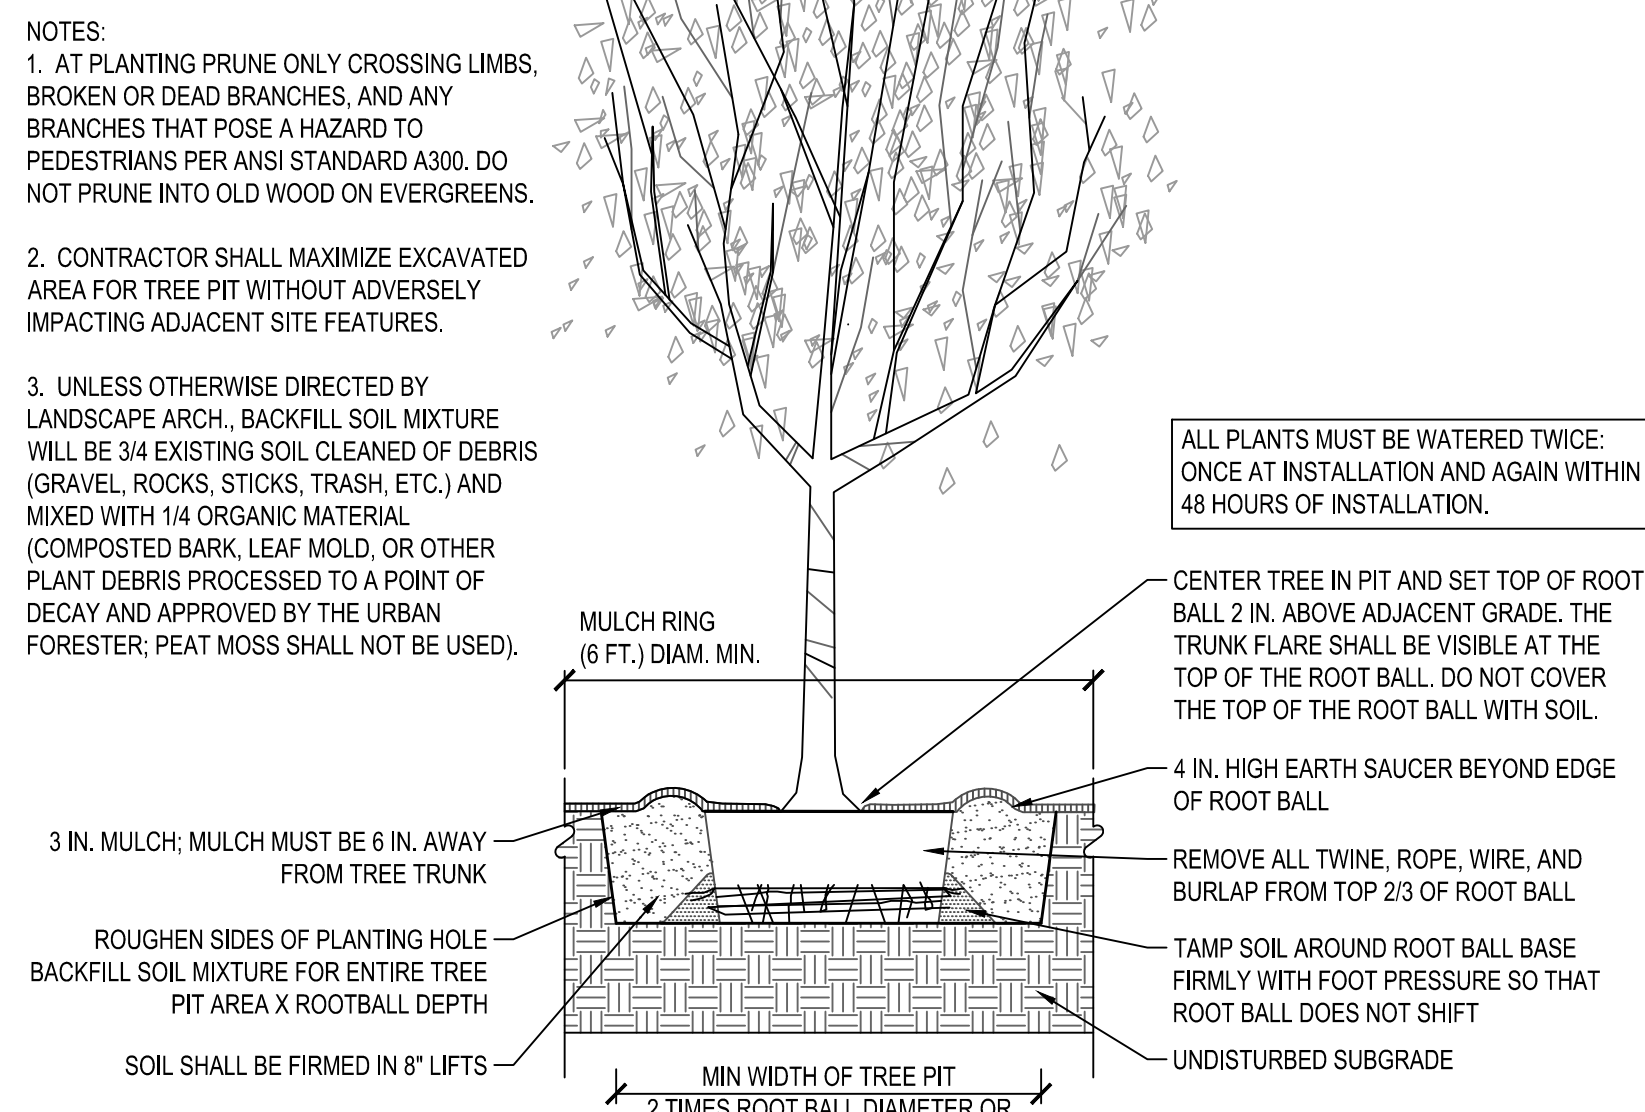
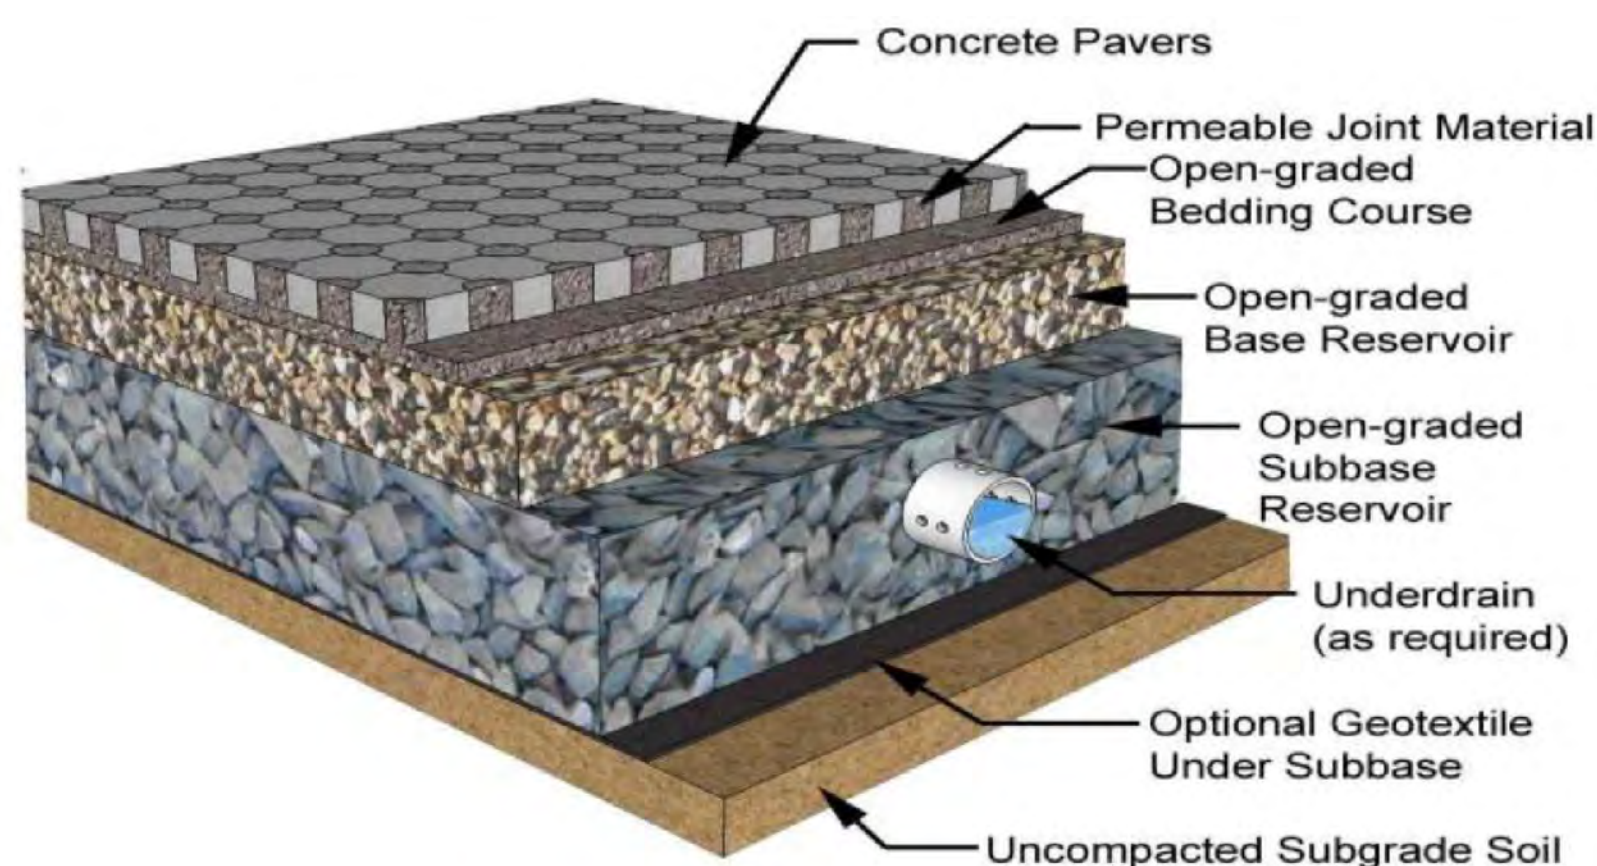
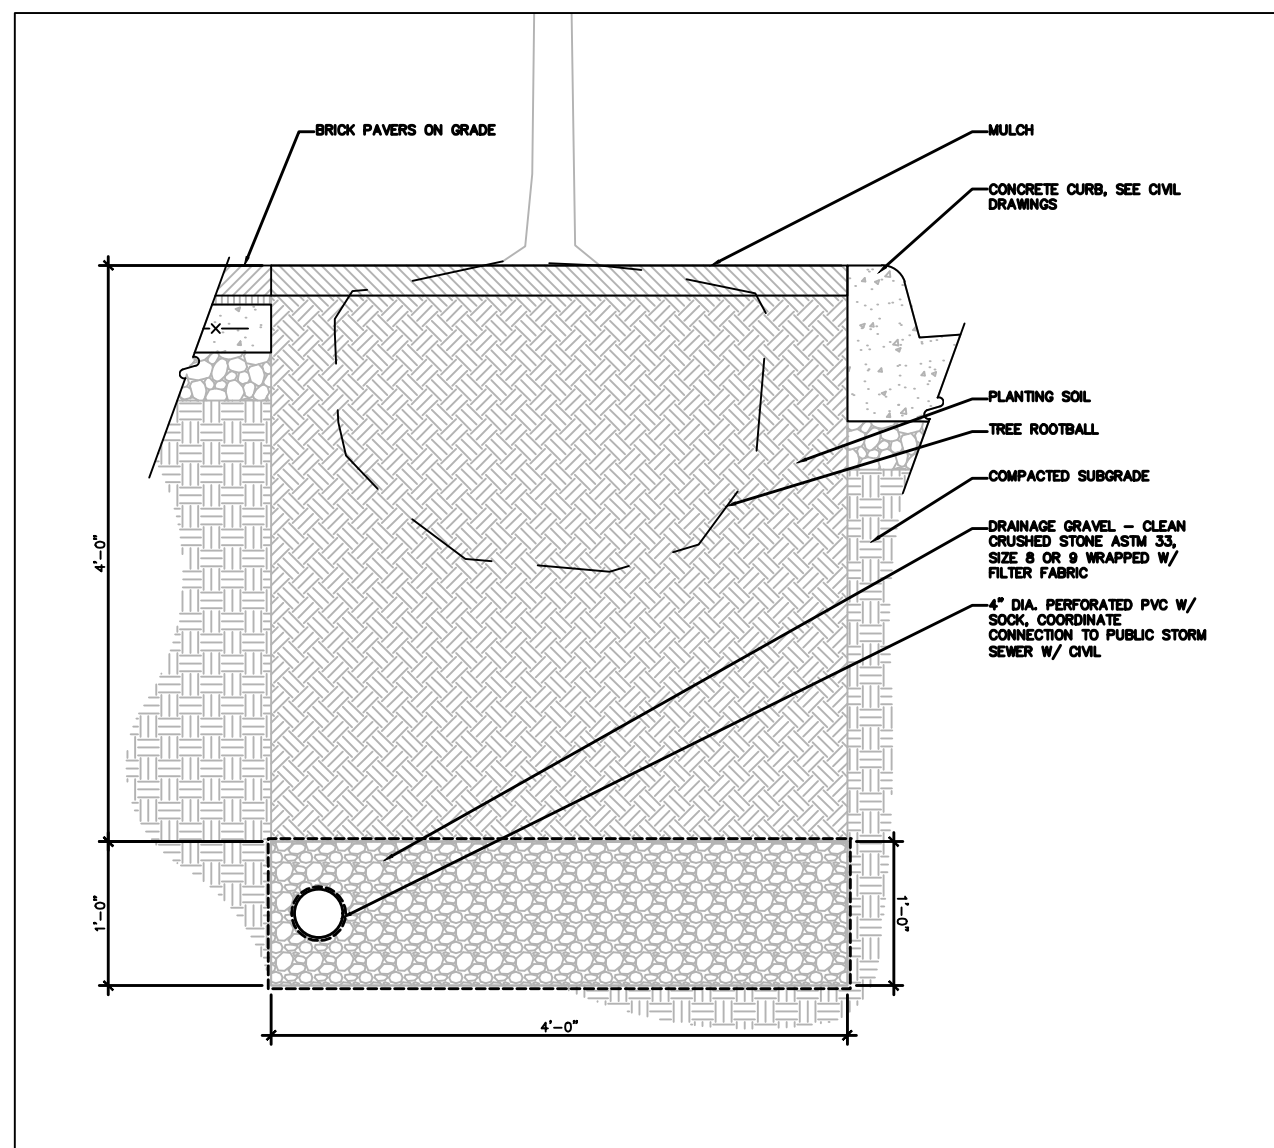
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DATE: 09/05/2018, 01/15/2019

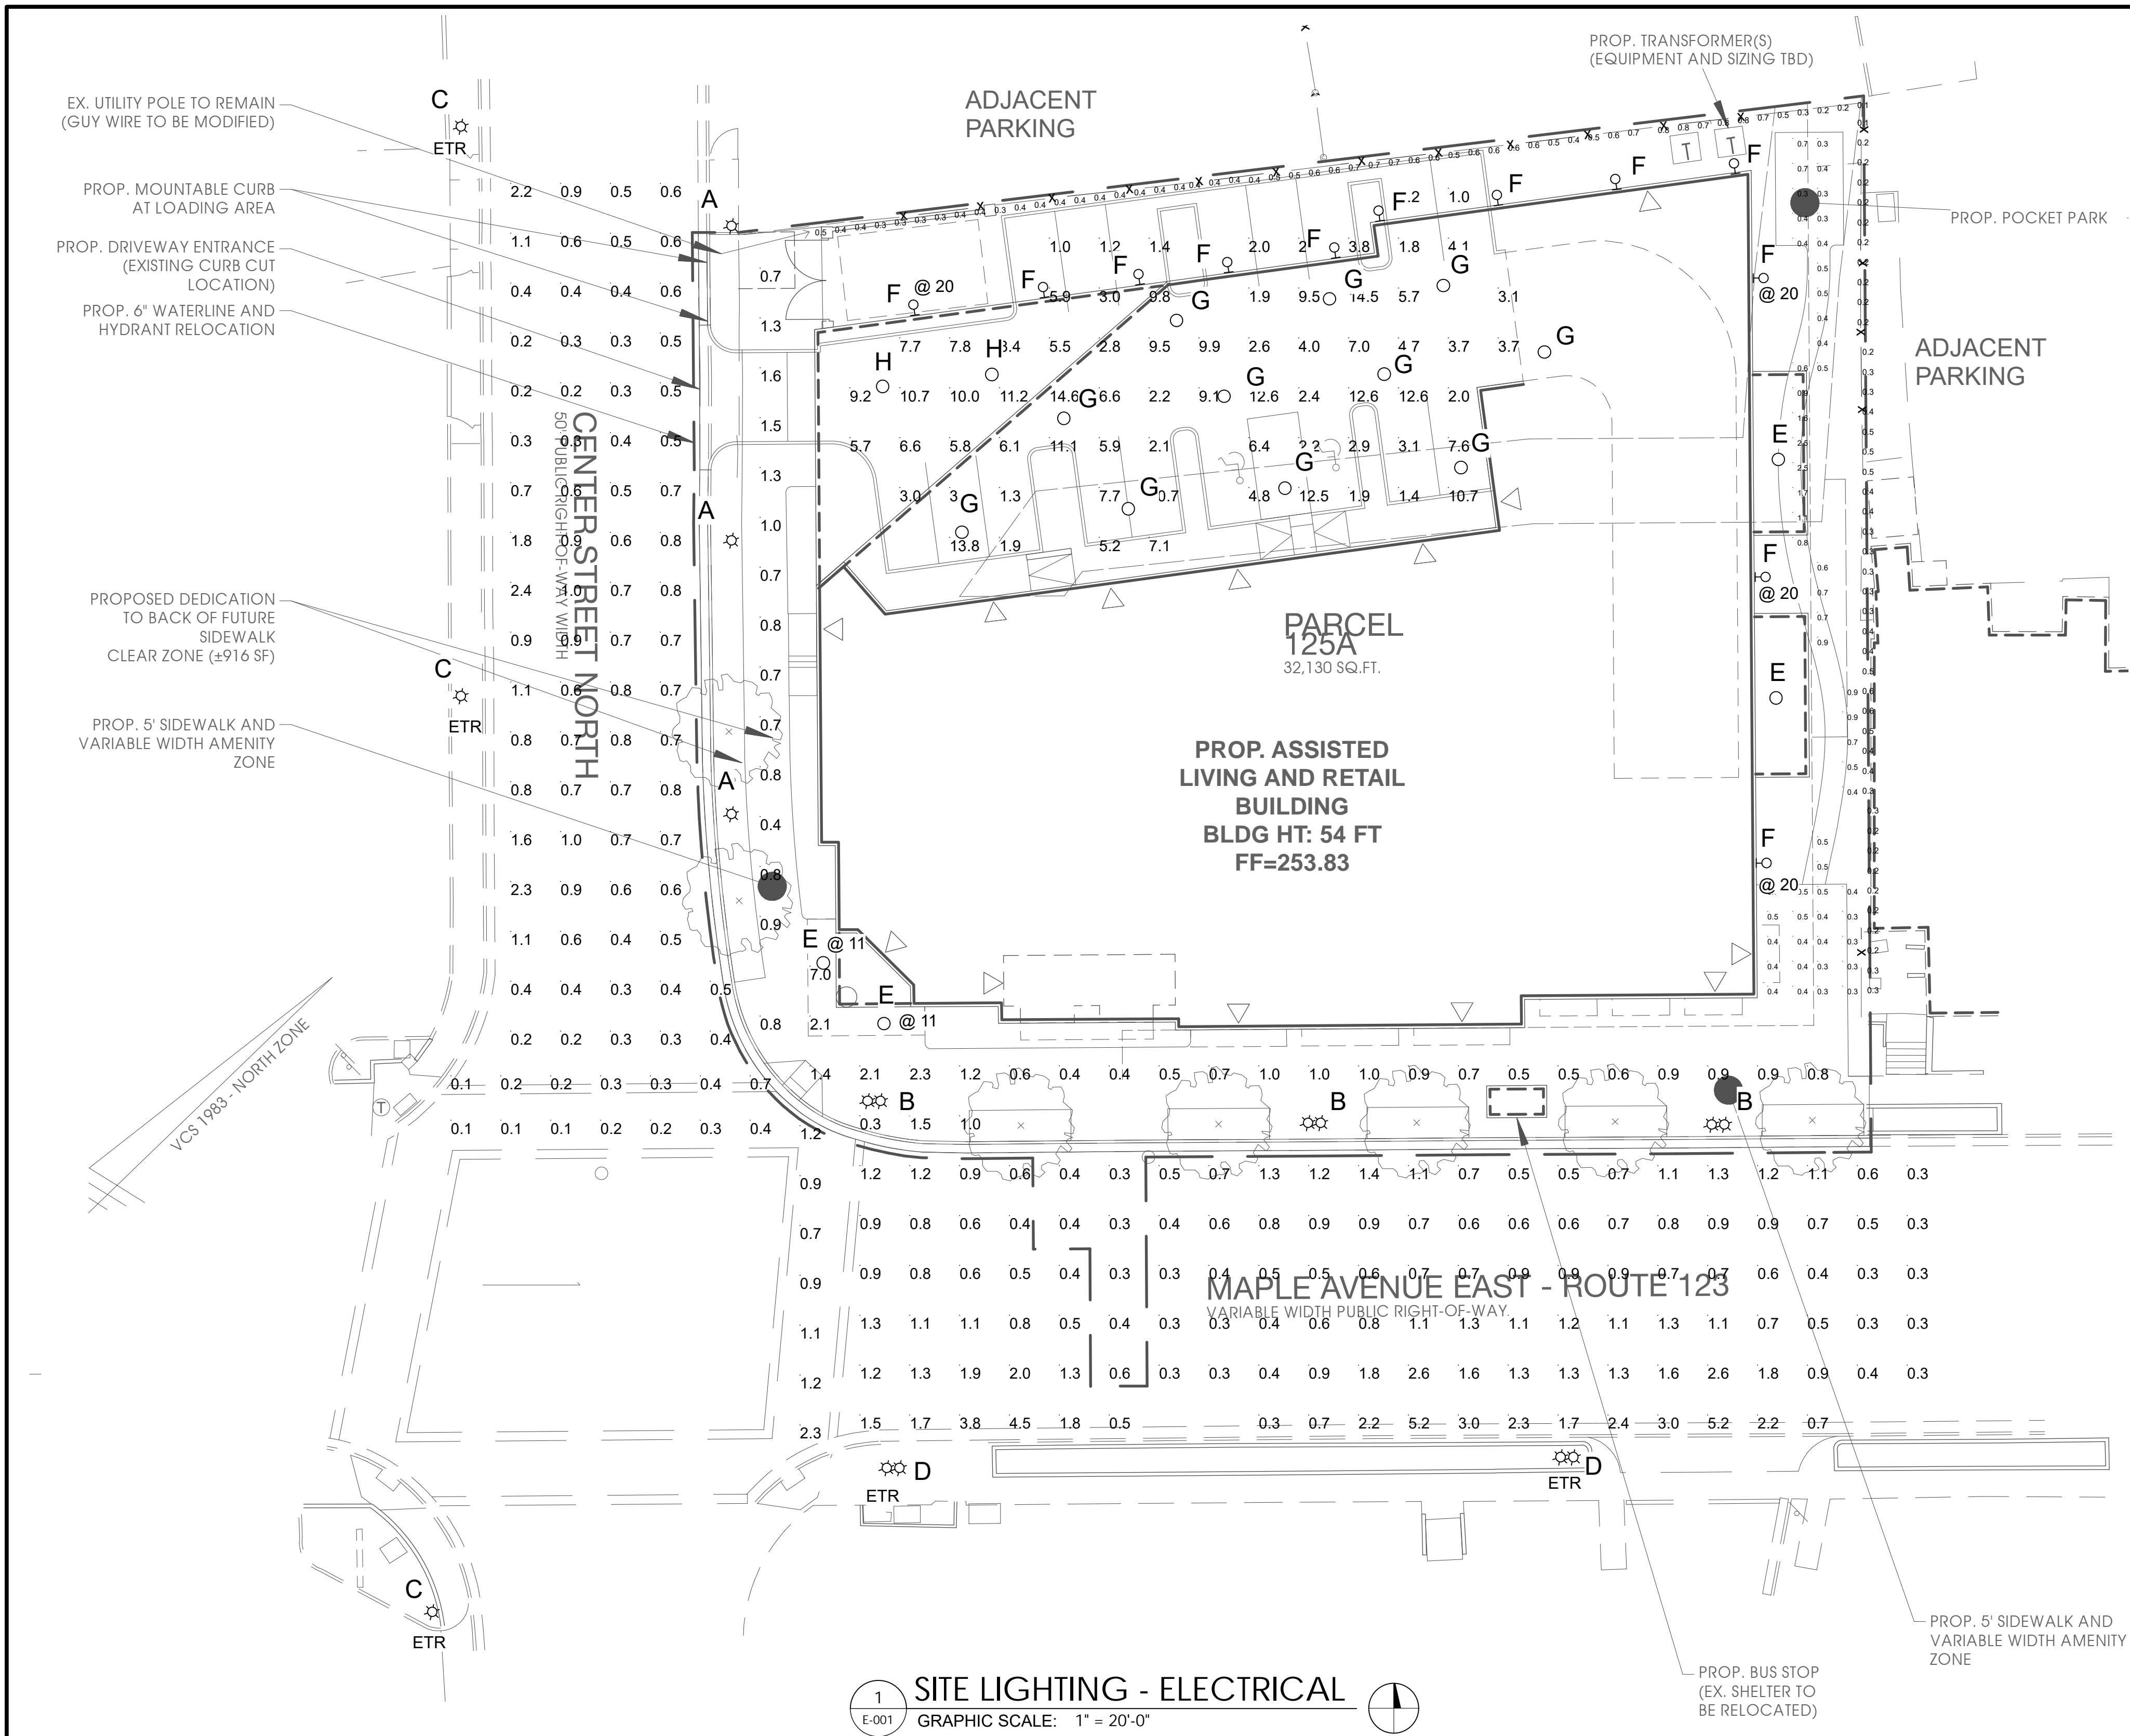
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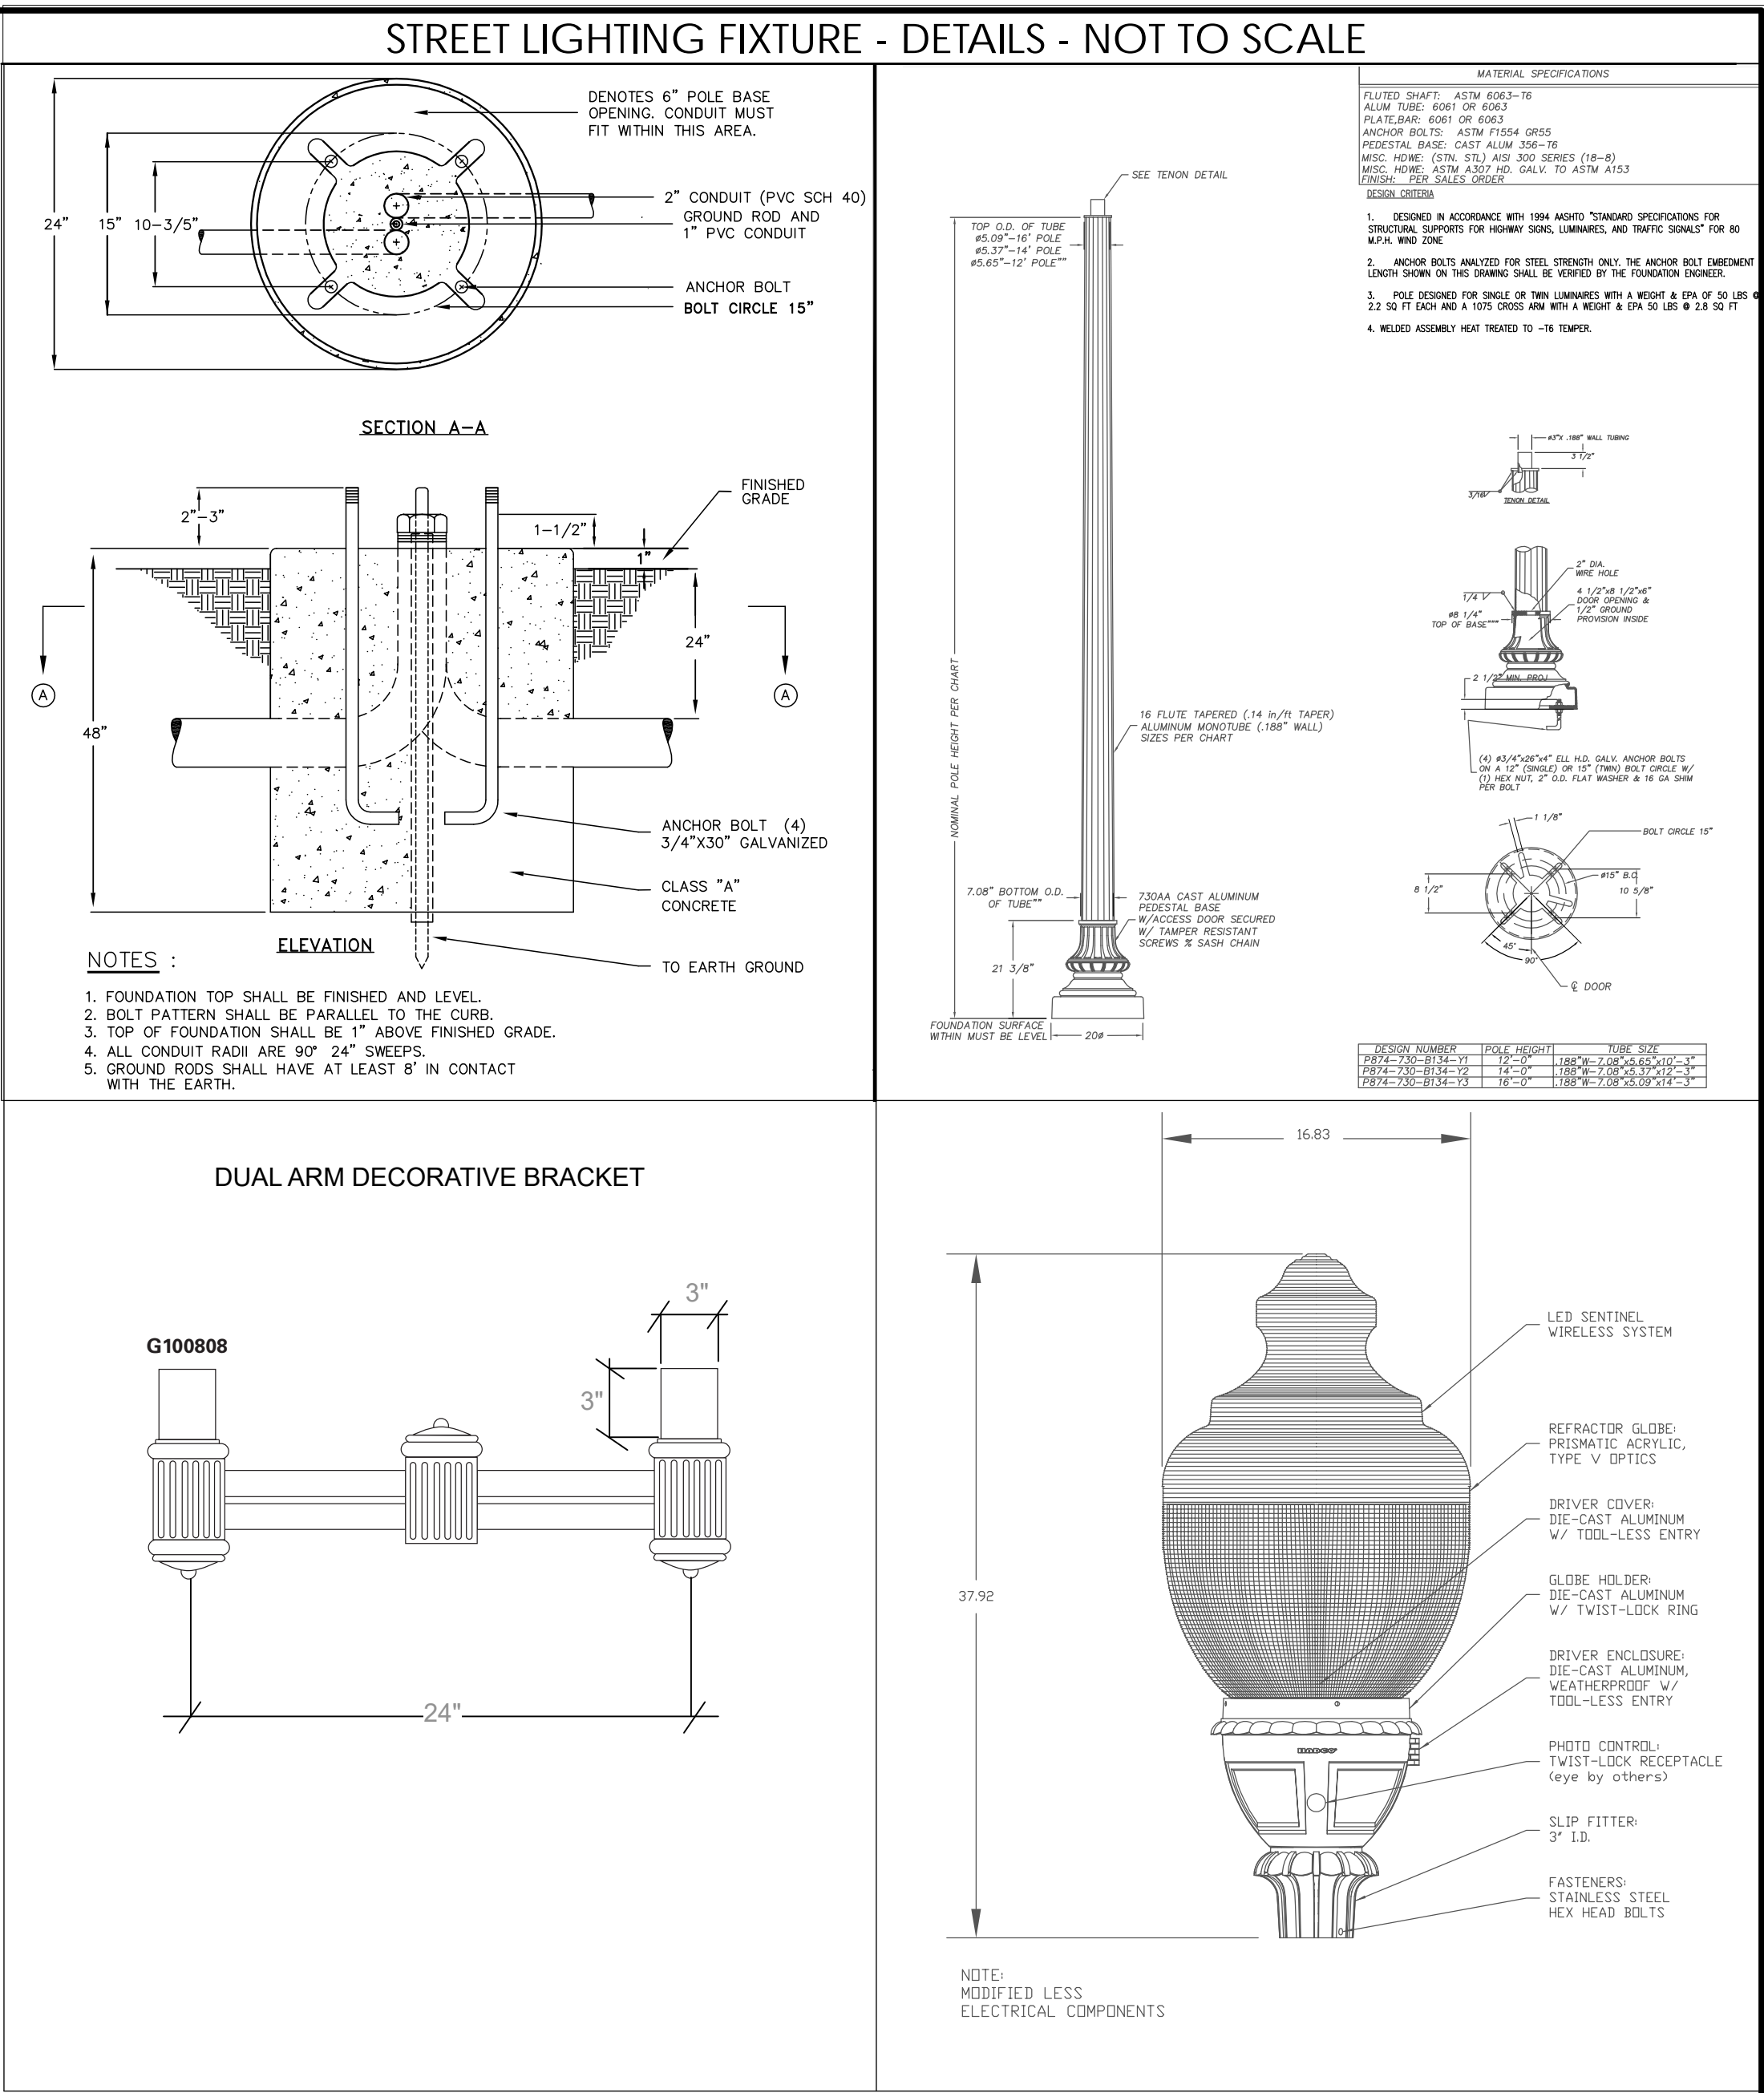




1 SITE LIGHTING - ELECTRICAL  
E-001 GRAPHIC SCALE: 1" = 20'-0"

LIGHTING FIXTURE SCHEDULE									
FIXT. TYPE	DESCRIPTION	MANUFACTURER	CAT. NO.	LAMPS		VOLT	MOUNTING	REMARKS	ETR = EXISTING TO REMAIN
				NO.	TYPE				
A	NEW DOMINION LED CARLYLE GLOBE	RELUME TECHNOLOGIES	UA-S-D3-48-CW-UL-1 WITH DEC GRN FLUTED POLE	1	54.9 WATT 4000K LED	U	GROUND POLE	14' POLE HEIGHT	
B	NEW DOMINION LED CARLYLE DOUBLE GLOBE	RELUME TECHNOLOGIES	UA-S-D3-48-CW-UL-1 WITH DEC GRN FLUTED POLE	2	54.9 WATT 4000K LED	U	GROUND POLE	14' POLE HEIGHT	
C	EXISTING DOMINION HPS CARLYLE SINGLE GLOBE	COOPER LIGHTING	WS15SX33PR	1	70 WATT HPS	U	GROUND POLE	MTD @ 14'	
D	EXISTING DOMINION HPS CARLYLE DOUBLE GLOBE	COOPER LIGHTING	WS15SX33PR	2	70 WATT HPS	U	GROUND POLE	MTD @ 14'	
E	CANOPY WALKWAY RECESSED LUMINAIRE	EATON	PD610ED010-PDM6A830-64VC	1	12.1 WATT 3000K LED	U	RECESSED CEILING	MTD @ 18' UON	
F	EXTERIOR BUILDING MTD LED SCNCE	WAC LIGHTING	RPL-GLA-1917	1	11 WATT 3000K LED	U	WALL SURFACE	MTD @ 12' UON	
G	GARAGE LOW CEILING LED FIXTURE	GE	ECR-A-0-A5-F-525-40K-4-B-D	1	35 WATT 4000K LED	U	RECESSED CEILING	MTD @ 8.5'	
H	GARAGE HIGH CEILING LED FIXTURE	GE	ECR-A-0-B5-F-525-40K-4-B-D	1	64 WATT 4000K LED	U	RECESSED CEILING	MTD @ 18'	

STATISTICS					
AREA DESCRIPTION	AVERAGE	MAXIMUM	MINIMUM	MAX/MIN	AVG/MIN
PARKING GARAGE	6	14.6	1	14.6:1	6.0:1
CENTER STREET NORTH	0.7	2.4	0.2	12.0:1	3.5:1
MAPLE AVENUE	1	5.2	0.3	17.3:1	3.3:1
CROSSWALK	0.7	2.3	0.1	23.0:1	7.0:1
SIDEWALK	1.1	7	0.4	17.5:1	2.8:1
POCKET PARK	0.6	2.5	0.3	8.3:1	2.0:1



**SUMMIT ENGINEERS, INC.**  
Mechanical/Electrical/Consultants  
10007 Lee Hwy, Arlington, VA 22209  
703-533-5553 summitengineers.com

SUMMIT PROJECT # 2018074.00

ARLINGTON, VIRGINIA  
DEPARTMENT OF ENVIRONMENTAL SERVICES  
**SUNRISE of VIENNA**  
---  
VIENNA, VIRGINIA

SCALE: AS INDICATED	SHEET: E-001	DRAWN: ALW	CHECKED: JKD
SUBMITTED DATE:	09.11.18		