
SCREEN PORCH & DECK TO THE SCHAMPERS RESIDENCE

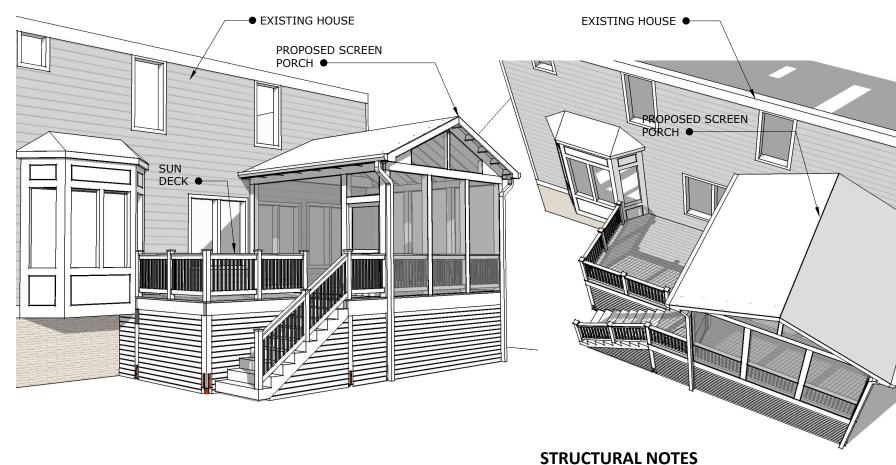

WOODS

ALL 6X6 POST SHALL BE SOUTHERN YELLOW PINE SHALL HAVE THE FOLLOWING

MINIMUM PROPERTIES: BENDING STRESS "Fb"

=850 PSI

COMPRESSION PARALLEL TO GRAIN "Fc" =575 PSI

COMPRESSION PERPENDICULAR TO GRAIN "Fc" =375 PSI

MODULUS OF ELASTICITY "E"

=1,200,000 PSI

LUMBER FOR DECKS SHALL BE MINIMUM #2 SOUTHERN YELLOW PINE, PRESSURE TREATED TO 0.40 LB RETENTION, HAVING THE FOLLOWING PROPERTIES:

COMPRESSION PERPENDICULAR TO GRAIN "Fc"

MODULUS OF ELASTICITY "E"

HORIZONTAL SHEAR "Fv" BENDING STRESS "Fb"

=1,600,000 PSI

=565 PSI

=90 PSI

=1500,1250,1200,1050,&975

for 2X4,2X6,2X8,2X10 &2X12

RESPECTIVELY.

CONTENT

A-01 NOTES/COVER PAGE

A-02 FOUNDATION PLAN

A-05 ROOF FRAMING PLAN

A-07 LEFT-SIDE ELEVATION

A-08 RIGHT-SIDE ELEVATION

A-11 CONSTRUCTION DETAILS

A-12 CONSTRUCTION DETAILS

A-13 HELICAL PIER DETAILS

A-14 ELECTRICAL PLAN

A-03 FRAMING PLAN

A-06 REAR ELEVATION

A-04 FLOOR PLAN

A-09 SECTION A-A

A-10 SECTION B-B

LVL'S (LAMINATED VENER LUMBER) SHALL BE 1-3/4" WIDE .OF THE DEPTH SPECIFIED ON THE PLANS .AND SHALL BE SECURED TOGETHER AS DIRECTED BY THE MANUFACTURER. THEY SHALL HAVE THE FOLLOWING PROPERTIES:

BENDING STRESS "Fb" = 2600 psi for 1' depth, for other multiply by [12/d] 0.136

HORIZONTAL SHEAR "Fv" =285 PSI

COMPRESSION PERPENDICULAR TO GRAIN "Fc" =750 PSI

MODULUS OF ELASTICITY "E" =1,900,000 PSI

DESIGN CRITERIA

LIVE LOAD =30PSF

ROOF LIVE LOAD = 30 PSF,

HANDRAILS LIVE LOAD = 200 PSF

STAIRS

LOAD ACTING OVER 4 SQ. INCHES

BASIC WIND SPEED = 116 MPH,3 SECOND GUST,20 PSF

MINIMUM

SEISMIC DESIGN CATEGORY = A, AS PER IRC R301.2

PER IRC R401.4.1

CONCRETE: CONCRETE FOR FOOTINGS TO BE MIN 3000 PSI, NORMAL WEIGHT, AIR ENTRAINED.

CONCRETE

1: ALL CONCRETE CONSTRUCTION SHALL CONFORM TO THE ACI CODE 318-95

2:28-DAY CONCRETE STRENGTH SHALL BE A S **FOLLOWS: STONE CONCRETE:**

COURSE AGGREGATE SHALL CONFORM TO ASTM

C33. F C = 3000 PSI

3: DO NOT PLACE CONCRETE OVER FROZEN SOIL

4: SLABS ON GRADE SHALL BE 4" THICK CONCRETE AND REINFORCED WITH 6X6 W1.4XW1.4 WWF, UNLESS OTHERWISE NOTED ON PLANS. LAP MESH 8" IN EACH DIRECTION. PLACE CONCRETE OVER 6 MIL. POLYETHYLENE VAPOR BARRIER AND 4" MINIMUM COURSE OF AGGREGATE OR AS RECOMMENDED BY SOILS ENGINEER. THE AGGREGATE LAYER SHALL BE PLACED OVER FIRM NATURAL SUBGRADE OR A COMPACTED AND CONTROLLED FILL. FILL UNDER

SLABS SHALL BE COMPACTED IN 8" LAYERS TO 95% MAX. DENSITY. USE AIR-ENTRAINED AT ALL EXTERIOR SLABS.

LAUREL, MD 20723

PROJECT NAME

SCHAMPERS SCREEN PORCH/DECK

Drwg Date: Aug. 26th, 2019

ADDRESS

127 Lewis st. NW. Vienna VA 22180

SHEET NAME

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October 30, 2019

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SEE DRAWING

SCALE

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A-01

GENERAL NOTES

GENERAL SCOPE OF WORK

SCREEN PORCH AND SUN DECK ADDITION.

SCOPE OF WORK / PROJECT DESCRIPTION

SCREEN PORCH WITH GABLE ROOF. SUN DECK / GRILL DECK STAIR ACCESS

LAND DISTURBANCE

TO INSERT HELICAL PIERS

ONLY LAND DISTURBANCE WILL BE

FLOOR LIVE LOAD: 40 PSF,


EXCEPT IN SLEEPING ROOMS WHERE


GROUND SNOW LOAD= 35 PSF


=40 PSF OR 300 LBS CONCENTRATED


FROST/FOOTING DEPTH = 30 INCHES


SOIL BEARING CAPACITY = 1500 PSF, ASSUME SANDY CLAY AS

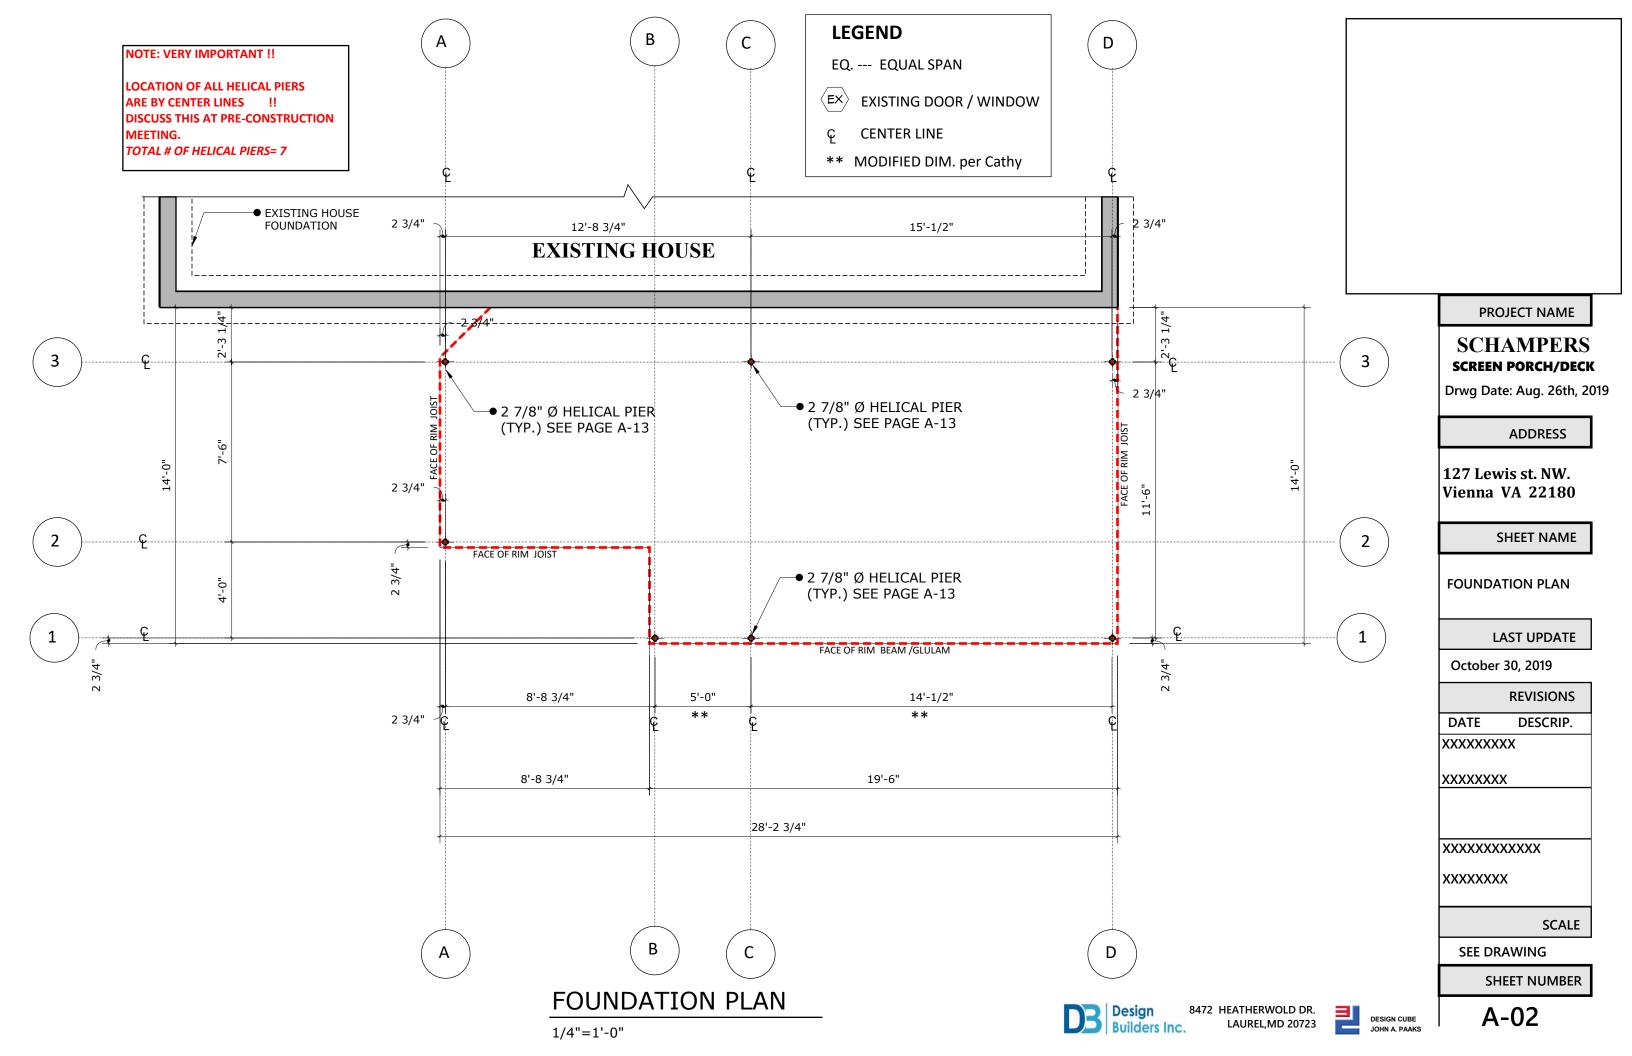


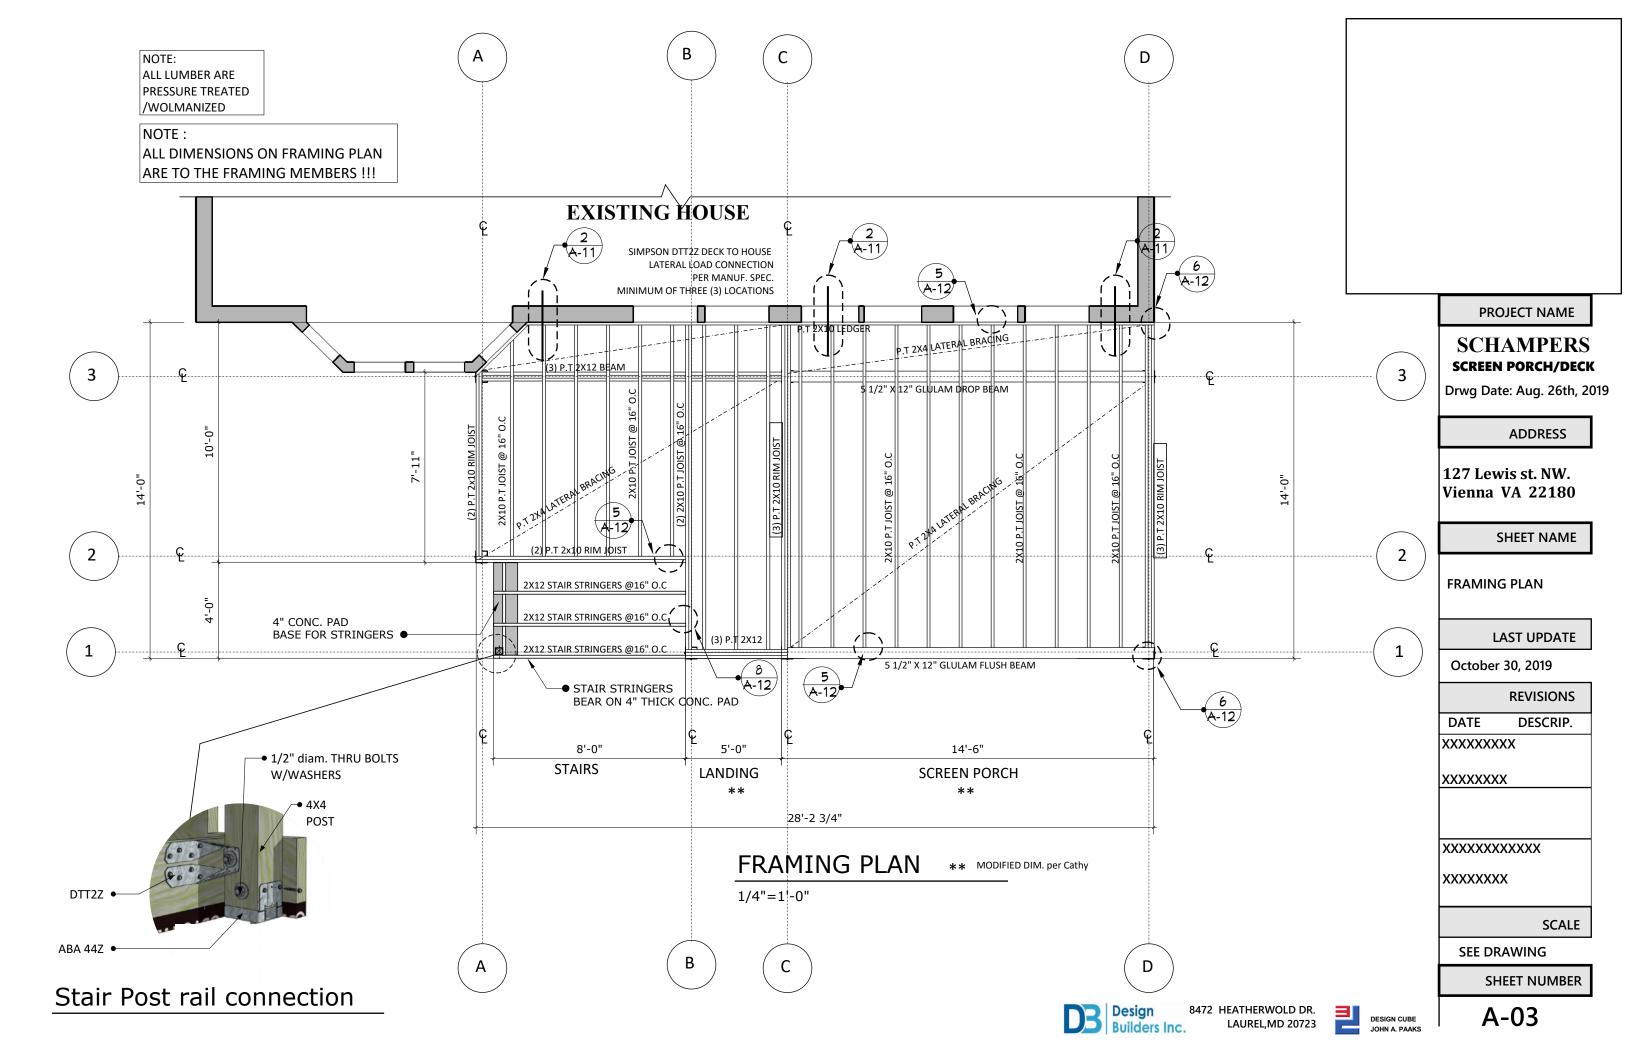

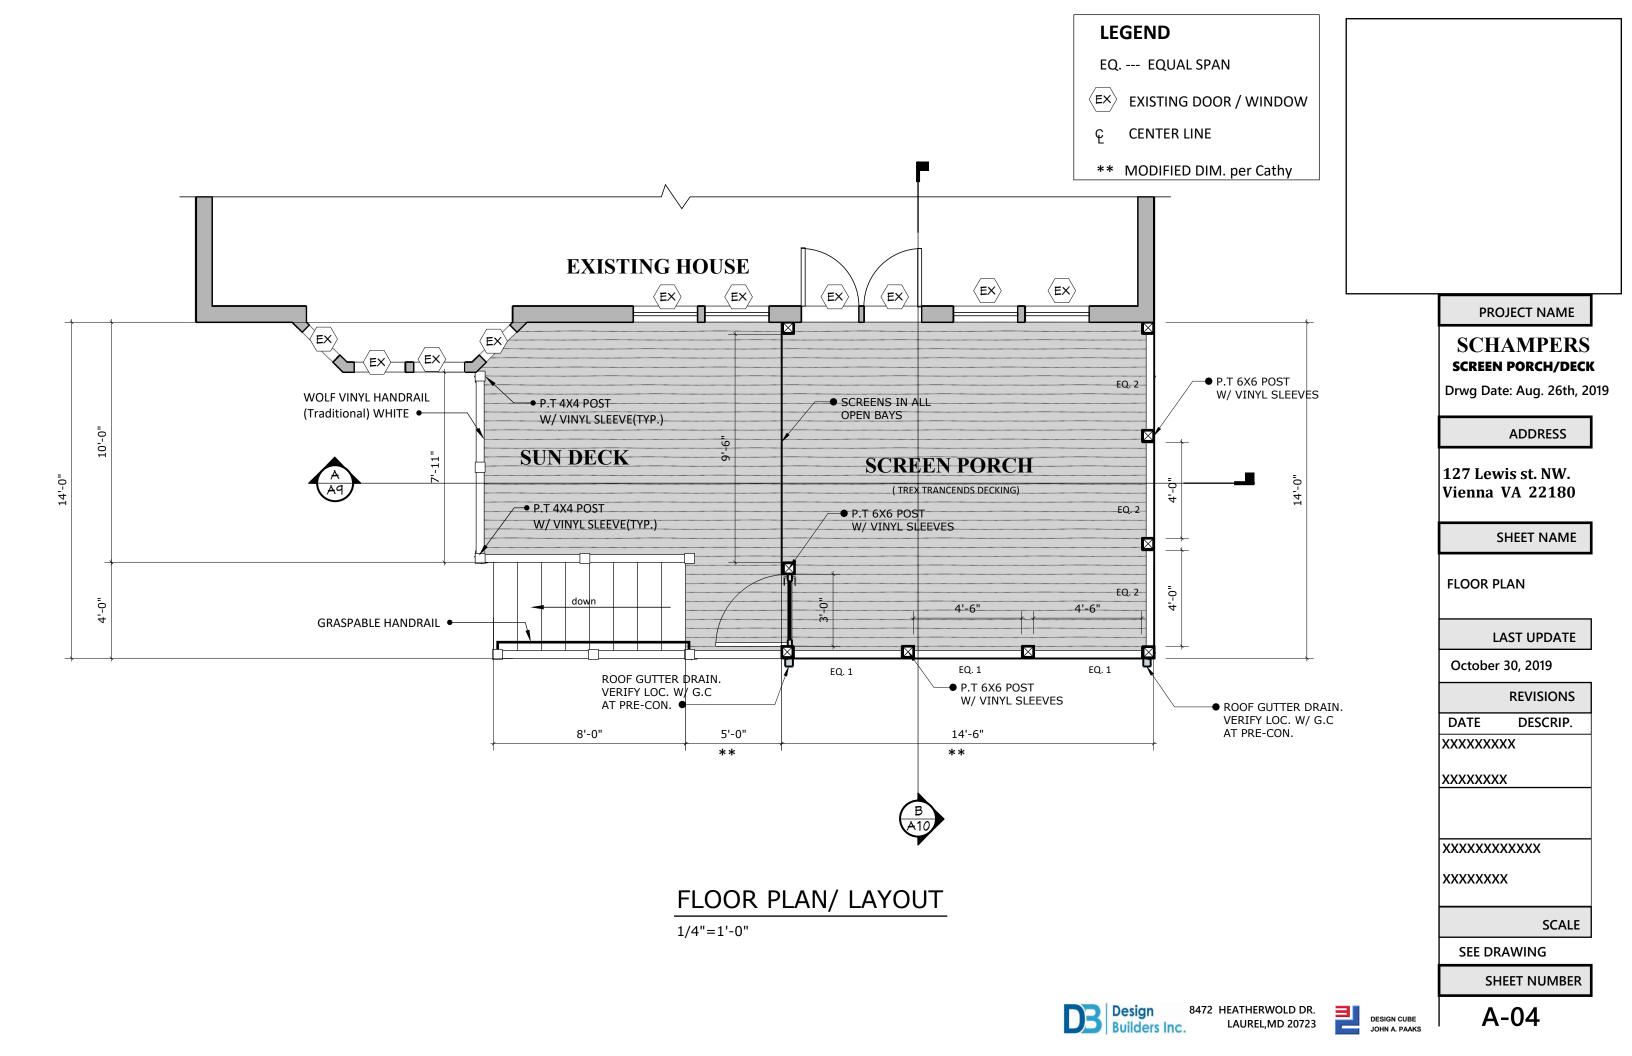

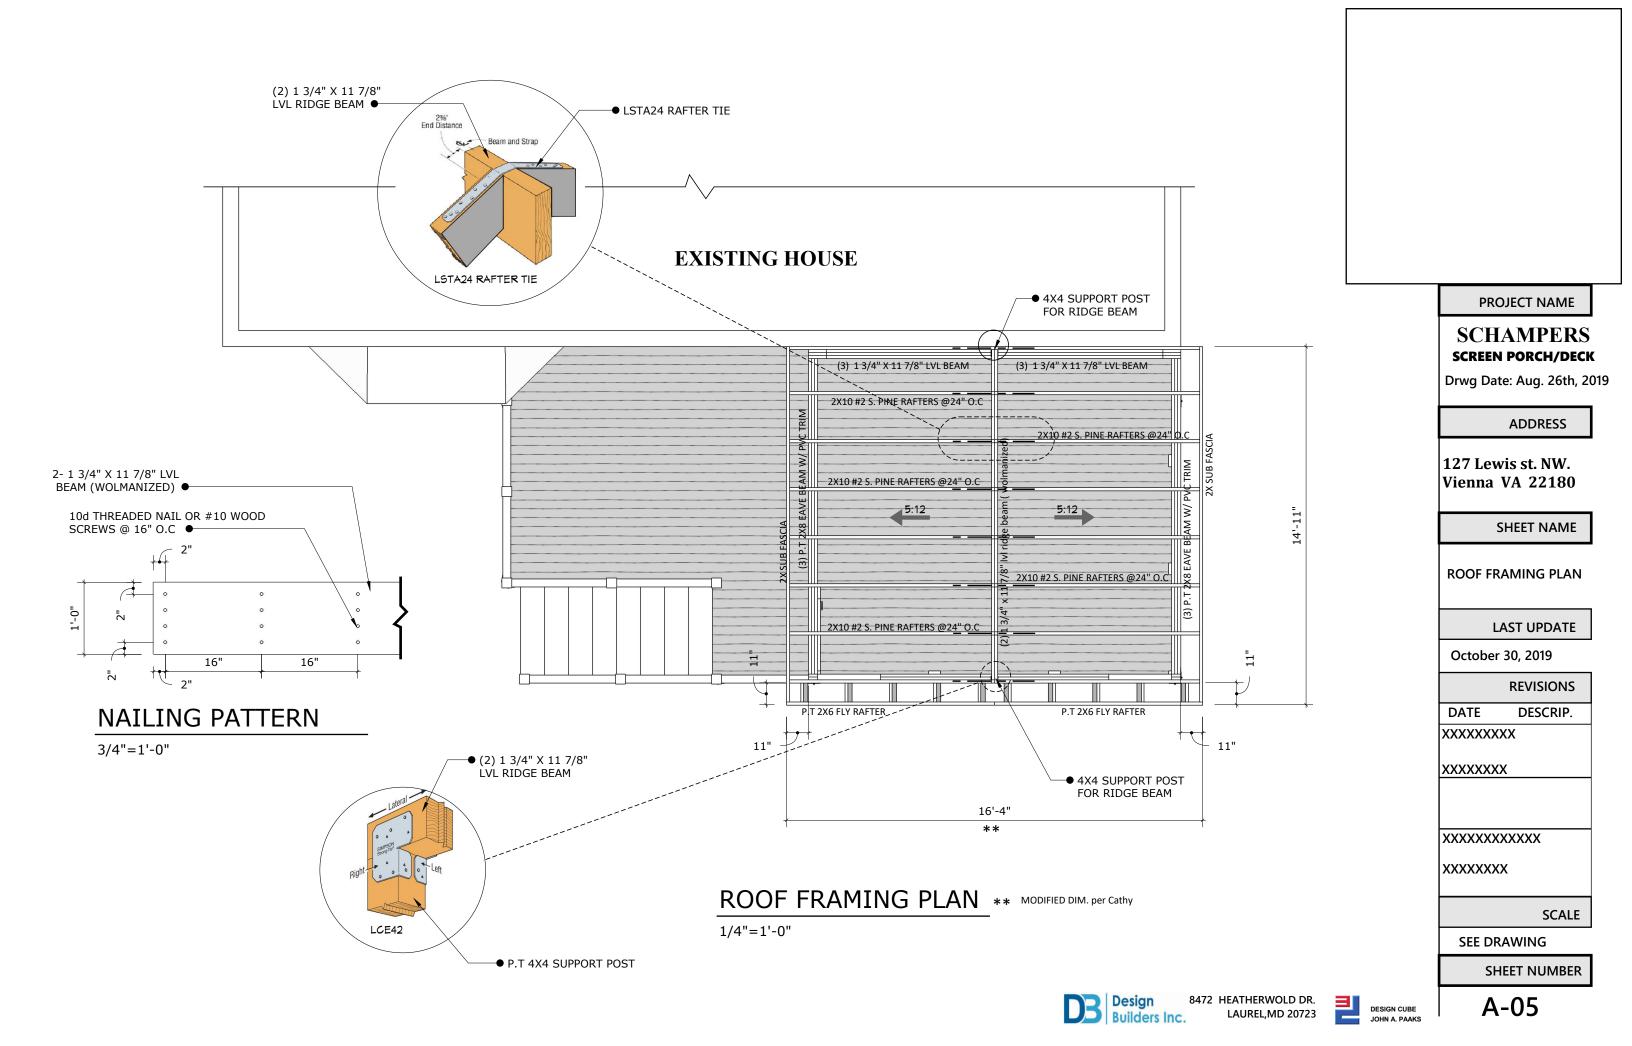

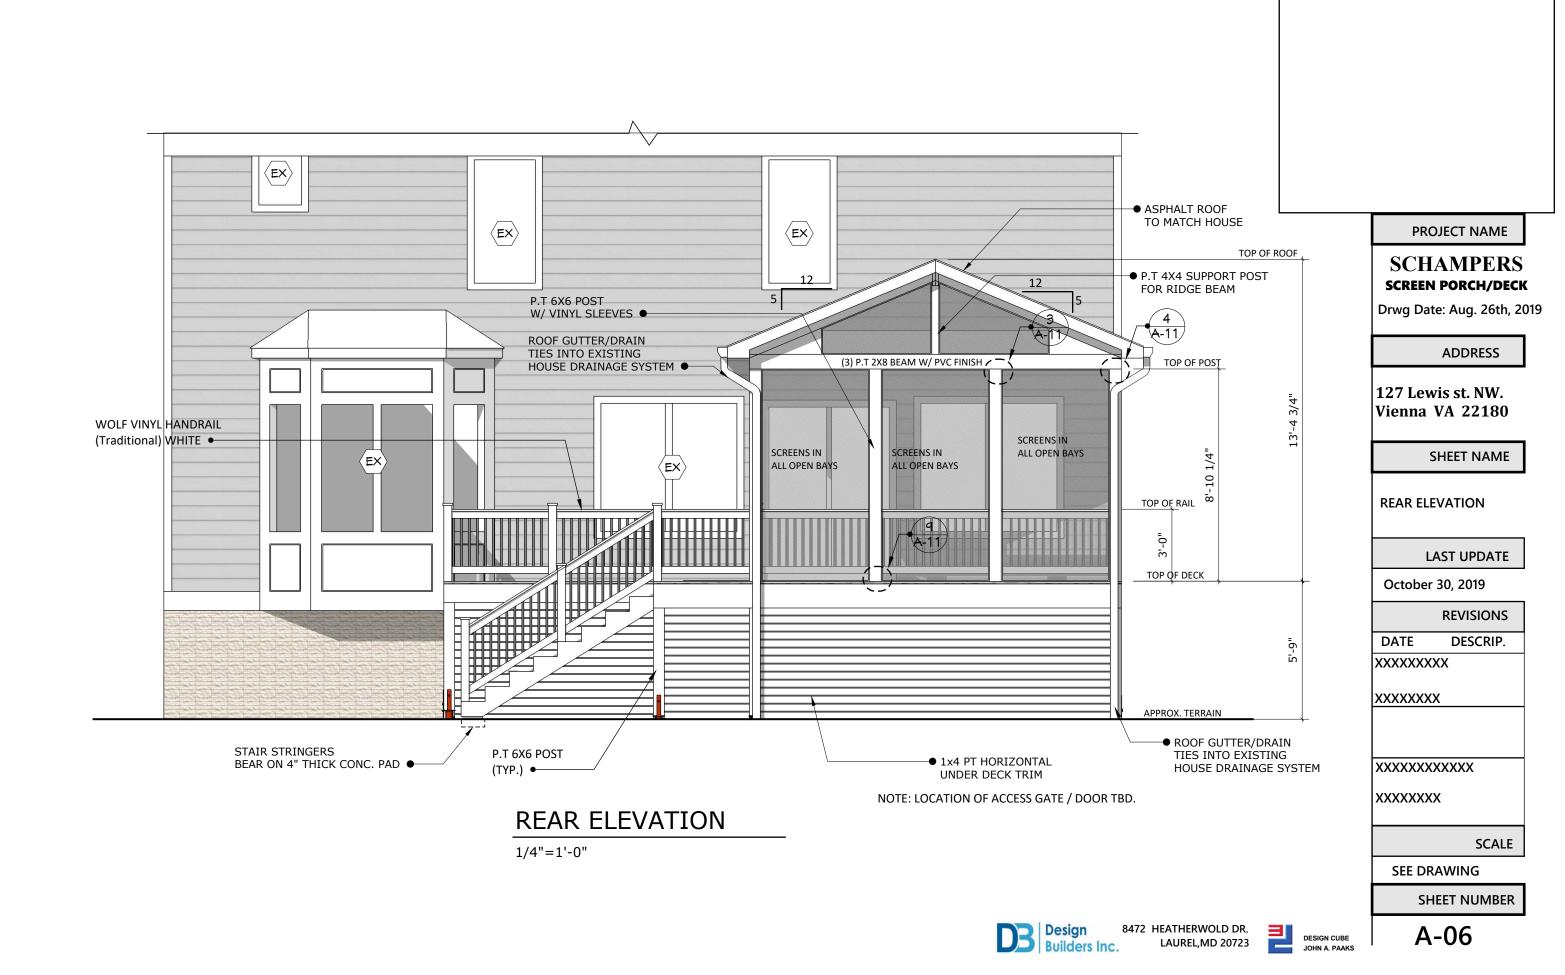

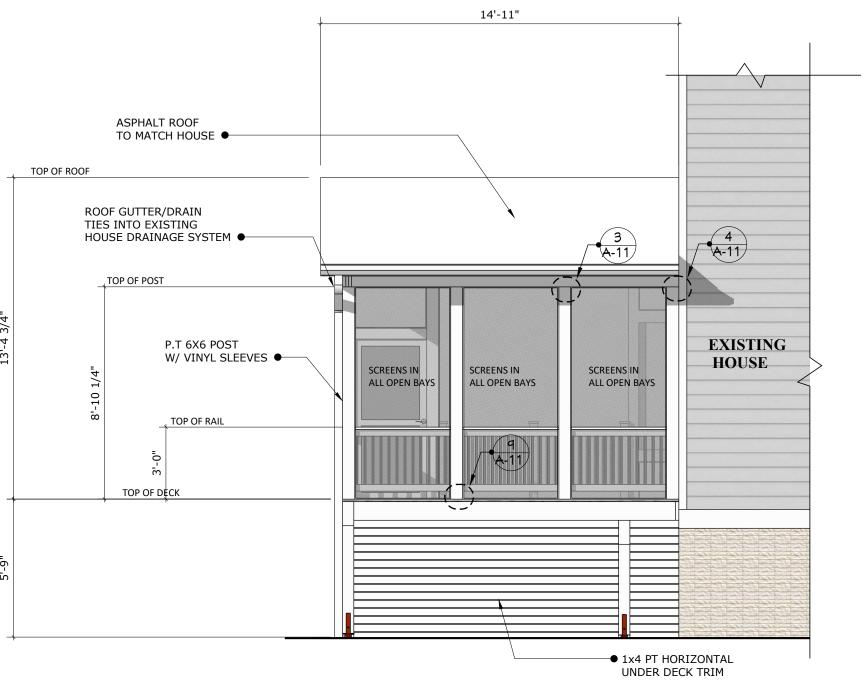

NOTE: LOCATION OF ACCESS GATE / DOOR TBD.

LEFT-SIDE ELEVATION

1/4"=1'-0"

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SHEET NAME

LEFT SIDE ELEVATION

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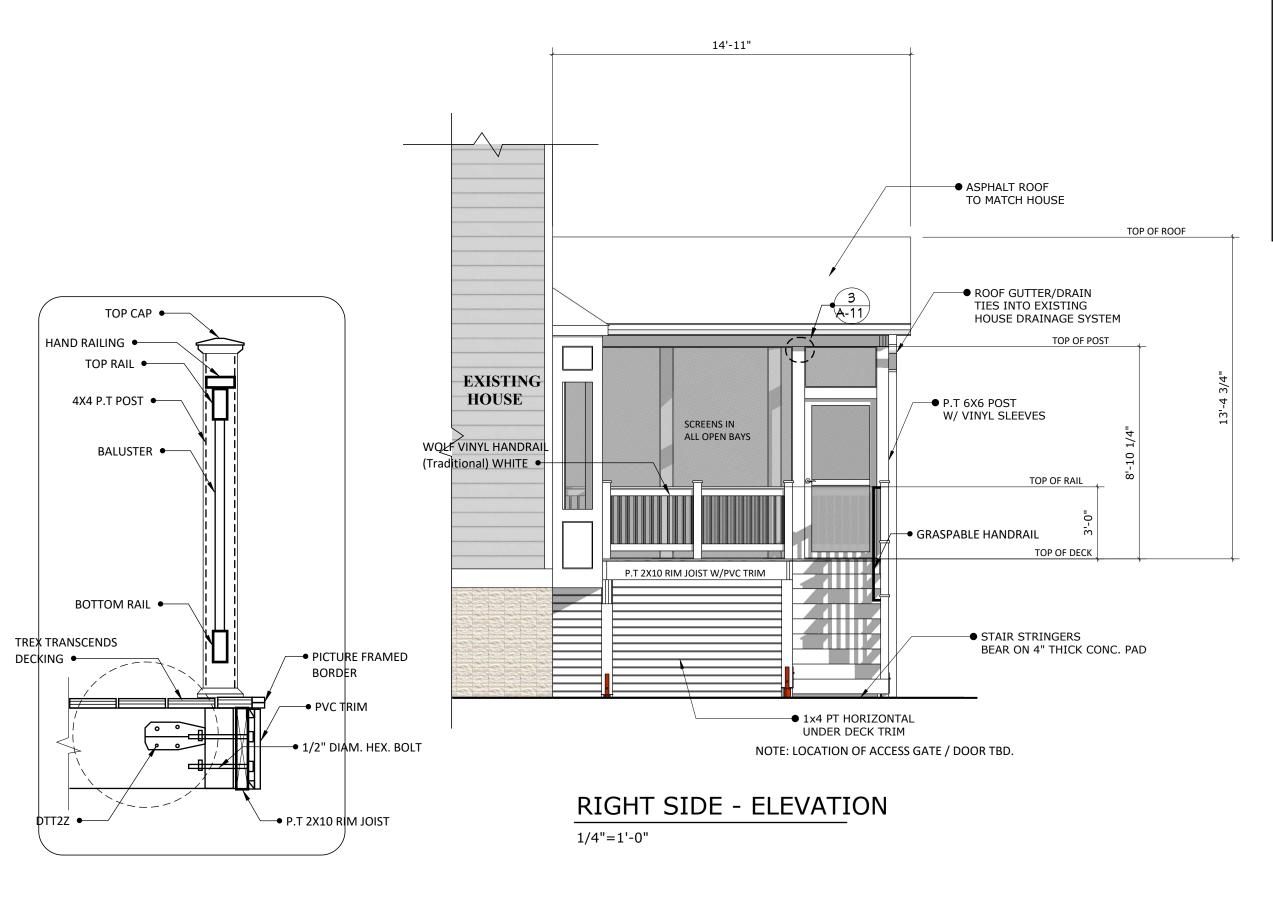
SEE DRAWING

SHEET NUMBER

Design 8472 HEATHERWOLD DR.
Builders Inc. LAUREL,MD 20723







Deck Post to Rail connection

8472 HEATHERWOLD DR. LAUREL,MD 20723

SHEET NUMBER

SCHAMPERS

SCREEN PORCH/DECK

PROJECT NAME

Drwg Date: Aug. 26th, 2019

ADDRESS

127 Lewis st. NW. Vienna VA 22180

SHEET NAME

RIGHT-SIDE ELEVATION

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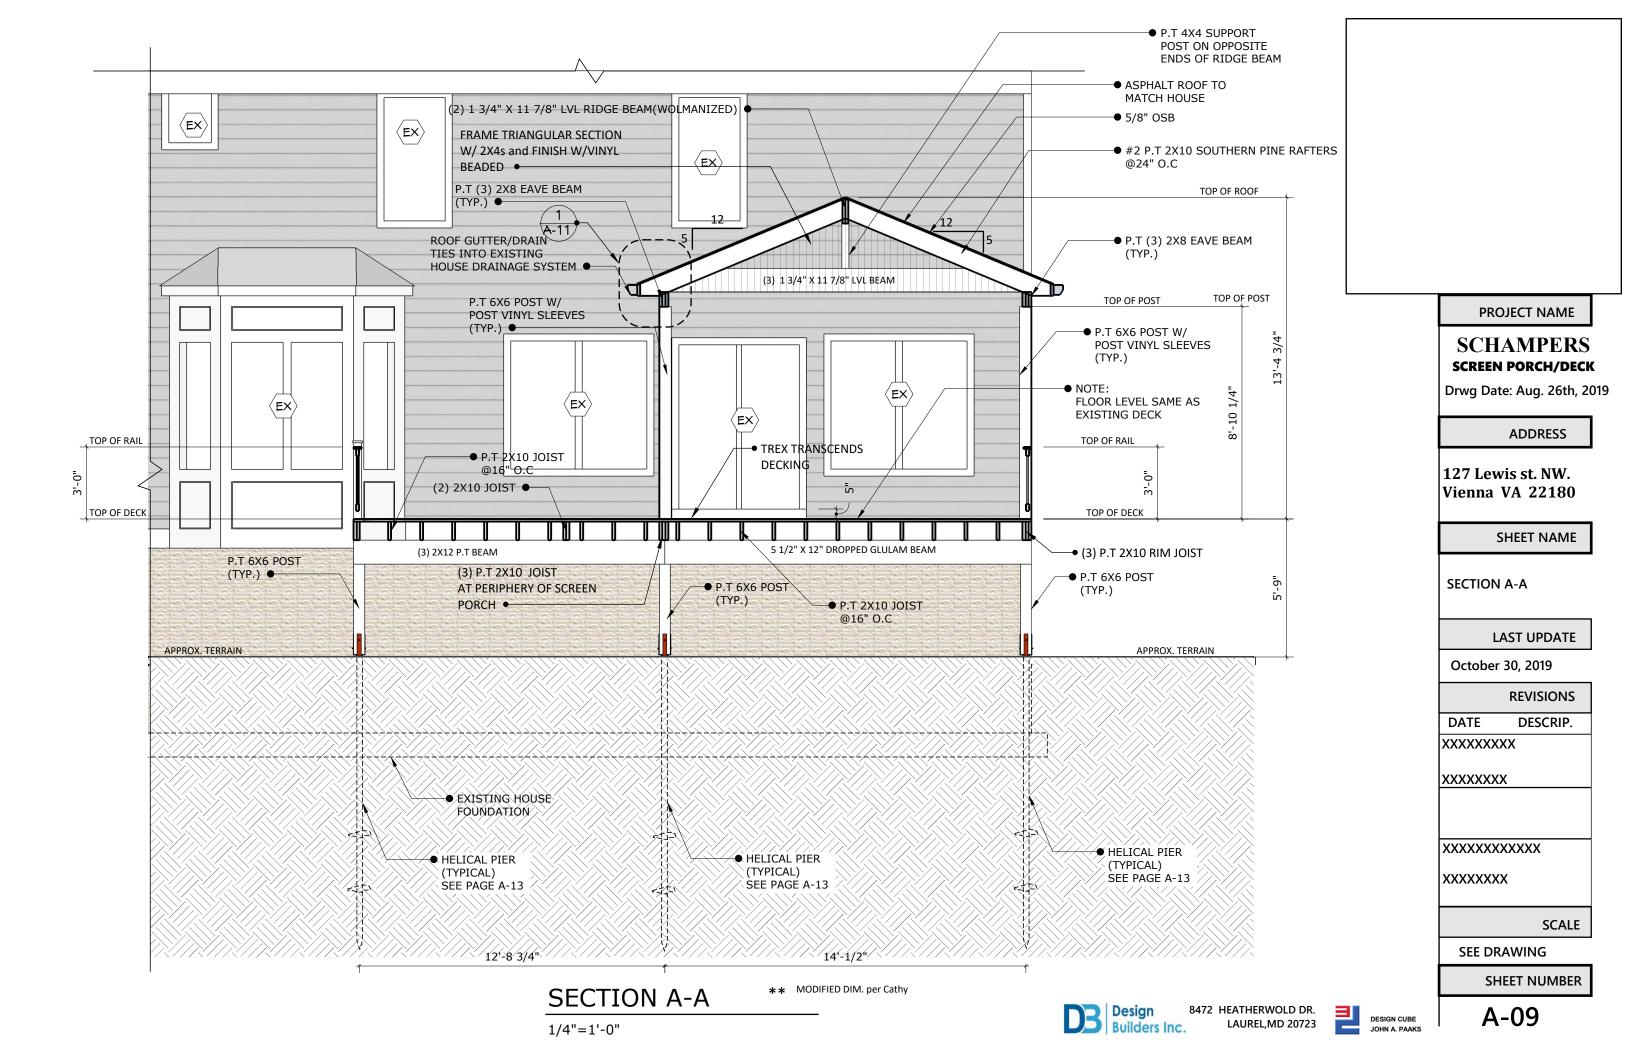
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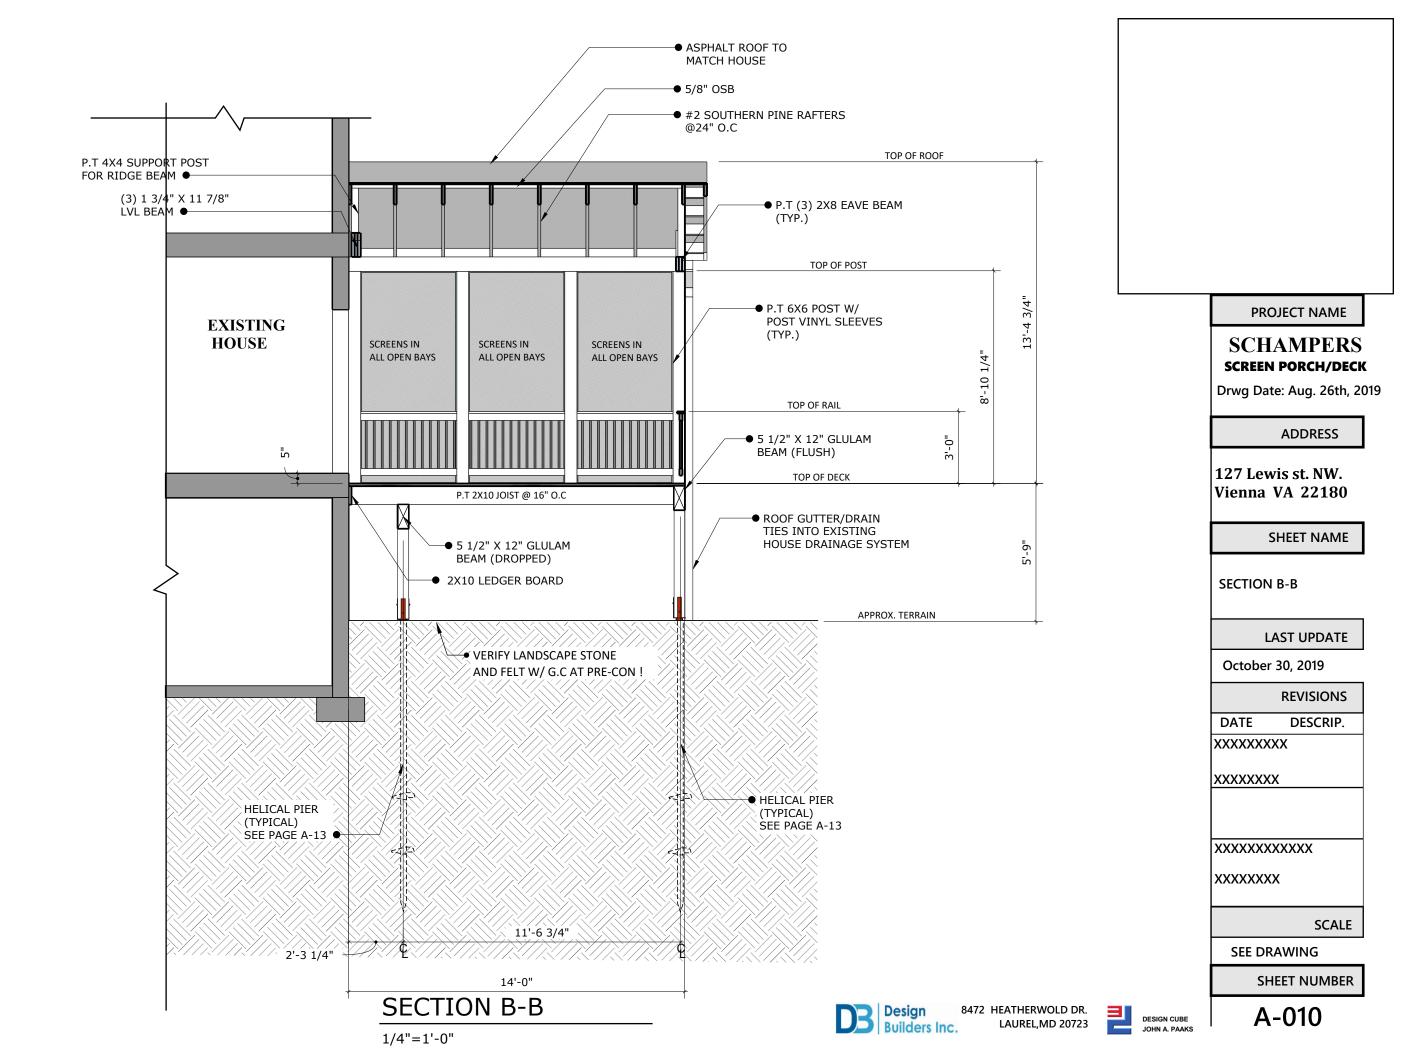
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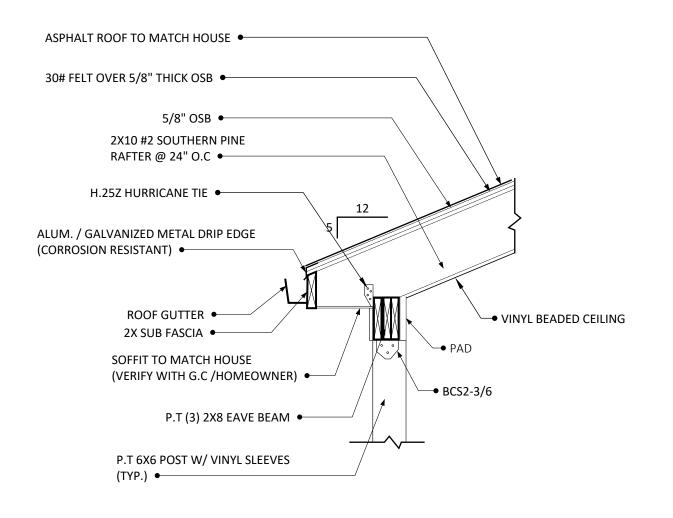
SCALE

A-08

SEE DRAWING







ROOF EAVE DETAIL

3/4"=1'-0"

-•2X STUD WALL

●SILL PLSTE

EXIST. FOUND. WALL

●EXIST. 2X BAND BOARD

●2X FLOOR JOIST

SIMPSON DTT2Z DECK TO HOUSE

MINIMUM OF THREE (3) LOCATIONS

LATERAL LOAD CONNECTION PER MANUF. SPEC.

SIDING

GALVANIZED METAL CONTINUOUS FLASHING BOTTOM SLOPED DOWN

2X LEDGER BOARD

DRIP EDGE

DECK JOIST






9

BC60

BC60 INSTALL

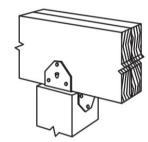

Typical BCS Installation (BC Similar)

Installation:


- . BCS: Install dome nails on beam; drive nails at an angle through the beam into the post below.
- · BC: Do not install bolts into pilot holes.


	Dimensions (in.)					Fasteners					
	Model No.	W1 W	W2	L1	L2	Н1	H2	Nails		SD Screws	
								Beam Flange	Post Flange	Beam Flange	Post Flange
\Box	BC4Z	3 9/16	3 9/16	2 7/8	2 7/8	3	3	6-16d	6-16d	6-SD #10x1½	6-SD #10x11/2
	BC6Z	5 1/2	5 1/2	4 3/8	4 3/8	3 3/8	3 3/8	12-16d	12-16d	1.5	-
\Box	BCS2-2/4Z	3 1/8	3 9/16	2 7/8	2 7/8	2 15/16	2 15/16	8-10d	6-10d	8-SD #9x21/2	6-SD #9x21/2
\Box	BCS2-3/6Z	4 5/8	5 9/16	4 3/8	2 7/8	3 5/16	2 15/16	12-16d	6-16d	IMI	1


1. D indicates connector is available in stainless steel. Replace Z in model numbe with SS when ordering.

2. Refer to current Wood Construction Connectors catalog for additional information.

BC, BCS Post Caps

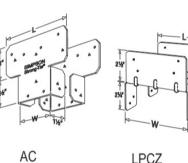

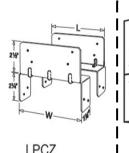

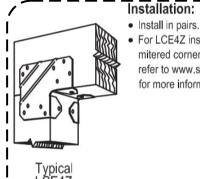

PROJECT NAME

SCHAMPERS SCREEN PORCH/DECK

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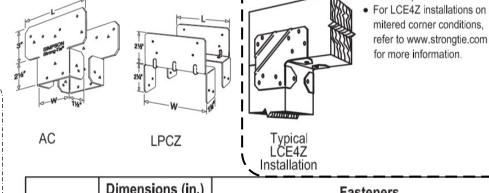
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SCALE

SEE DRAWING

SHEET NUMBER

A-011



		Dimension	ons (in.)	Fasteners					
	Model No.	w		Na	ails	SD Screws			
		VV	_	Beam	Post	Beam	Post		
\Box	AC4Z	3 9/16	6 1/2	14-16d	14-16d	14-SD #10x1½	14-SD #10x1½		
	AC6Z	5 1/2	8 1/2	14-16d	14-16d	14-SD #10x1½	14-SD #10x1½		
	LPC4Z	3 9/16	3 1/2	8-10d	8-10d	8-SD #9x1½	8-SD #9x1½		
	LPC6Z	5 9/16	5 1/2	8-10d	8-10d	-	-		
_	LCE4Z		5 3/8	14-16d	10-16d	14-SD #10x1½	10-SD #10x1½		

- 1. Dindicates connector is available in stainless steel. Replace Z in model number with SS when ordering.
- 2. Refer to current Wood Construction Connectors catalog for additional information.


C, LPC, LCE Post Caps


Builders Inc.

LAUREL,MD 20723





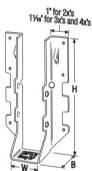

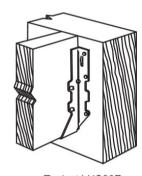

Installation:

- · LUS hangers install with double shear nailing.
- For installations into single 2x headers or ledgers, use the specified full length fasteners into the joist and the following fasteners into the header for reduced loads in accordance with www.strongtie.com:
- •• 10dx11/2 nails for installations with Nails
- •• SD #9x1½ for LUS28Z and LUS210Z installations with SD Screws
- •• SD #10x11/2 for LUS26-2Z and LUS210-2Z installations with SD Screws


Typical	LUS28Z
	lation

		Dir	nensions (i	n)	Fasteners				
	Model No.	Model No.		,	Nails		SD Screws		
		W	Н	В	Header	Joist	Header	Joist	
\Box	LUS26Z	1 9/16	4 3/4	1 3/4	4-10d	4-10d			
\Box	LUS28Z	1 9/16	6 5/8	1 3/4	6-10d	4-10d	6-SD #9x21/2	4-SD #9x21/2	
\Box	LUS210Z	1 9/16	7 13/16	1 3/4	8-10d	4-10d	8-SD #9x21/2	4-SD #9x21/2	
\Box	LUS26-2Z	3 1/8	4 7/8	2	4-16d	4-16d	4-SD #10x21/2	4-SD #10x21/2	
	LUS210-2Z	3 1/8	9	2	8-16d	6-16d	8-SD #10x2½	6-SD #10x2½	


- 1. indicates connector is available in stainless steel. Replace Z in model number
- 2. Refer to current Wood Construction Connectors catalog for additional information.

LUS Joist Hangers Typical H1Z H2.5Z and H2.5Z Installation Installation: · Use all specified fasteners. H₁Z **Fasteners** Model Nails **SD Screws** H8Z No. To Joist | To Beam To Joist To Beam 6-SD #9x11/2 4-SD #9x11/2 H1Z 6-8dx1½ 4-8dx1½ 5-SD #9x11/2 5-8dx1½ | 5-8dx1½ | 5-SD #9x1½ 5-10dx1½ | 5-10dx1½ | 5-SD #9x1½ | 5-SD #9x1½

- indicates connector is available in stainless steel. Replace Z in model number with SS when ordering.
- 2. Refer to current Wood Construction Connectors catalog for additional information.

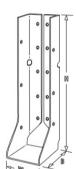

HUC210-4

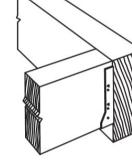

(LUC Similar)

Typical HUC Installation


Installation:

- For HUC installations, models have triangle and round holes. To achieve maximum loads, fill both round and triangle holes (fastener quantities listed fill both holes).
- For installations into single 2x headers or ledgers, use the specified full length fasteners into the joist and the following fasteners into the header for reduced loads in accordance with www.strongtie.com:
- 10dx11/2 nails for installations with Nails
- •• SD #9x1½ for LUC26Z and LUC210Z installations with SD Screws

		Dimensions (in.)			Fasteners				
	Model No.				N	ails	SD Screws		
		W	Н	В	Header	Joist	Header	Joist	
\Box	LUC26Z	1 9/16	4 3/4	1 3/4	6-10d	4-10dx1½	6-SD #9x21/2	4-SD #9x11/2	
	LUC210Z	1 9/16	7 3/4	1 3/4	10-10d	6-10dx1½	10-SD #9x21/2	6-SD #9x11/2	
	HUC26-2Z	3 1/8	5 3/8	2 1/2	12-16d	6-10d	-	-	
\Box	HUC28-2Z	3 1/8	7	2 1/2	14-16d	6 - 10d	•	¥	
	HUC210-2Z	3 1/8	8 13/16	2 1/2	18-16d	10-10d	-	-	

- 1. indicates connector is available in stainless steel. Replace Z in model number with SS when ordering.
- 2. Refer to current Wood Construction Connectors catalog for additional information.

LUC, HUC Joist Hangers

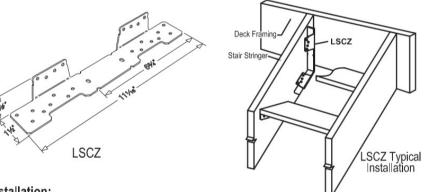

Installation:

- Before fastening, position the stair stringer with the LSCZ on the carrying member to verify where the bend should be located.
- Tabs on the LSCZ must be positioned to the inside of the stairs.
- The fastener that is installed into the bottom edge of the stringer must go into the second-to-last hole.
- A minimum distance of ¾" measured from the lowest rim-joist fastener to the edge of rim joist is required.

	Model No.	Fasteners								
			Nails		SD Screws					
		Rim Joist	Stringer Wide Face	Stringer Narrow Face	Rim Joist	Stringer Wide Face	Stringer Narrow Face			
>	LSCZ	8-10dx1½	8-10dx1½	1-10dx1½	8-SD #9x1½	8-SD #9x11/2	1-SD #9x11/2			

- 1. indicates connector is available in stainless steel. Replace Z in model number with SS when ordering. Stainless steel models must be fastened with nails.
- 2. Refer to current Wood Construction Connectors catalog for additional information.

LSC Stair Stringer Connector





PROJECT NAME

SCHAMPERS SCREEN PORCH/DECK

Drwg Date: Aug. 26th, 2019

ADDRESS

127 Lewis st. NW. Vienna VA 22180

SHEET NAME

CONSTRUCTION DETAILS

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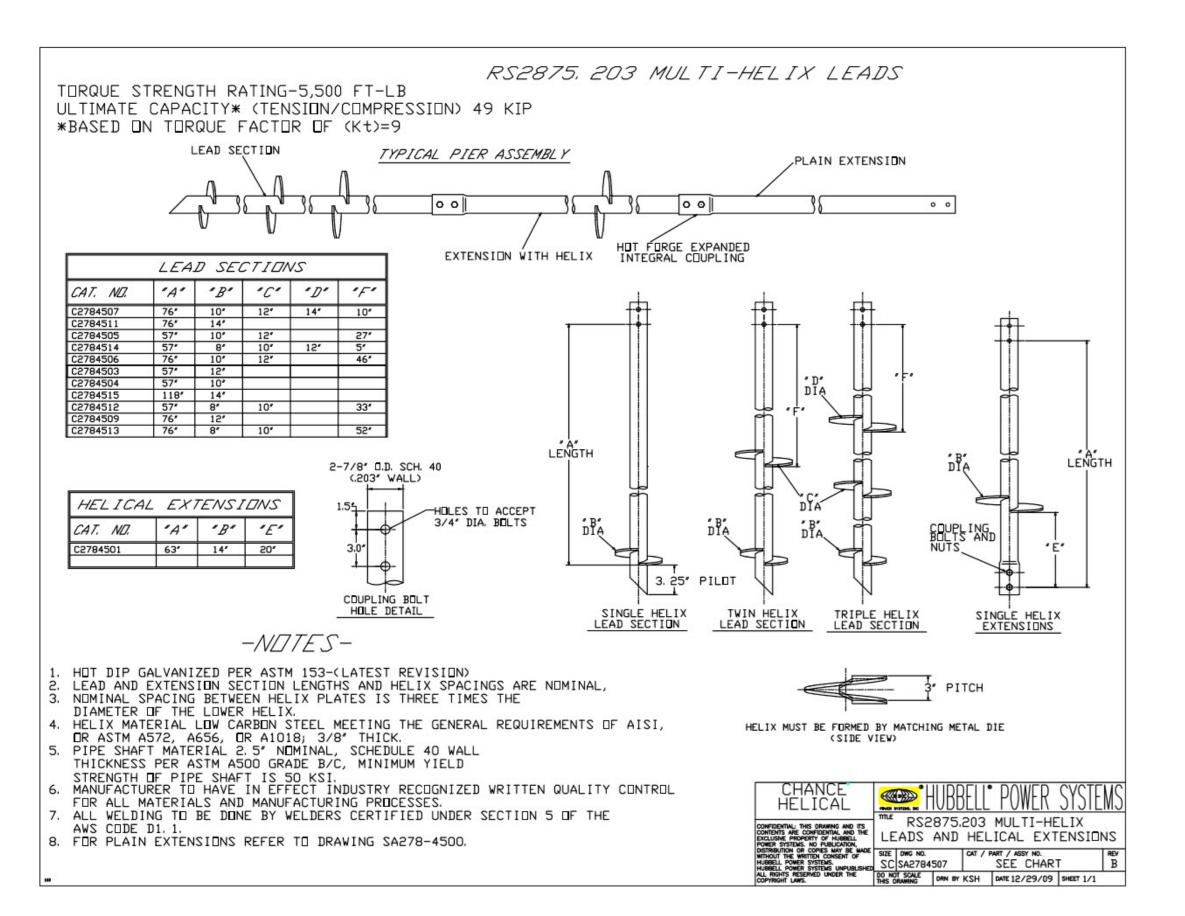
SEE DRAWING

A-012

SHEET NUMBER



Builders Inc.



PROJECT NAME

SCHAMPERS SCREEN PORCH/DECK

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| HELICAL PIER DETAILS

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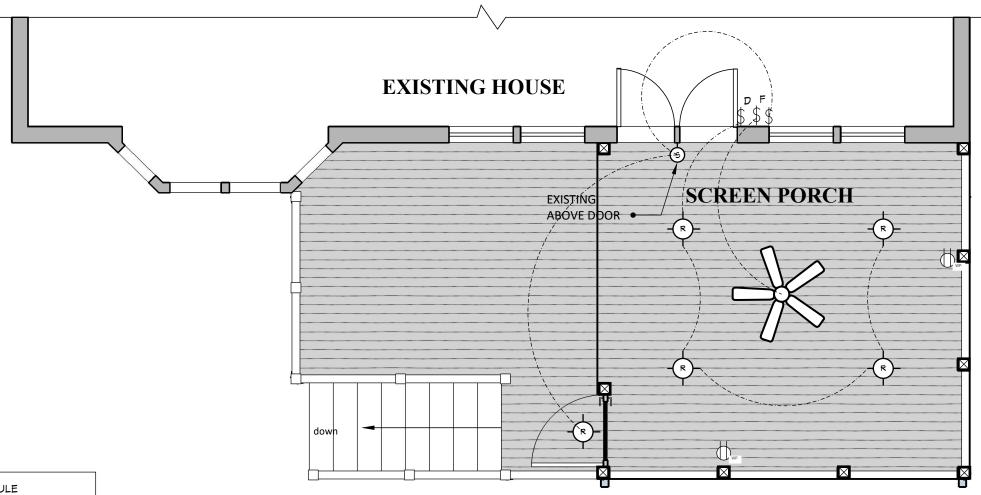
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Design 8472 HEATHERWOLD DR.
Builders Inc. LAUREL,MD 20723





FIELD VERIFY FINAL LOCATIONS OF ALL ELECTRICAL ELEMENTS WITH G.C / HOME OWNER BEFORE FINAL INSTALLATION!!



ELECTRICAL SCHEDULE								
ELECTRICAL	COUNT	SYMB <i>O</i> L						
Ceiling Fan 5 Blade	1	×						
Recessed Lights	5	-R-						
Outlet MP	2	DWP						

ELECTRICAL PLAN

1/4"=1'-0"

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ELECTRICAL PLAN

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